RENOVATIONS TOJOHN GREENE SCHOOL FOR WARWICK PUBLIC SCHOOLS

Warwick

PUBLIC SCHOOLS



8



ARCHITECTS

SACCOCCIO & ASSOCIATES, INC.

1085 PARK AVENUE CRANSTON, RI 02910

WARWICK PUBLIC SCHOOL BID NUMBER: 24-0017

BUILDING ENGINEERING RESOURCES, INC. MECHANICAL, PLUMBING AND FIRE PROTECTION ENGINEERS BUILDING ENGINEERING RESOURCES, INC. ELECTRICAL ENGINEERS

ISSUED FOR BID 04.22.2024

ABBREVIATIONS

Αt

Air Conditioning

a

A/C

ACT

ALT.

A.P.

BD.

BIT.

BM.

B.M.

BOT.

C

CFM

C.I.

C.J.

CPT.

CSK.

C.T.

CU

C.W.

D.F.

D.H.

DIA.

DIM.

DN

D.P.

DR.

DTL.

EA.

ΕC

EJ.

EL.

EML

E.P.

EQP.

EWB EWC

EWΗ

EXP.

EXT.

F.A.

FB

FC

F.C.U.

FDN.

FEC

FIN.

FOC FOF

FOM

FOS

FRCP

FT (')

FTG.

GA.

G.B. G.C.

GL. GRN.

GWB.

HC

H.M.

H.P.

HR.

H.S.

HTR.

HVAC

H.W.

I.D.

IN.(")

INCL.

INSUL

INT.

INV.

JAN.

LAM.

LAV.

LB.(*)

L.M.F.

LT.WT. LVR.

L.P.

JT.

ΗŤ

GYP.BD.

GALV.

FR

FL. FLUOR.

F.D.

Acoustical Tile A.D. A.F.F. Area Drain Above Finish Floor Alternate ALUM. Aluminum Access Panel APPROX. Approximately ARCH. Architect(ural) Board BBD. Bulletin board Bituminous BLDG. Building BLK. Block BLKBD. Blackboard BLKNG. Blocking Beam Bench Mark Bottom BRKT. Bracket BSMT. Basement BETWEEN. Between Center Line CAB. Cabinet C.B.U. Cinder Block Unit C.B. Catch Basin or Chalkboard CEM. Cement/Cementitious CFB Cement Fiber Board Cubic Feet per Minute Caste Ir*o*n Control Joint CLG. Ceiling CLOS. CMU Closet Concrete Masonry Unit C.O. COL. COMP. Clean Out Column Composition CONC. Concrete CONST Construction CONT. Continuous CONTR. Contractor CORR. Corridor Carpet Countersink Ceramic Tile Copper Cold Water Drinking Fountain Double Hung Diameter Dimension Down Damproofing Door Detail DWG. Drawinq East Each Electrical Cabinet Expansion Joint Elevation(Grade) ELEC. Electrical ELEV. Elevation (Facade) Expanded Metal Lath ENCL. Enclosure Electrical Panelboard EQ, Equal Equipment Electric White Board Electric Water Cooler Electric Water Heater EXC. Excavated EXIST Existing Exposed Exterior Fire Alarm Fiber Board Fire Code

Fancoil unit Floor Drain Foundation Fire Extinguisher Cabinet Finish or Finished Floor Fluorescent Face of Concrete Face of Finish Face of Masonry Face of Stud Fire Rated Feet or Foot Fiber Reinforced Cement Board Footing Gauge Galvanized Gypsum Board General Contractor Glass Granite Gypsum Wall Board Gypsum Board Hose Cabinet Hollow metal Handicapped Person (Handicapped Accessible) Hour Hook Strip Height Heater

Heating, Ventilating, Air Conditioning Hot Water Inside Diameter Inches or Inch Including or Included

Interior Invert Janitor Closet Joint

Insulation

Laminated Lavatory Pound Light Gauge Metal Framing Low Point Light Weight Louver

Millwork North Non-Corrosive Northeast Not in Contract NO.(#) Number Nominal Not to Scale Northwest Overall On Center Outside Diameter Opposite Hand OPNG. Opening OPP. Opposite Ounce Penny Pieces/Piece PCS. LB.(*) Pound Plate PTN. Partition PERIM. Perímeter Plastic Laminate PL.LAM. PLAS. Plastic/Plaster PLYWD. P.M.J.F. Plywood PreMolded Joint Filler POL. Polished Pair

Machine

Masonry

Maximum

Mechanical

Manufacturer

Miscellaneous

Masonry Opening

Moisture Resistant

Motorized Projection Screen

Membrane

Man Hole

Minimum

Metal

MACH.

MAS.

MAX.

MECH.

MEMB.

MFR.

M.H.

MIN. MISC.

M.O.

M.R.

MTL.

MWK.

N.

N.C.

NIC

NOM.

NTS

0.A. 0.C.

O.D.

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ΡL

PR.

PSI PT. PTD.

PVC

QTY.

R

R.A.

R.B.

R.D.

REFG.

REINF.

REQD.

RESIL

RG

RM.

RND

R.O.

ROW

S.C.

SE

SECT.

SHT.

SIM.

SLNT.

SPECS

S.P.

SQ. SS. ST.

STD.

STL. STOR.

SUSP.

ട്ഡ

SYM.

T≰G

T.B.

THK.

THR.

THRU TLT. TOC

TOS.

TYP.

U.L.

V.

VAR.

V.B.

VCT

VERT.

VEST.

V.I.F.

VOL.

V.T. VTR

VWC

ω/

WΒ

WCL

WC WD,

WDW

W.H.

W/0

WP.

WT.

W.W.G.

W.W.M.

WPM

W.I.

WCL-A

TEMP.

STRUCT

SF

SCHED.

RAD.

NΨ

ΝE

M.P.S.

PROJ.SCR. Projection Screen Pound(s) per Sauare Inch Paínt Painted Poly Vinyl Chloride Quantity

> Riser Return Aír Radius Rubber Base Roof Drain Refrigerator Reinforced Required Resilíant Reinforced Gypsum Room Round Rough Opening Right of Way

Sealant South Solid Core Schedule Southeast Section Square Feet Sheet Similar Sealant Standpipe SPECS Square Stainless Steel Street Standard Steel Storage Structural Suspended Southwest Symmetrical Tread

Tongue & Groove Tackboard Temperature/Tempered Thickness/Thick Threshold Through Toilet Top of Concrete Top of Steel Typical

Veneer Varies Vinyl Base Vinyl Compostion Tile Vertical or Vertically Vestibule Verify in Field Volume Vinyl Tile Vent through Roof Vinyl Wall Čovering

Underwriters Laboratory

West With White Board Water Cooler Water Cooler - Accessible Water Closet Wood Window Wall Hung Wrought Iron Without Waterproofing Waterproofing Membrane Weight Woven Wire Grille Welded Wire Mesh

MATERIALS IN SECTIO	DN S	STMBOLS						
EARTH	X100	ROOM NUMBER	AG1.0 LEGEND, CODE AG1.1 GENERAL NOTE REQUIREMENTS					
	2 (A2.1)	DETAIL REFERENCE						
BRICK	2 A2.1	WALL SECTION REFERENCE						
CONCRETE MASONRY UNITS (CMU)		INTERIOR PARTITION TYPE. SEE WALL TYPE SHEET FOR MORE INFORMATION	AD.11st FLOOR EXISA1.11st FLOOR PROA2.0ENTRY & VESTINA2.1ENTRY & VESTINA2.2ENLARGED FLO					
RIGID INSULATION		EXTERIOR ELEVATION REFERENCE	A2.2 ENLARGED FLC A2.3 GIRLS TOILET F A2.4 BOYS TOILET F A2.5 GIRLS TOILET F A2.6 BOYS TOILET F					
BLANKET INSULATION	- <u></u> - <u></u> - <u></u> - <u></u> - <u></u> - <u></u> - <u></u>	INTERIOR ELEVATION REFERENCE	A2.7 STAFF TOILET F ELEVATION A3.0 DOOR TYPES 4 A3.1 FRAME DETAILS					
PLYWOOD		DOOR NUMBER	A3.2 WINDOW TYPES					
ROUGH WOOD	00	WINDOW NUMBER						
DRYWALL		TRANGLUCENT PANEL NUMBER	<u>PLUMBING</u> PØ.1 PLUMBING LEGEND					
METAL (LARGE SCALE)	00	VISION PANEL SYMBOL NUMBER	PO.2 PLUMBING OVERALL PD1.0 PLUMBING & HV P1.0 PLUMBING & HVAC F P2.0 PLUMBING & HVAC E					
			FIRE PROTECTION FAILI FIRE ALARM AND PO					

CODE INFORMATION

- CODE LIST:
- SBC 1 2021 with Amendments)
- ICC / ANSI A117.1 2009 Edition
- 2010 ADA STANDARDS

PROJECT DESCRIPTION

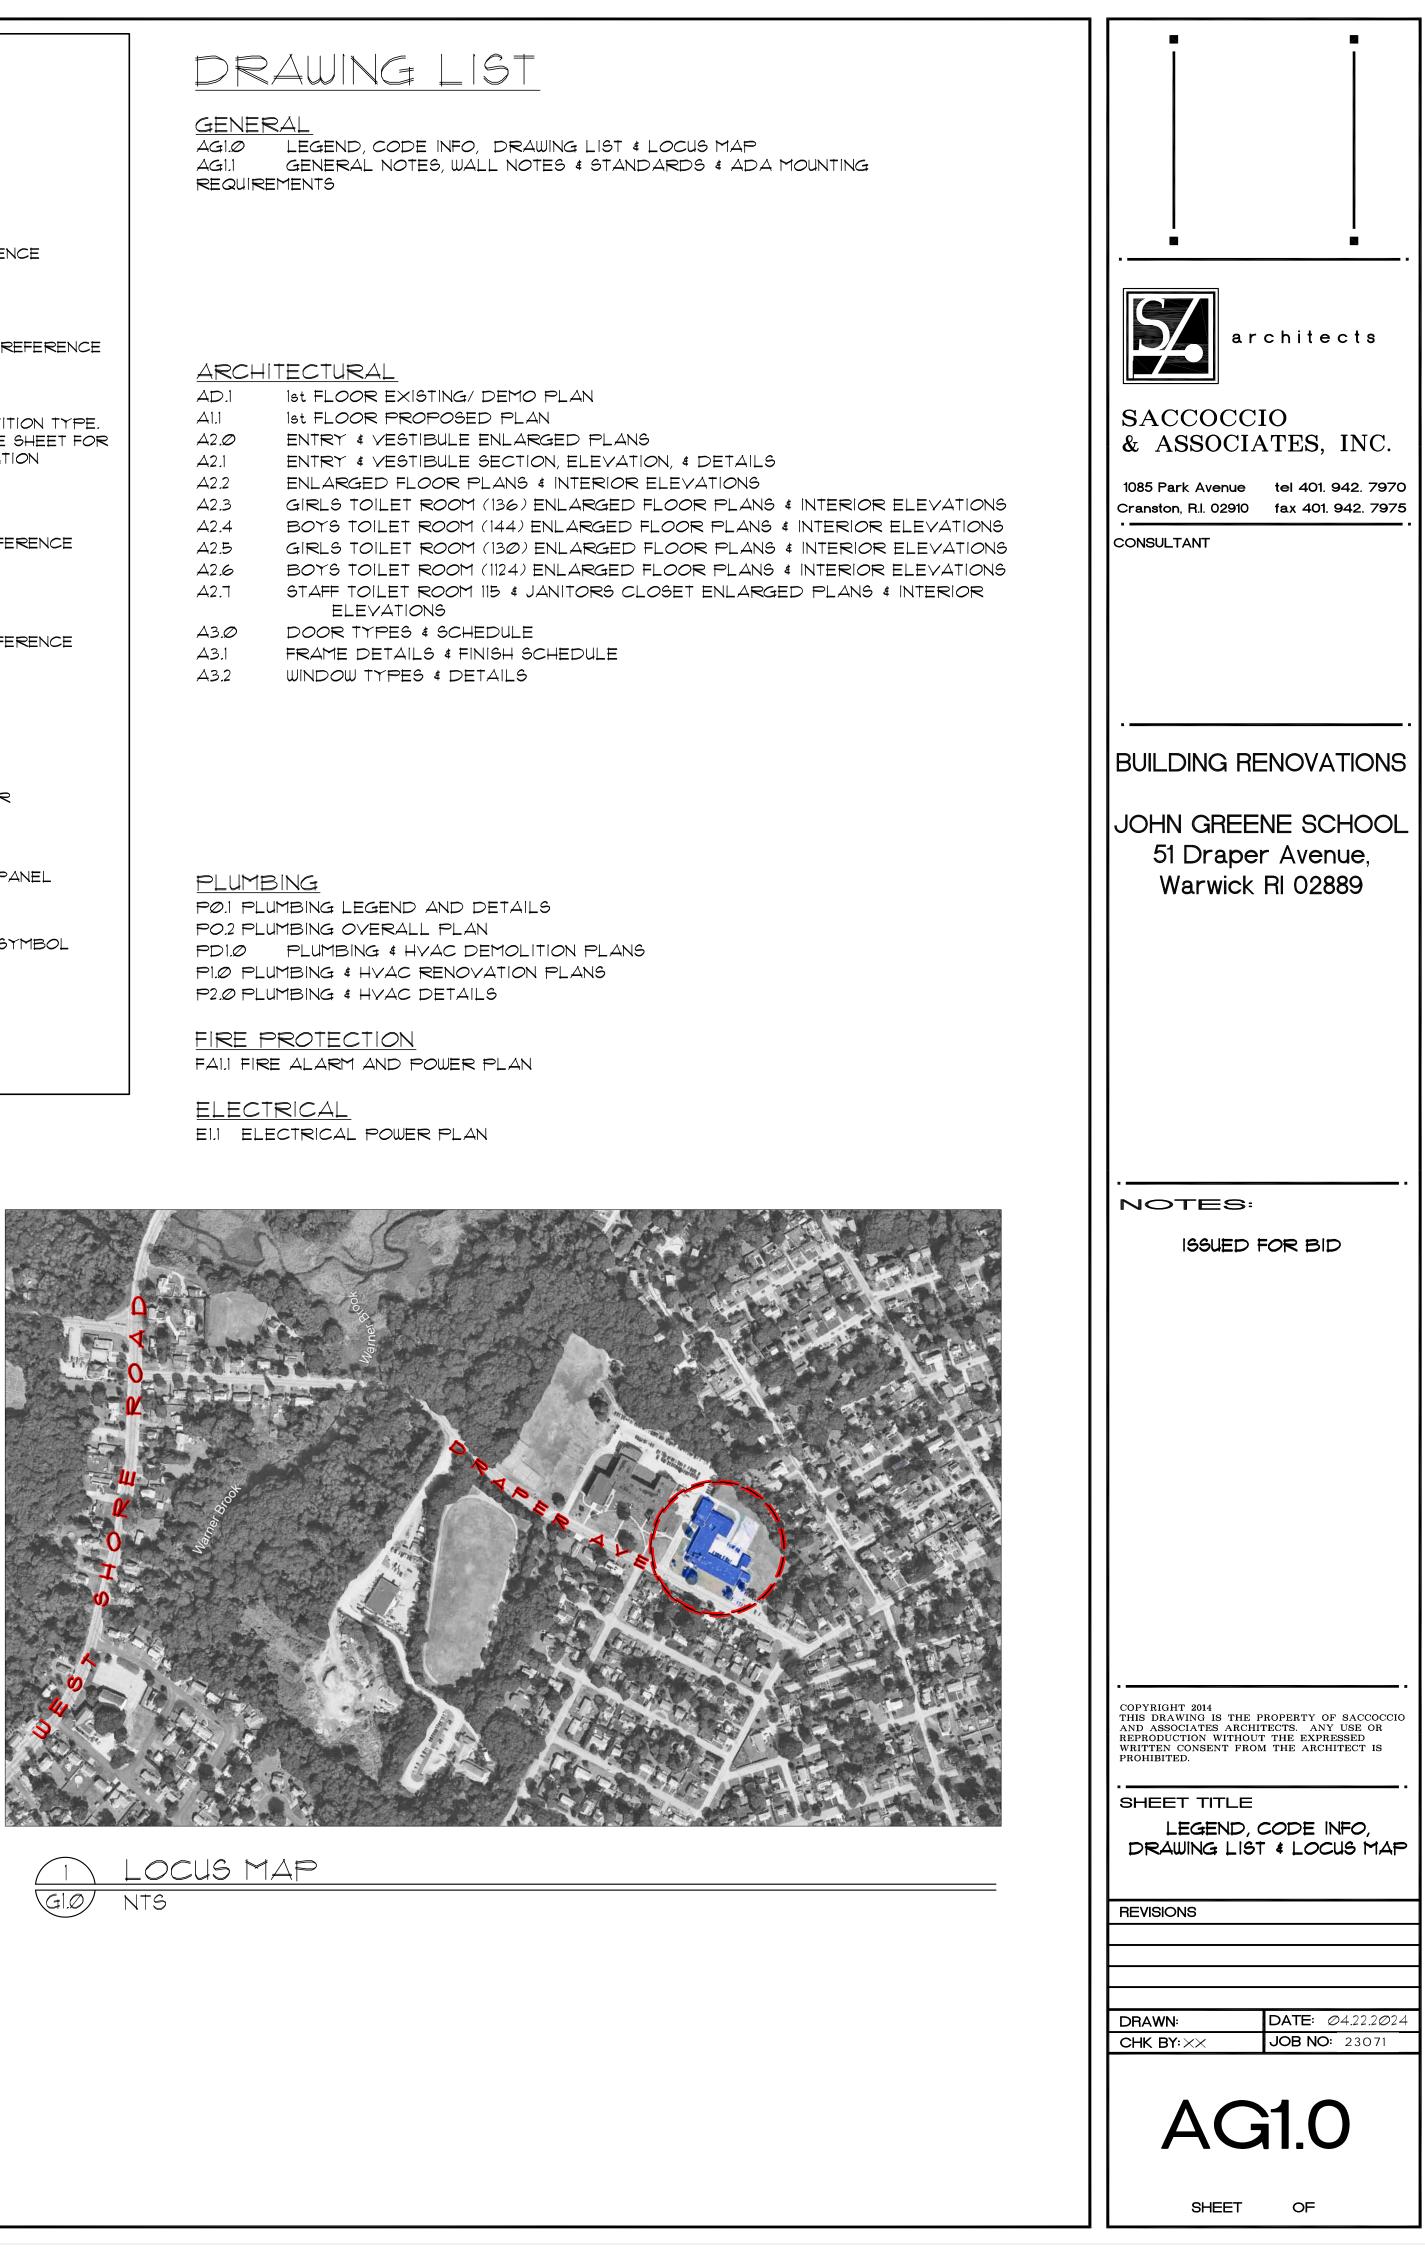
- several classrooms
- Fire rating existing recessed display cases.
- Fire alarm upgrades.
- Modification of current classroom windows to accommodate single rescue window.

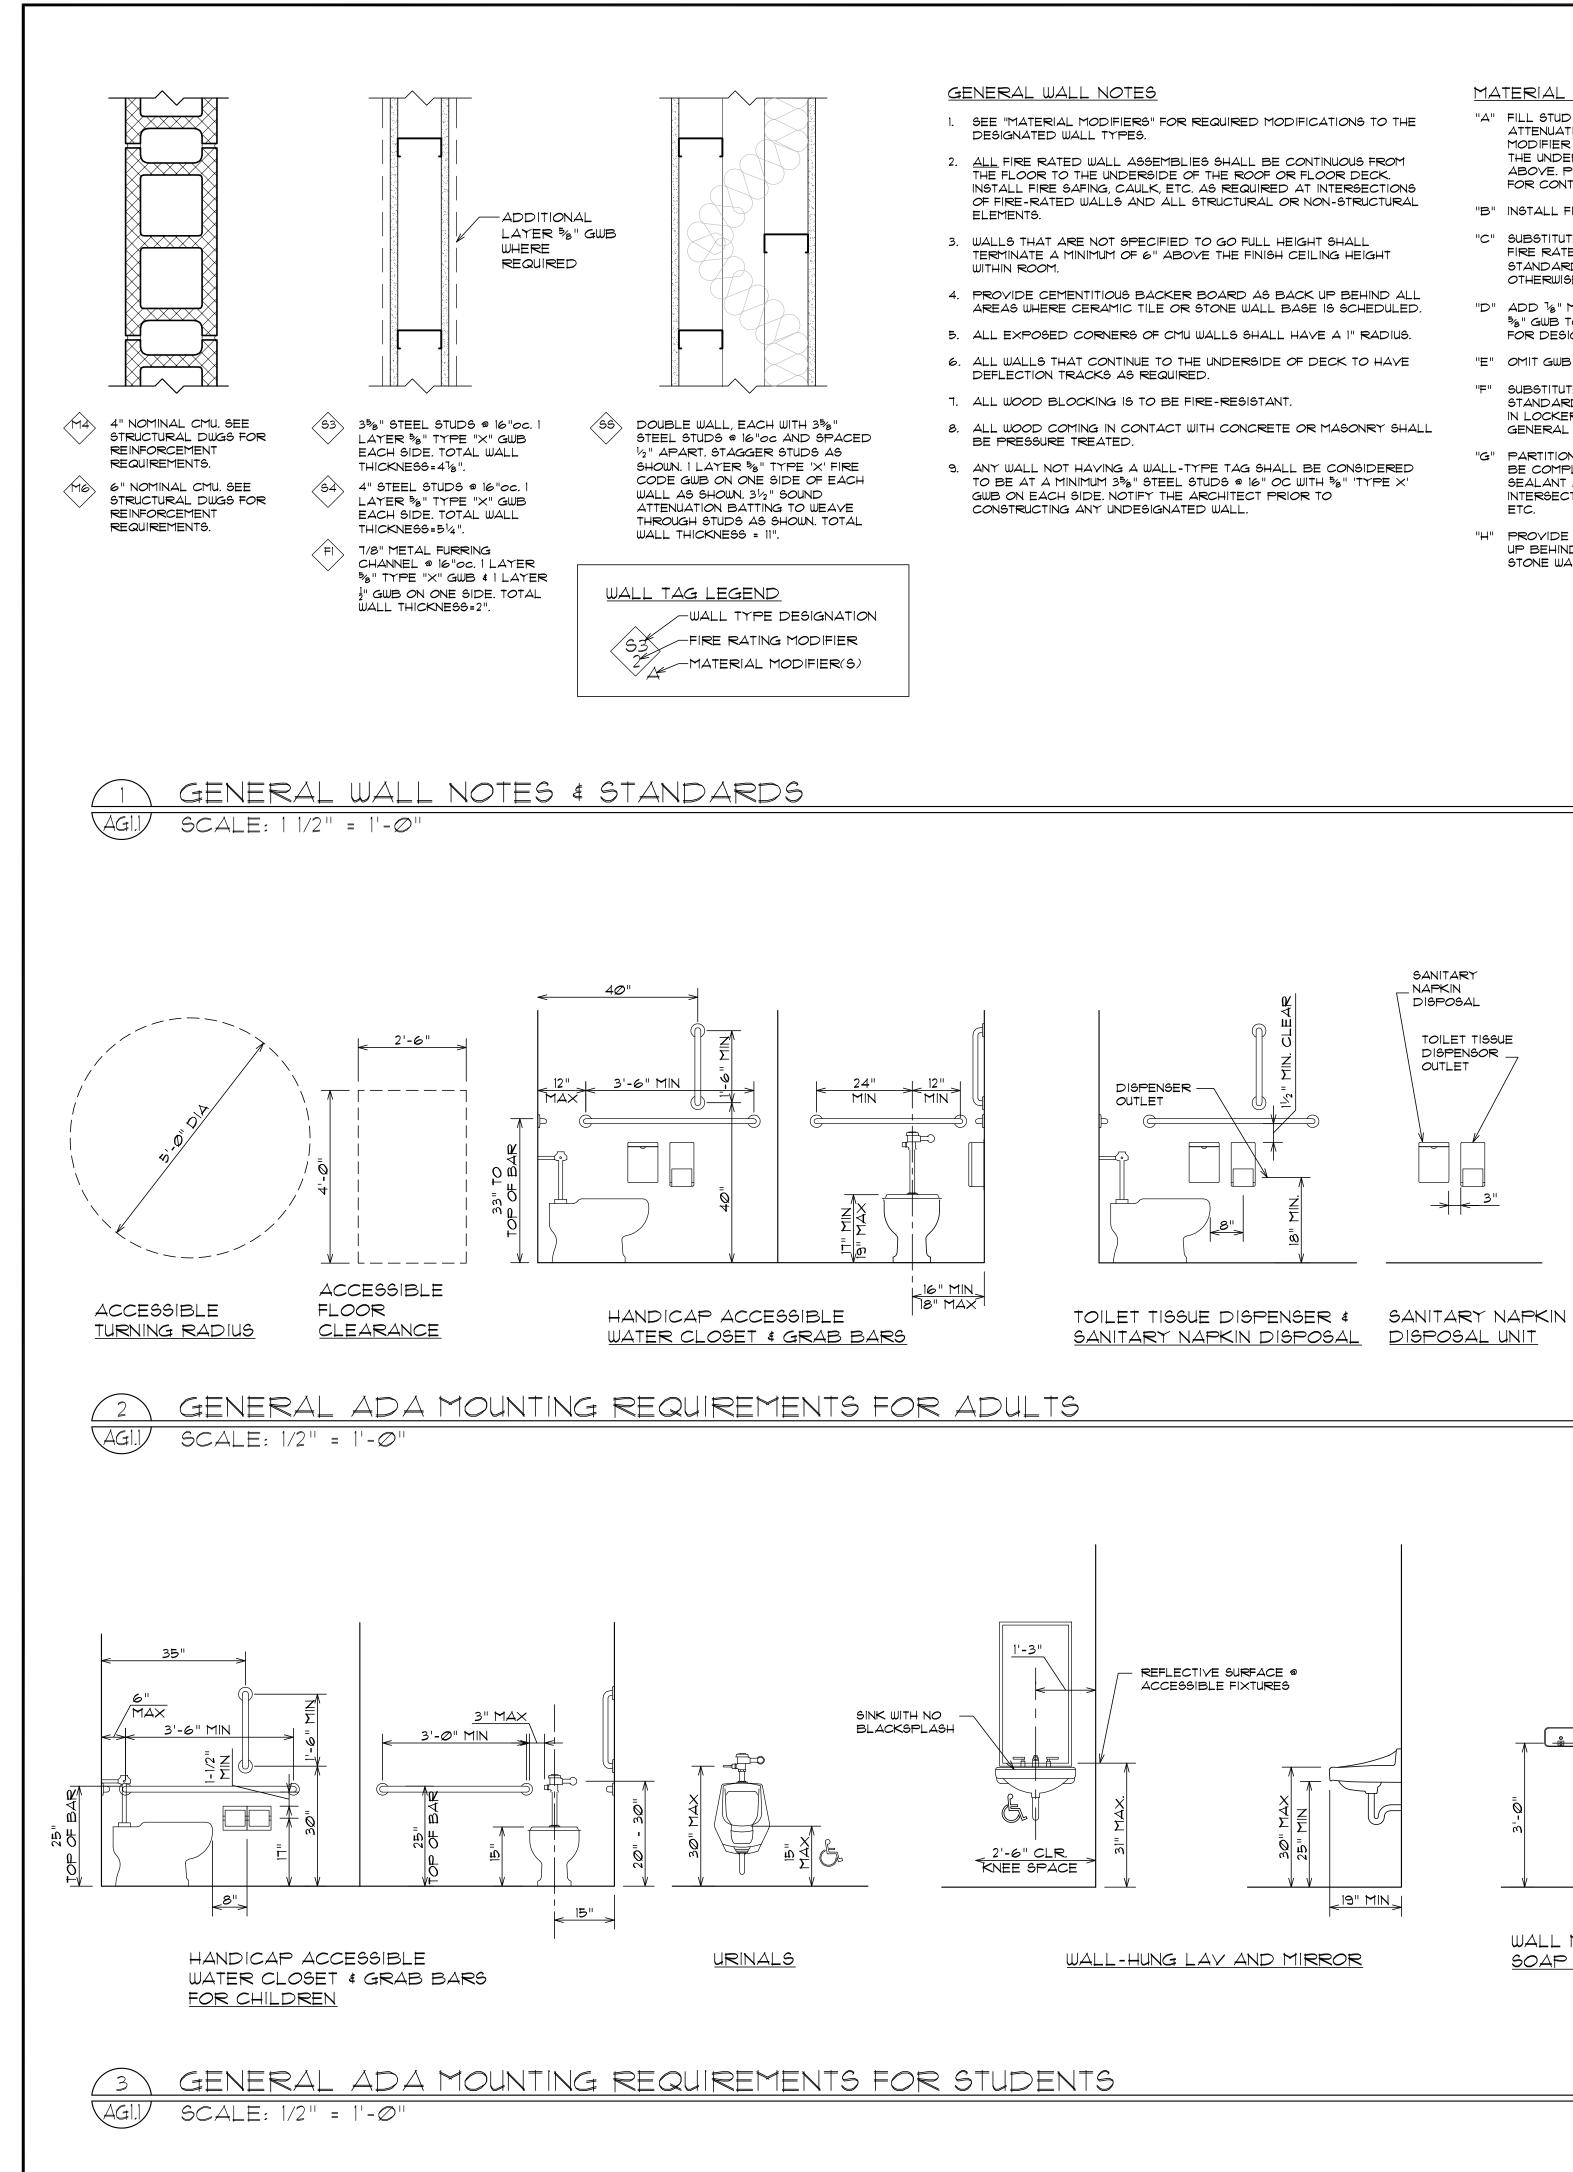
• International Building Code (2018 Edition) along with the Rhode Island State Building Code

• Rhode Island Fire Safety Code NFPA 1 - (2018 edition) with 2021 amendments 2018 International Energy Conservation Code - 2021 with RI Amendments SBC-8: Climate Zone 5
The Rhode Island Life Safety Code NFPA 101 - (2018 edition) with 2021 amendments

ADA Upgrades to an existing one story mixed use elementary school/ secondary school which include several ADA compliant student toilet rooms & auto door operators to be installed at

Replacement of several paired entry doors with overlapping astragals to meet fire code.
Replacement of main entry doors to vestibule 4 exterior to meet code egress dimensions.





- MATERIAL MODIFIERS
- "A" FILL STUD CAVITY FULL HEIGHT WITH SOUND ATTENUATION BATTING. WALL ASSEMBLIES HAVING THIS MODIFIER SHALL BE CONTINUOUS FROM THE FLOOR TO THE UNDERSIDE OF THE ROOF OR FLOOR DECK ABOVE. PROVIDE CAULKING/SEALANT AS REQUIRED FOR CONTINUOUS MEMBRANE.
- "B" INSTALL FIBERGLASS THERMAL INSULATION.
- "C" SUBSTITUTE 5%" ABUSE RESISTANT GWB (ALSO TO BE FIRE RATED WHERE DESIGNATED AS SUCH) IN LIEU OF STANDARD 5/8" GWB ON BOTH SIDES UNLESS NOTED OTHERWISE ..
- "D" ADD 3/8" METAL FURRING VERTICALLY @ 16" OC AND $\frac{5}{3}$ " GWB TO DESIGNATED SIDE OF WALL. SEE PLANS FOR DESIGNATION.
- "E" OMIT GWB ON ONE SIDE.
- "F" SUBSTITUTE 5/8" MOISTURE RESISTANT GWB IN LIEU OF STANDARD GWB TO MOISTURE PRONE SIDE OF WALL/S IN LOCKER ROOMS, TOILET ROOMS, ETC. ALSO, SEE GENERAL NOTE #4.
- "G" PARTITION TO BE A SMOKE ENCLOSURE AND SHALL BE COMPLETELY SEALED WITH AN APPROVED SEALANT AT ENTIRE PERIMETER INCLUDING THE INTERSECTIONS OF ALL WALLS, FLOOR/ROOF DECKS, ETC.
- "H" PROVIDE CEMENTITIOUS BACKER BOARD AS BACK UP BEHIND ALL AREAS WHERE CERAMIC TILE AND/OR STONE WALL BASE IS SCHEDULED.

GENERAL NOTES

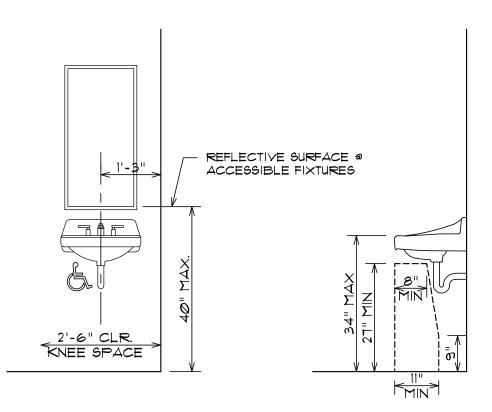
AS "FURNISH AND INSTALL".

THE CONTRACTOR/S SHALL 1. UNDERSTAND THAT THE TERM "PROVI

- 2. VIGIT THE JOB SITE AND FAMILIARIZE CALLED FOR ON THE DRAWINGS AND WILL BE CONSIDERED THAT WOULD H
- 3. UNDERSTAND THAT THE TERM "MATCH PERFORMED MUST BE OF SIMILAR MA RESPECTS.
- 4. BE RESPONSIBLE FOR ALL CUTTING, AS REQUIRED FOR THE INSTALLATION BUILDING. (VERIFY ALL CONDITIONS .
- 5. PATCH AND REPAIR ALL WALLS, FLOO BE PERFORMED MUST BE OF SIMILAR RESPECTS.
- 6. SHALL COORDINATE ALL MECHANICA TO PROCEEDING WITH THE NEW WORK
- 1. PROVIDE DUST PARTITIONS AS REQU CONTRACTOR WILL BE RESPONSIBLE
- 8. BE RESPONSIBLE FOR CLEANING THE REMOVED FROM THE BUILDING.
- 9. BE RESPONSIBLE TO SUBMIT M.E.P. CO SYSTEMS TO AVOID CONFLICTS AND
- 10. REPLACE OR REPAIR ANY DISTURBE

NAPKIN DISPOSAL TOILET TISSUE DISPENSOR _ OUTLET

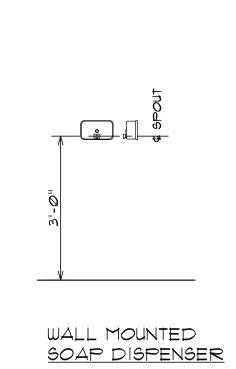
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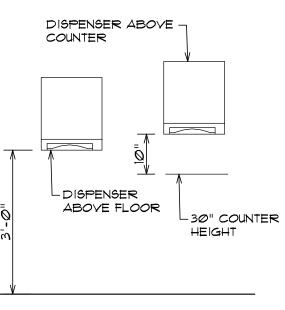




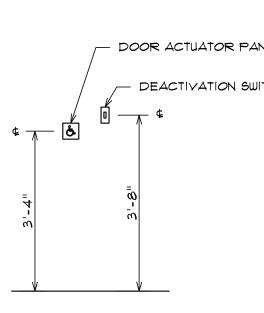








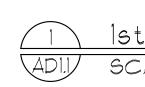
PAPER TOWEL <u>DISPENSER</u>



DOOR ACTUATOR & DEACTIVATION SWITCH

	IGHOUT THESE CONSTRUCTION DOCL	MENTA GUALL BE DEEINED	
HIMSELF COMPLETEL	Y WITH ALL EXISTING CONDITIONS F	RELATIVE TO THE NEW WORK	
HAVE BEEN DETERMIN H EXISTING" AS LISTED	BATION FOR EXTRA WORK ON BEHAU ED BY VIGUAL OBSERVATION PRIO D ON THESE DRAWINGS SHALL MEAN	R TO BIDDING. I THAT ALL WORK TO BE	
FILLING, PATCHING AN N OF ALL NEW MECHAN	ION AND FINISHED TO THE LINES OF ID/OR REPAIRING OF EXISTING WALI NICAL, ELECTRICAL AND PLUMBING	_S, FLOORS AND CEILINGS	architects
	N ALL AREAS AFFECTED BY DEMOL UCTION AND FINISHED TO THE LINES		
AL, ELECTRICAL AND T IN ALL AREAG.	PLUMBING WORK WITH THE ARCHITED	CTURAL DRAWINGS PRIOR	& ASSOCIATES, INC.
IIRED TO KEEP AREA: FOR CLEANING ANY	3 OUTSIDE OF SCOPE FREE OF DIRT AREAS LEFT UNPROTECTED. END OF EACH WORK DAY, ALL TR		1085 Park Avenue tel 401. 942. 7970 Cranston, R.I. 02910 fax 401. 942. 7975
OORDINATION DRAWIN COORDINATE LOCATI	NGS TO THE ARCHITECT FOR REVIEW ONS OF ALL DEVICES AND LIGHTING ISIDE THE WORK LIMITS AREA.	JOF LOCATIONS OF ALL	CONSULTANT
			BUILDING RENOVATIONS
			JOHN GREENE SCHOOL 51 Draper Avenue, Warwick RI 02889
₽ ₽ ₽ ₽ ₽ ₽ ₽ ₽ ₽			
	DISPENSER / HAND DRYER	- - -	 Notes:
		V V	GENERAL MOUNTING HEIGHTS & GENERAL NOTES
MOUNTED DISPENSER	PAPER TOWEL DISPENSER / <u>HAND DRYER</u>	<u>ROBE HOOK</u>	
ANEL			
WITCH			COPYRIGHT 2014 THIS DRAWING IS THE PROPERTY OF SACCOCCIO AND ASSOCIATES ARCHITECTS. ANY USE OR REPRODUCTION WITHOUT THE EXPRESSED
			WRITTEN CONSENT FROM THE ARCHITECT IS PROHIBITED. SHEET TITLE
			GENERAL NOTES, WALL NOTES & STANDARDS & ADA
			MOUNTING REQUIREMENTS REVISIONS
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			DRAWN: DATE: Ø4.22.2Ø24 CHK BY: XX JOB NO: 23071
			AG1.1
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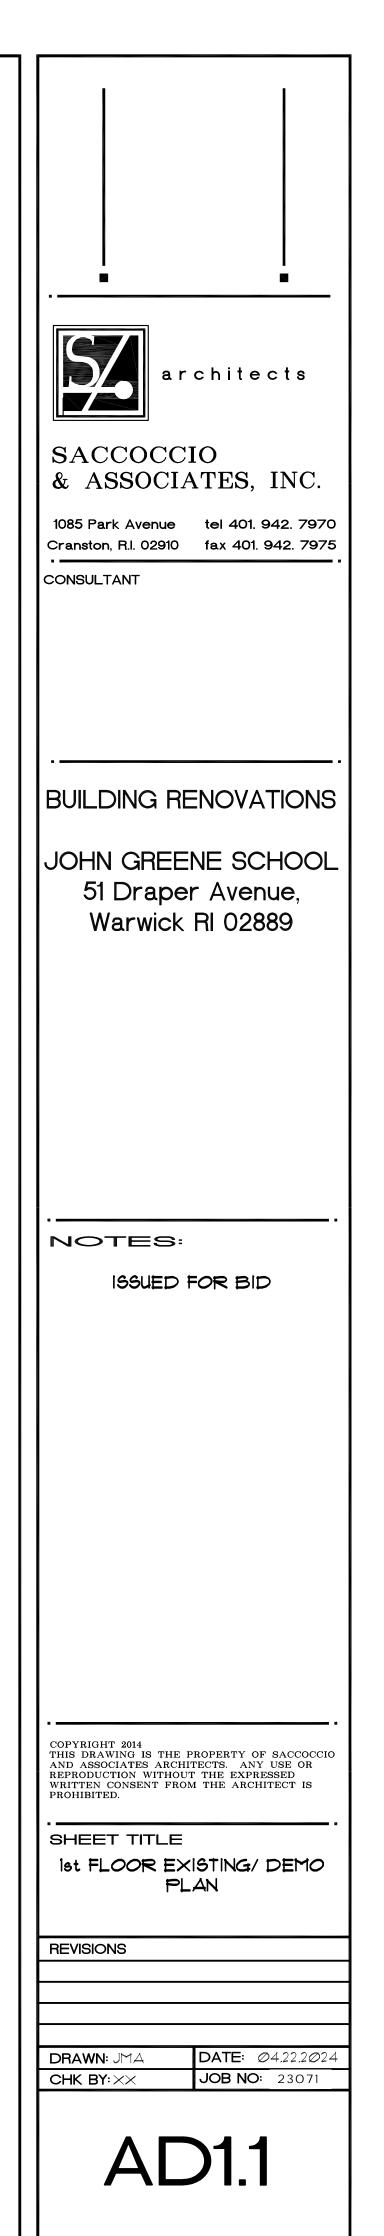
1st FLOOR EXISTING/ DEMO PLAN SCALE: 1/16"=1'-0"



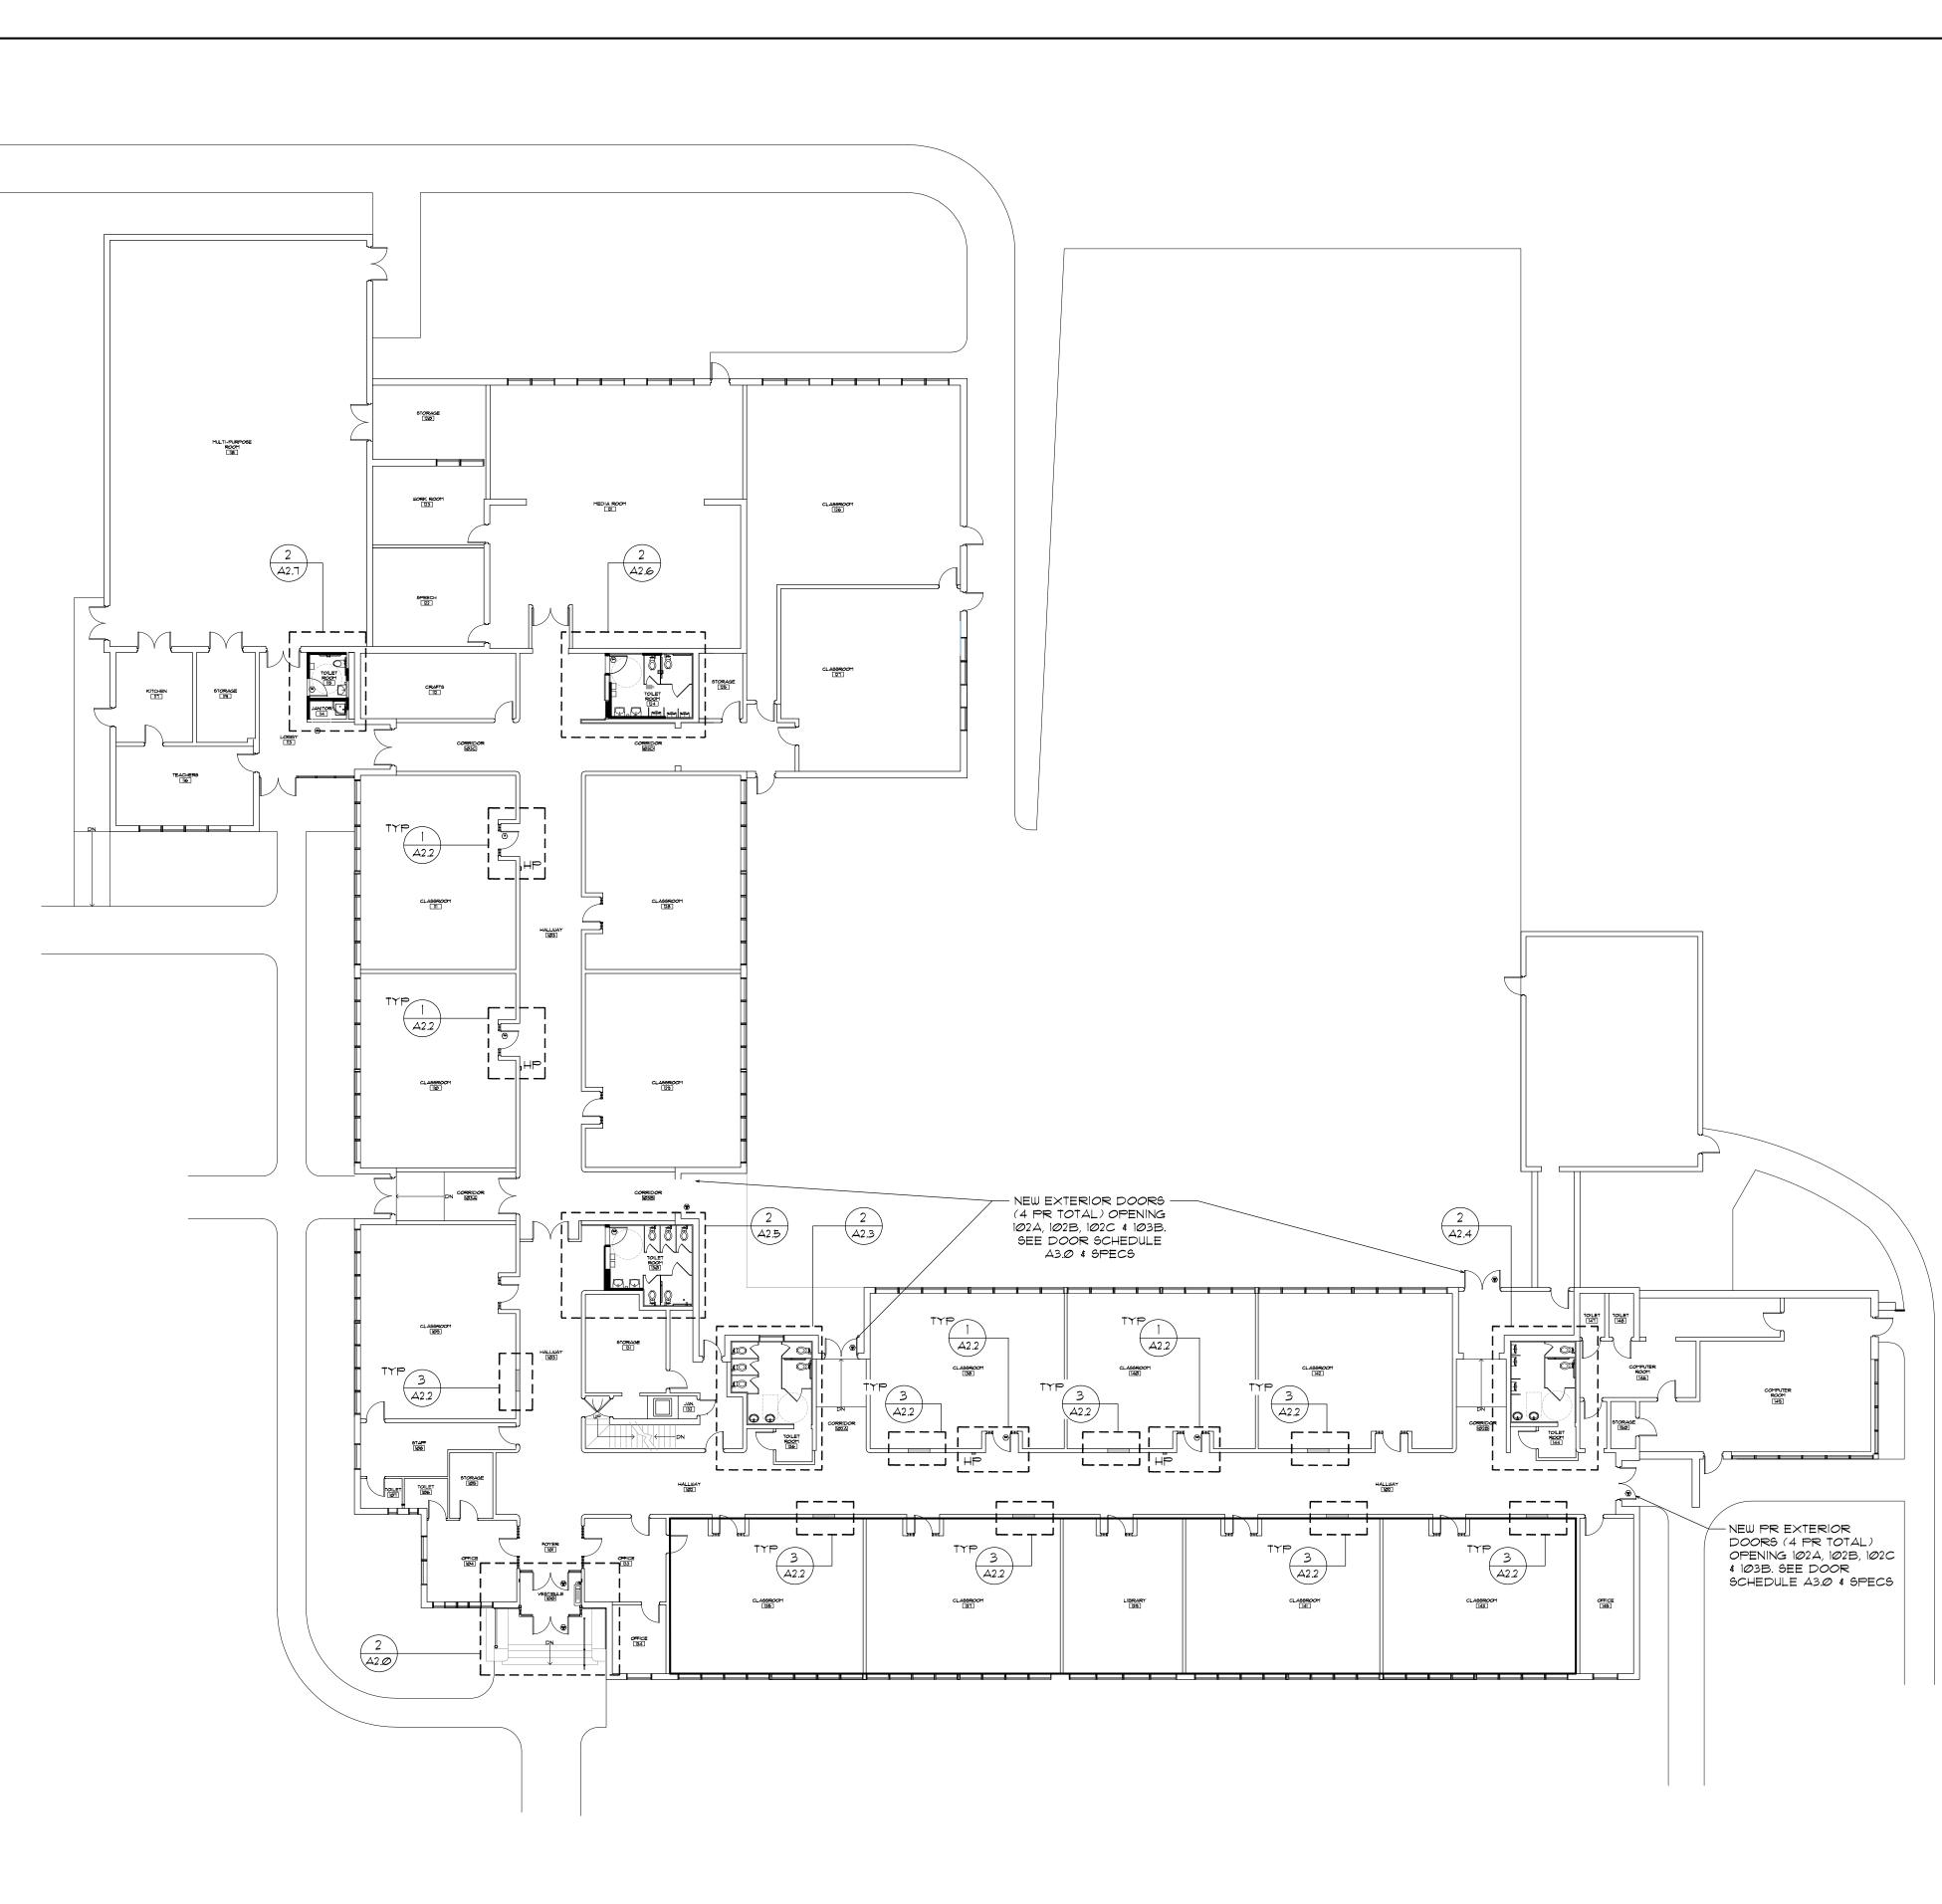
GENERAL DEMOLITION NOTES

- 1. CONTRACTOR IS TO VERIFY ALL DIMENSIONS AND SITE CONDITIONS RELATIVE TO NEW WORK AND BE COMPLETELY FAMILIAR WITH ALL EXISTING CONDITIONS RELATIVE TO THE NEW WORK CALLED FOR ON THE DRAWINGS AND SPECS. NO COMPENSATION FOR EXTRA WORK ON BEHALF OF THE CONTRACTOR WILL BE CONSIDERED THAT WOULD HAVE BEEN DETERMINED BY VISUAL OBSERVATION PRIOR TO BIDDING.
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- 12. GENERAL DEMOLITION NOTES APPLY TO ALL PARTS OF THE PROJECT DEMOLITION.
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RECESSED DISPLAY CASES(RDC) REMOVE LIGHT FIXTURE 4 ASSOCIATED WIRING, GLASS 4 ALL ALUMINUM TRIM SITTING PROUD OF TILE IN ALL RDC (7) IN HALLWAY (102) 4 (1) IN HALLWAY (103), 8 TOTAL, SEE 2/A4,2



SHEET OF



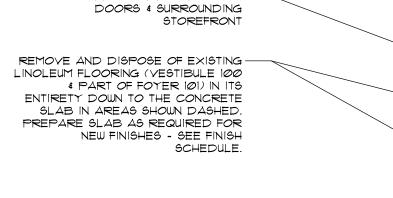
Ist FLOOR PROPSED PLAN SCALE: 1/16"=1'-0"

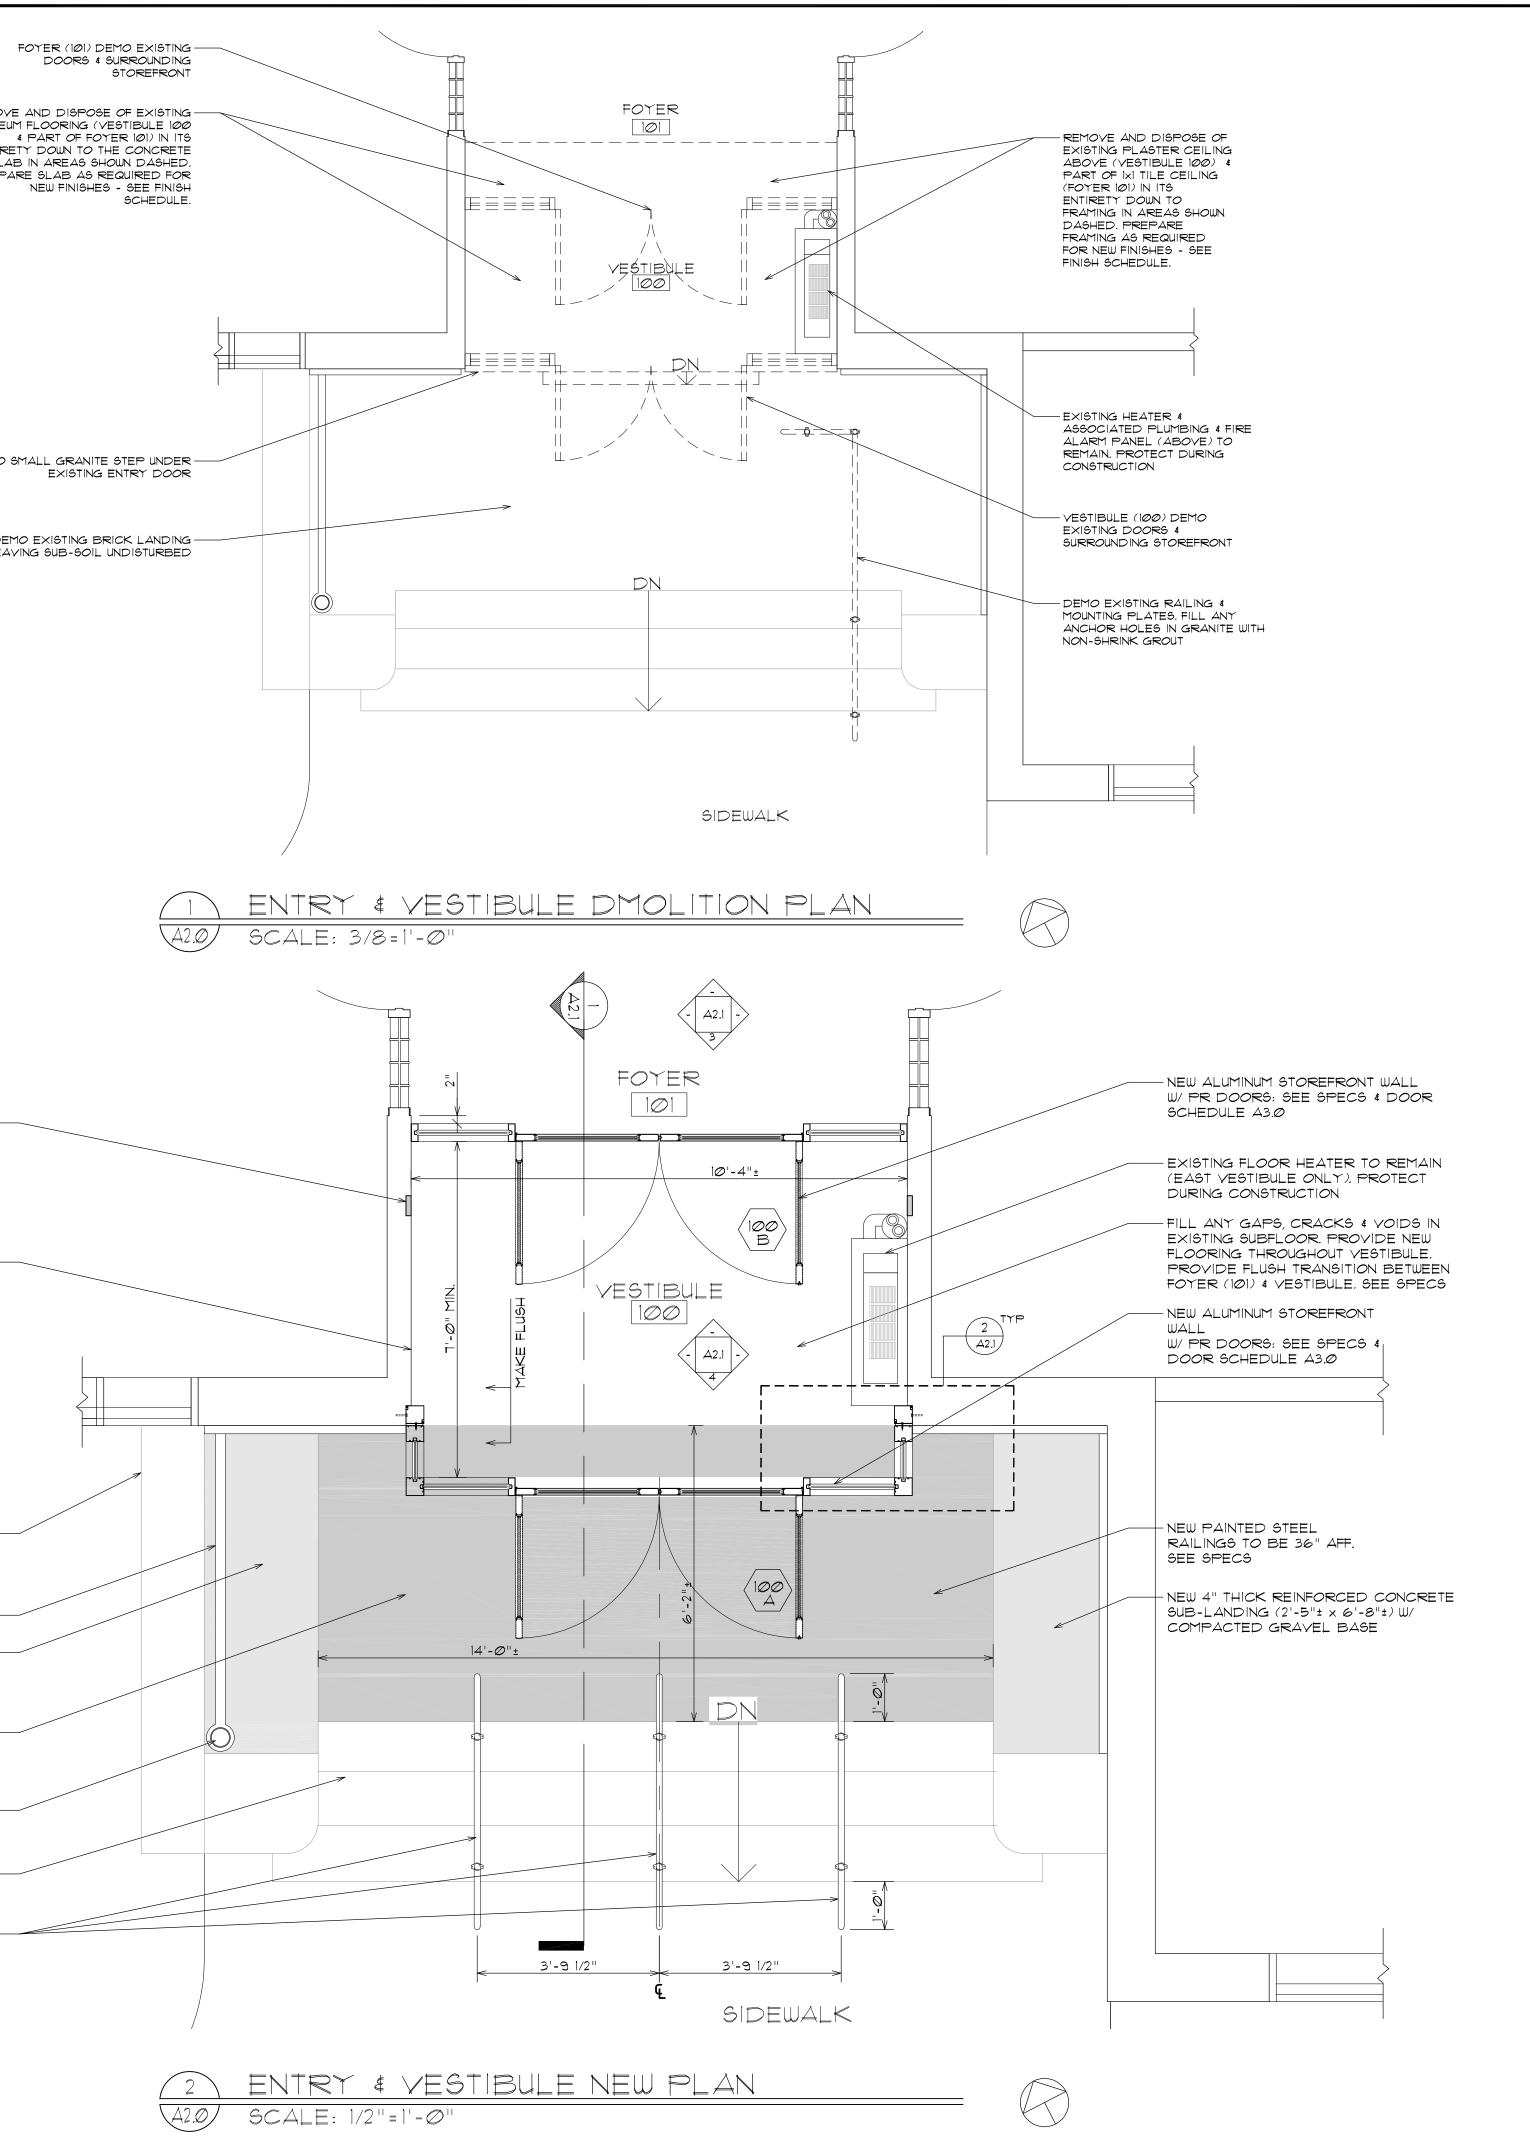


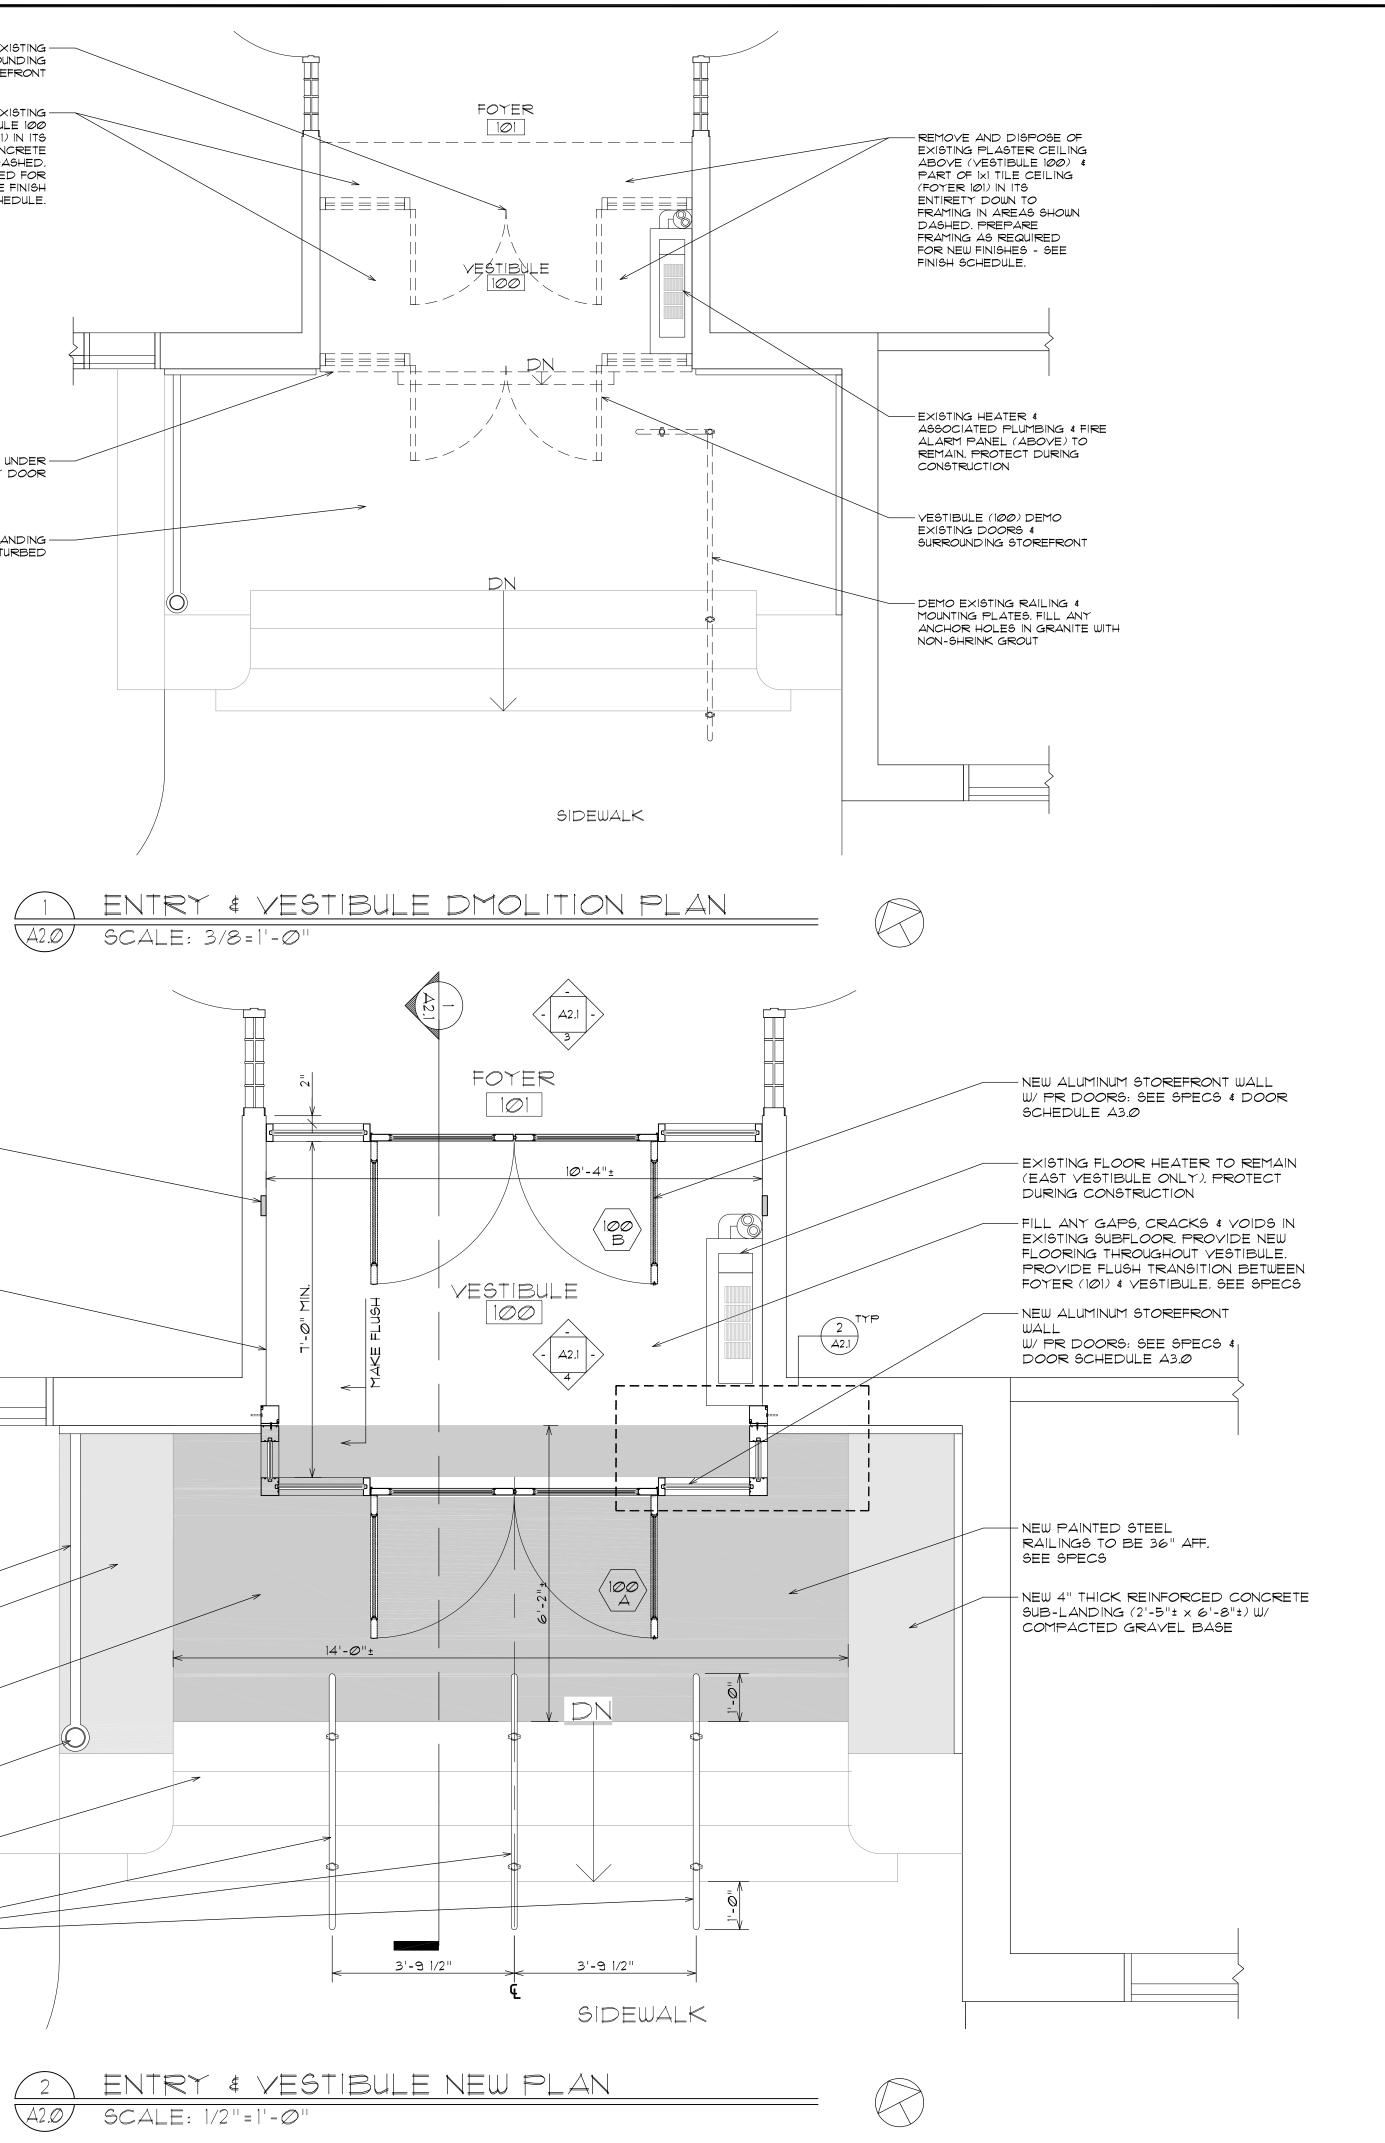
Image: Note of the second
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REVISIONS DRAWN: JMA DATE: @4.22.2@24 CHK BY: XX JOB NO: 23071 A11 SHEET OF

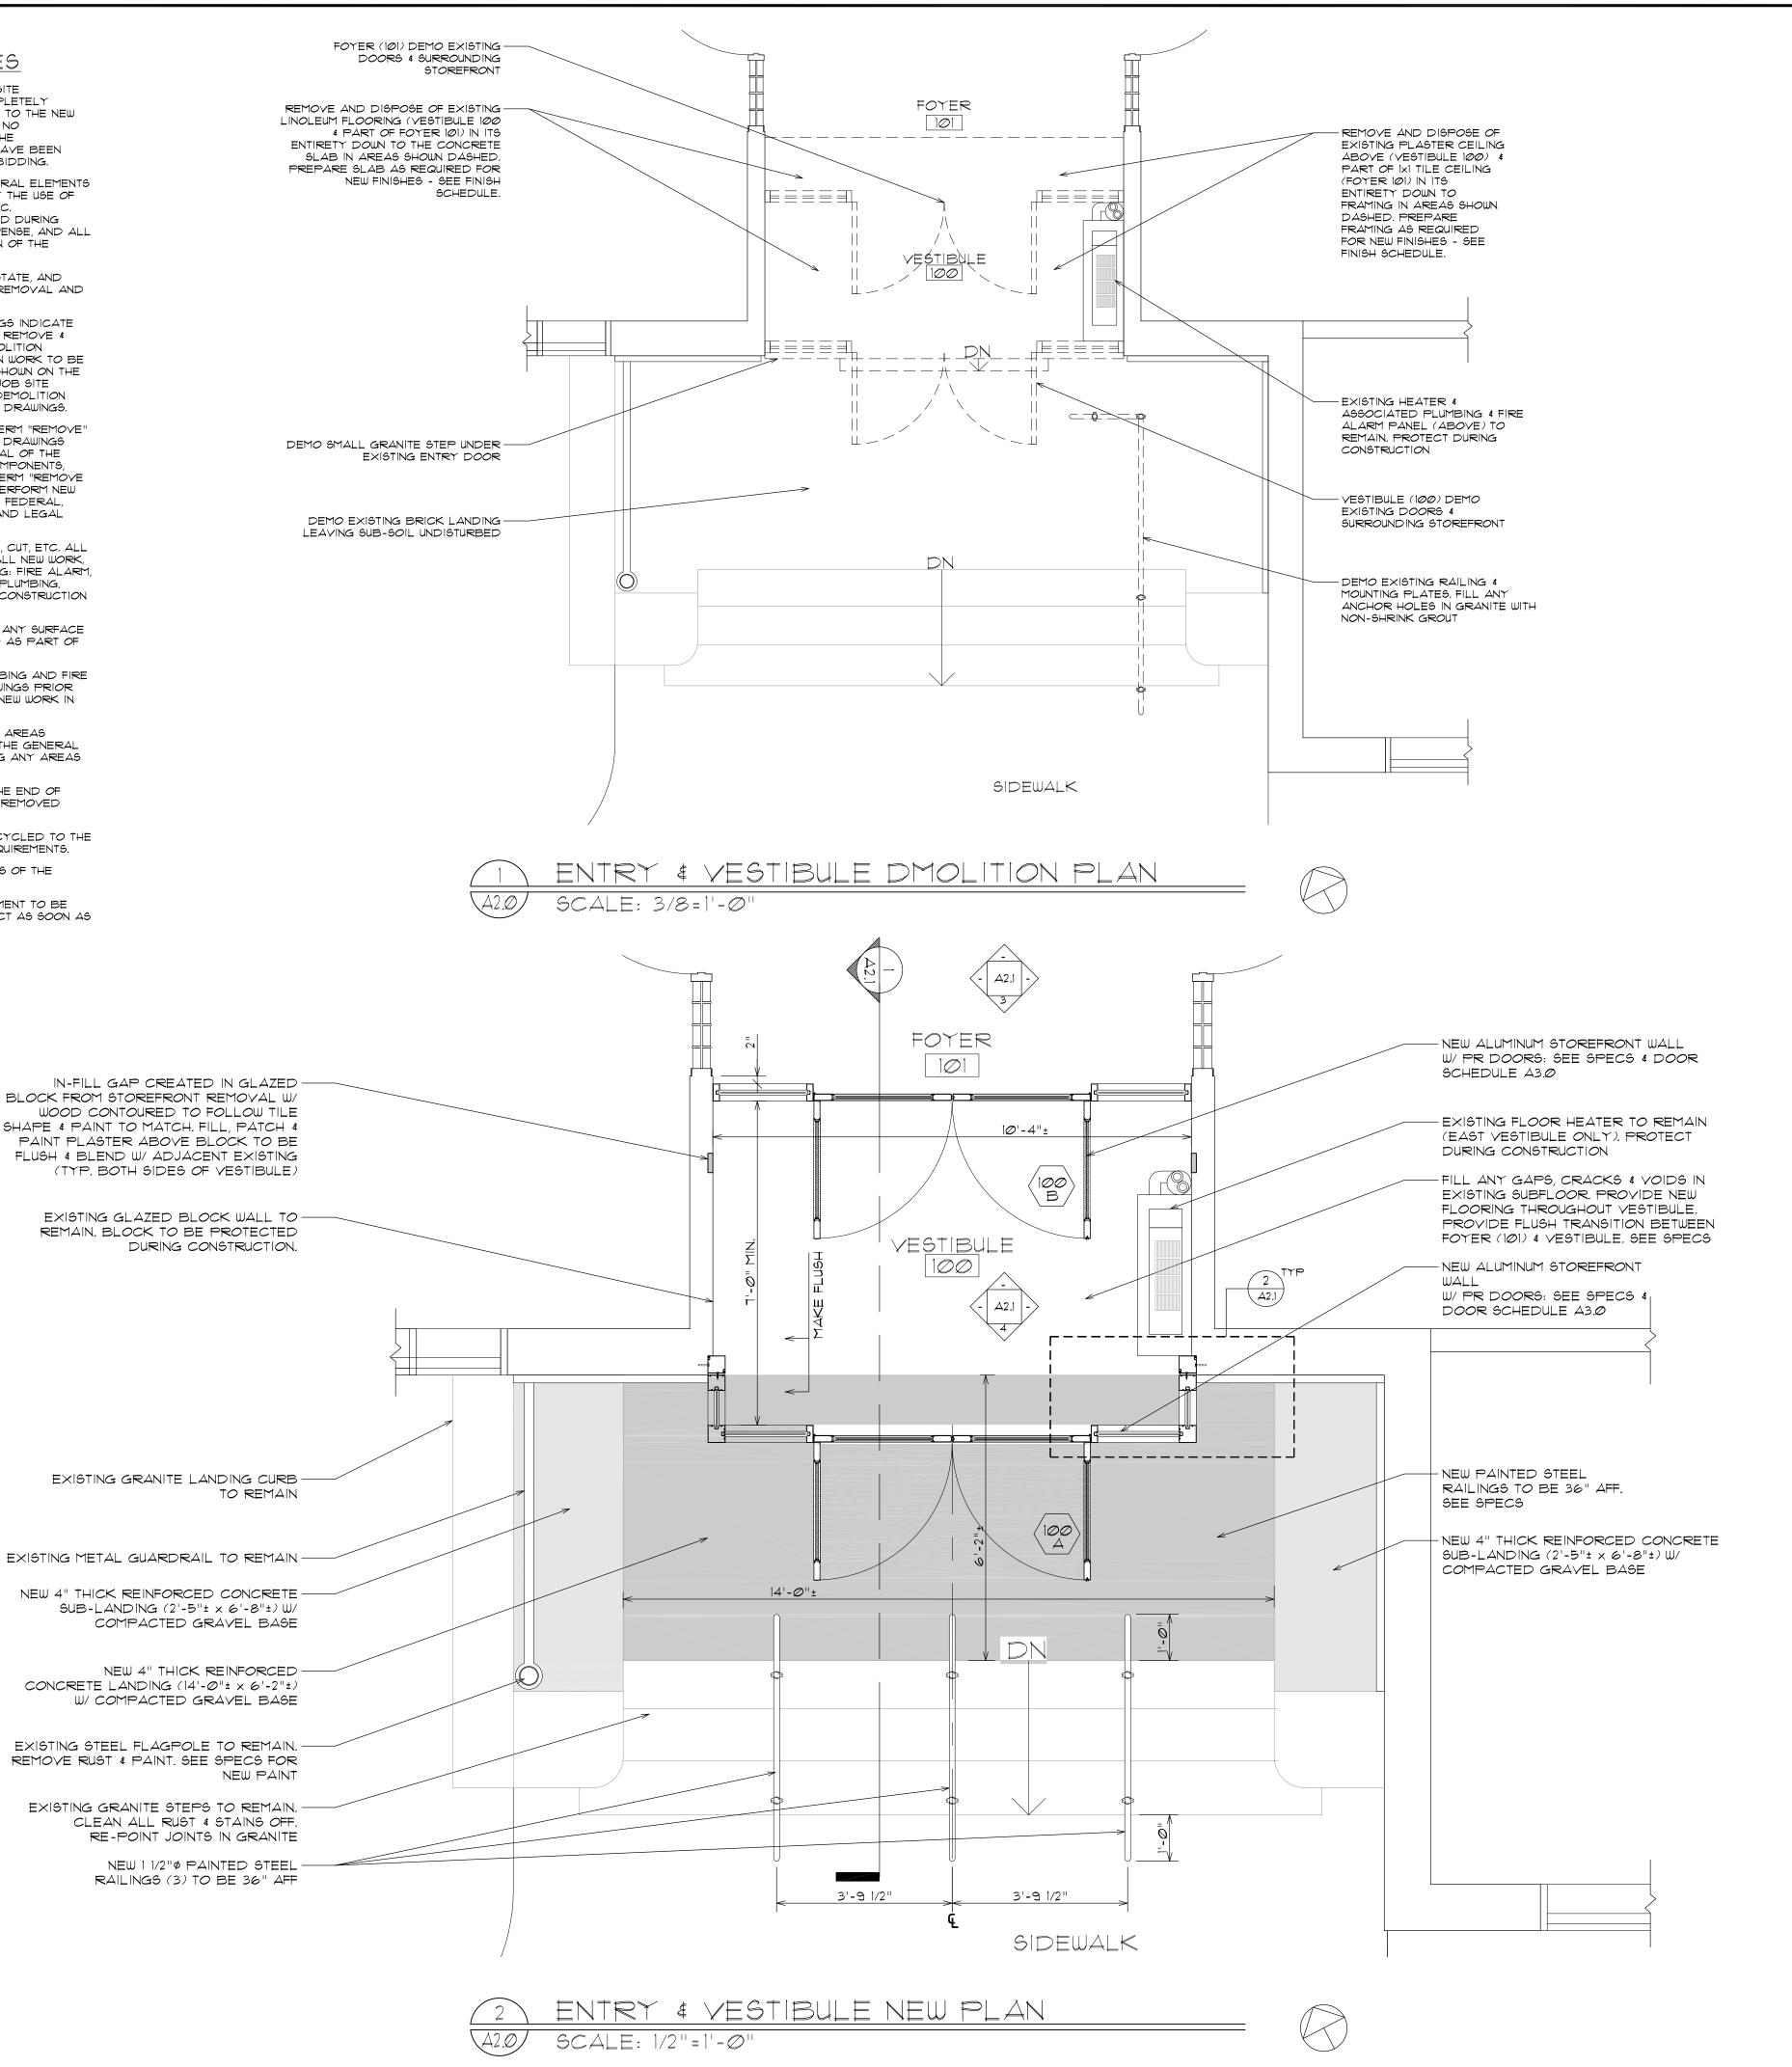
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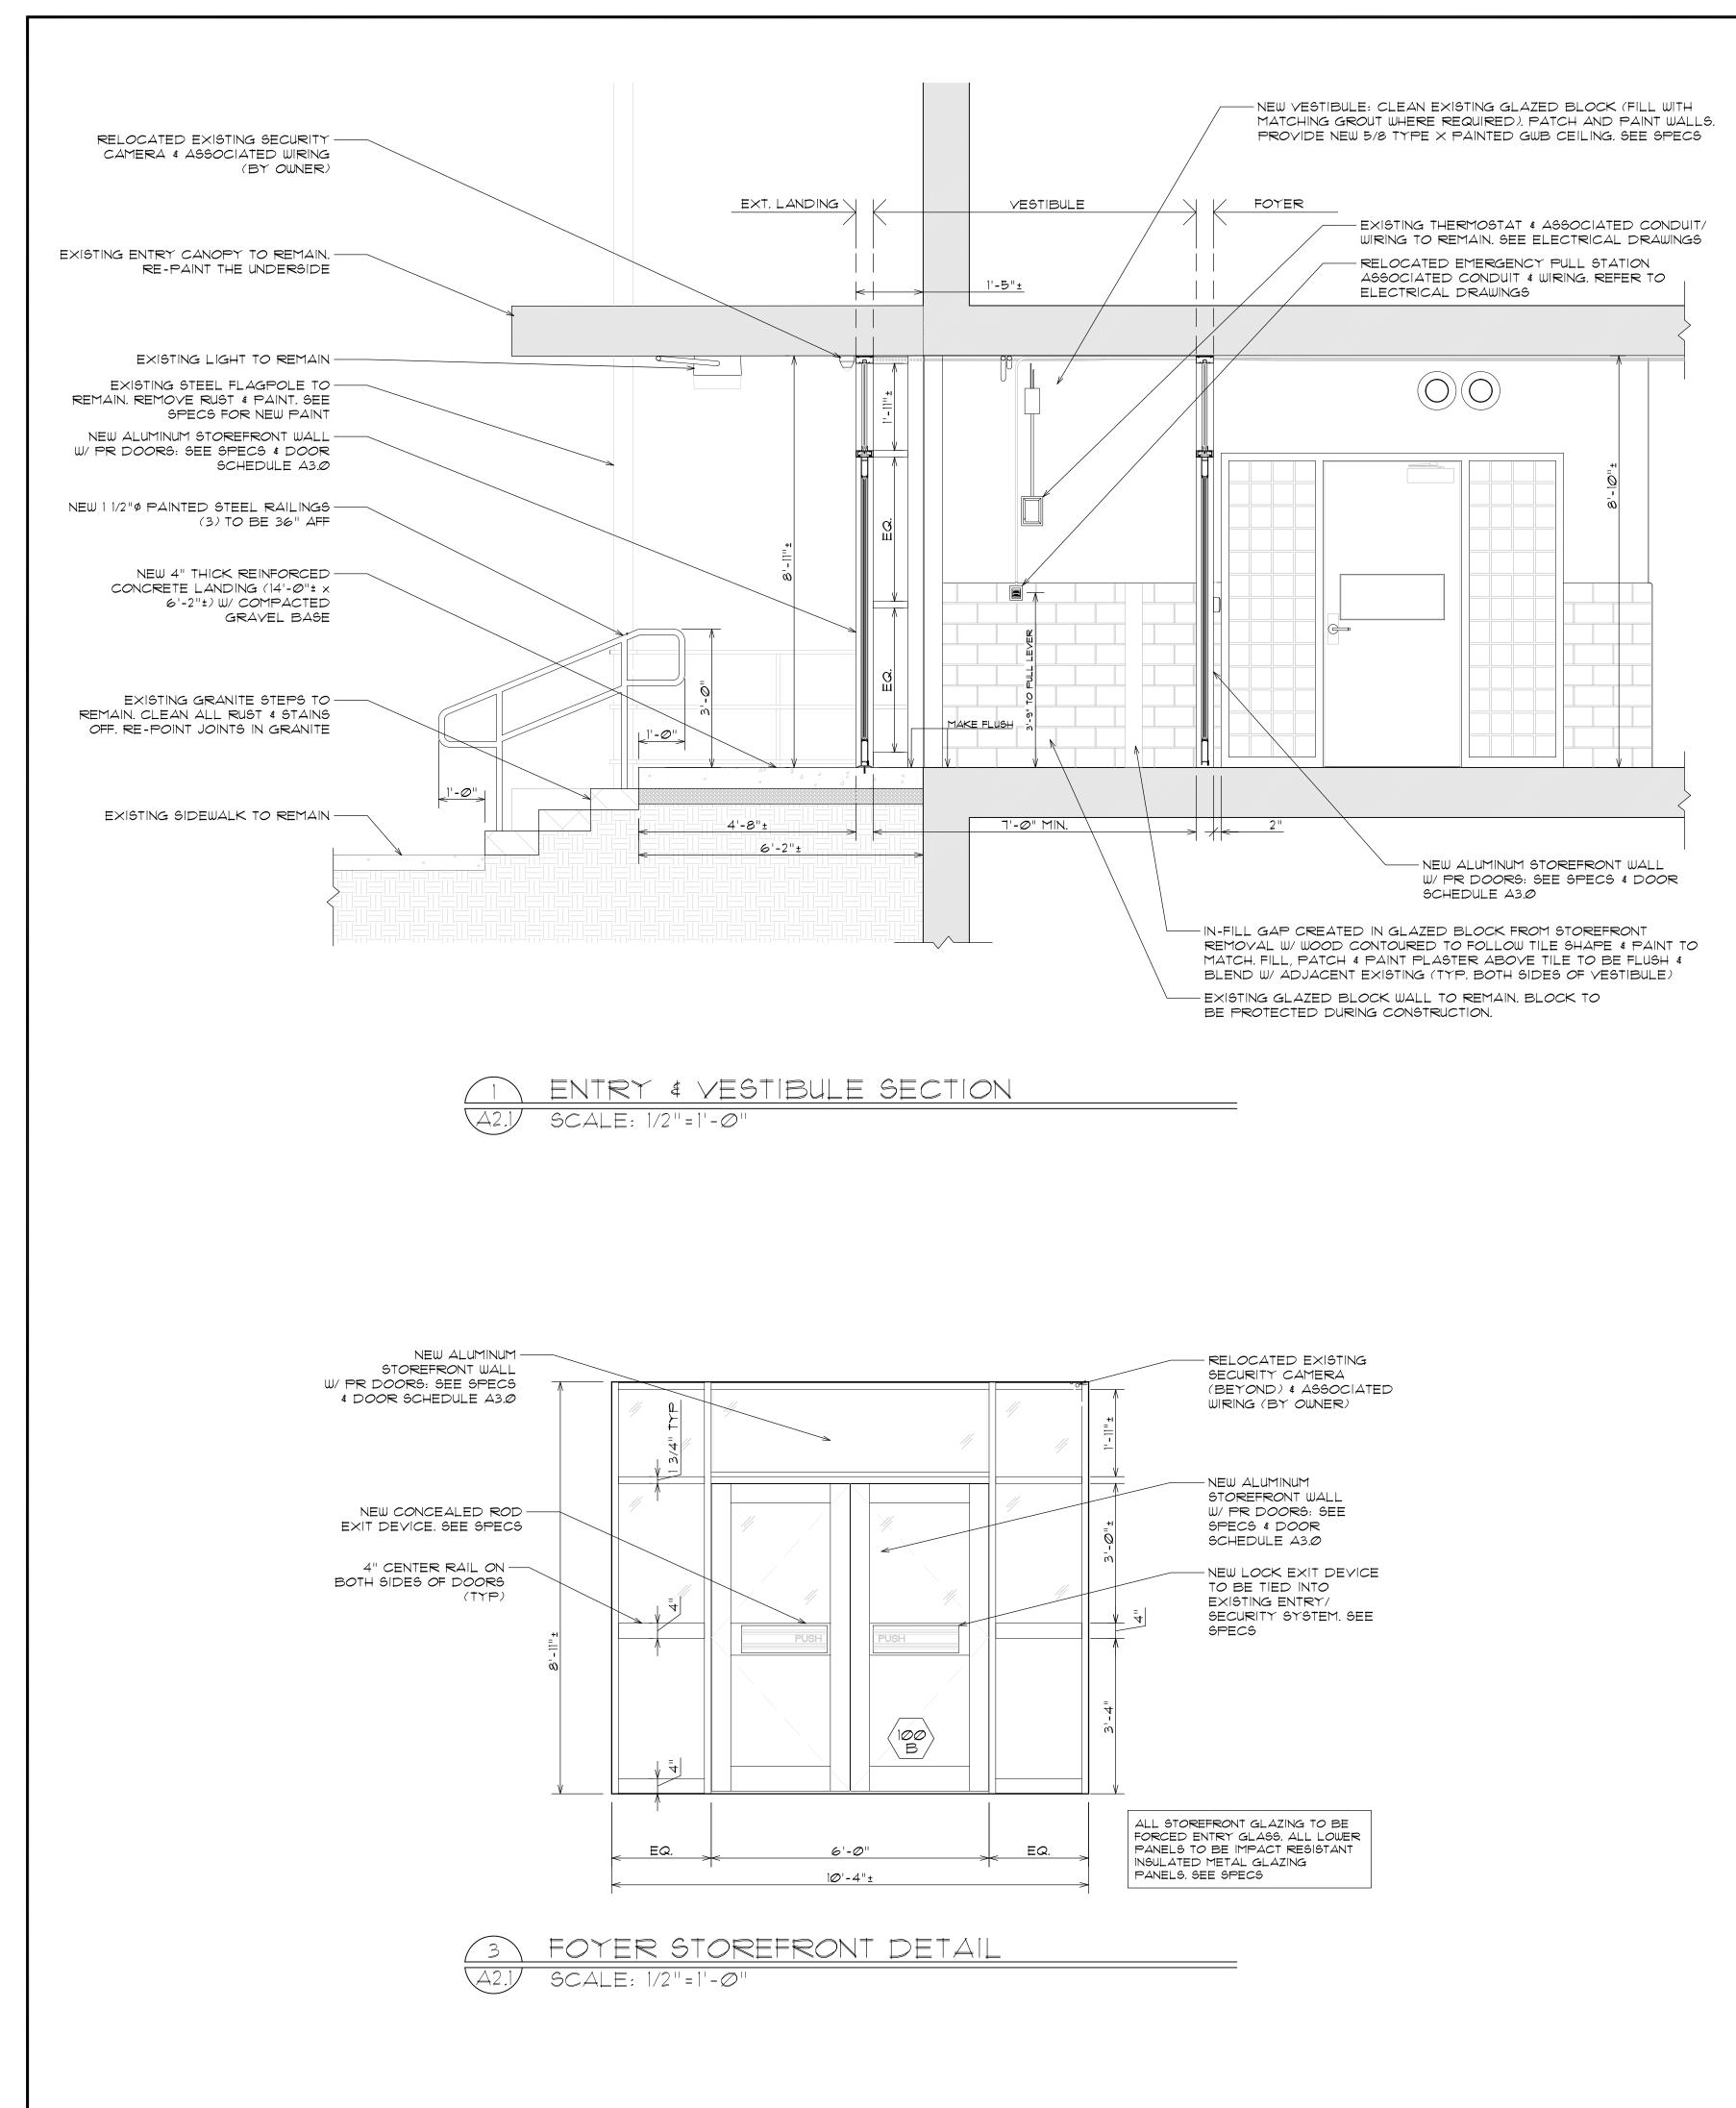


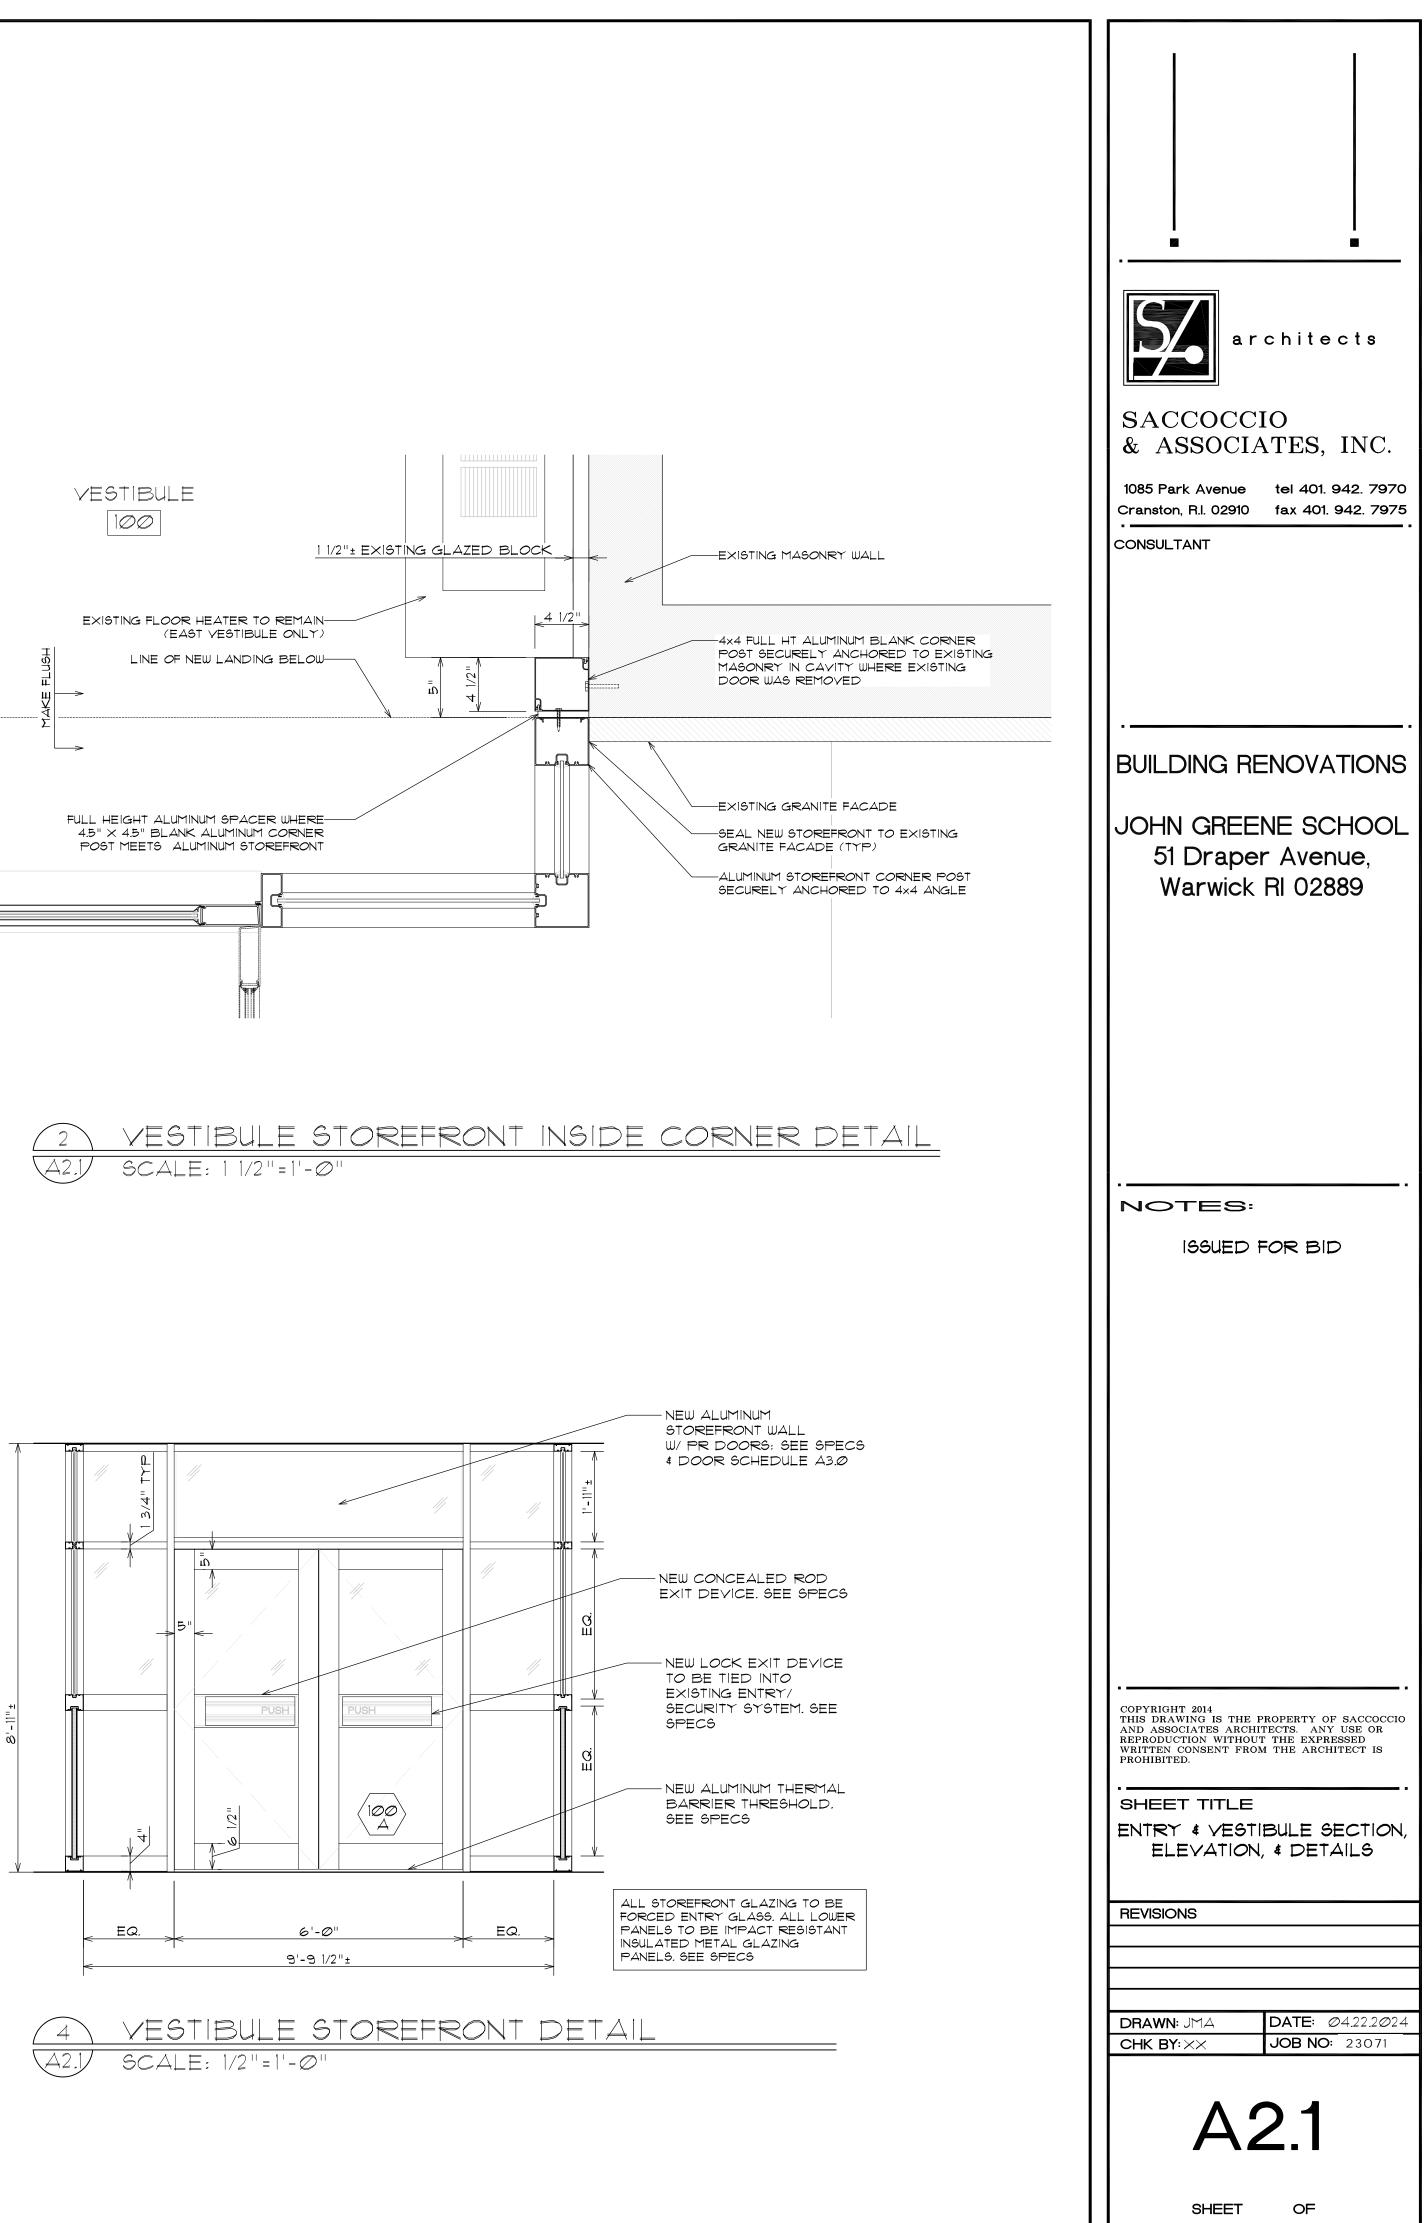




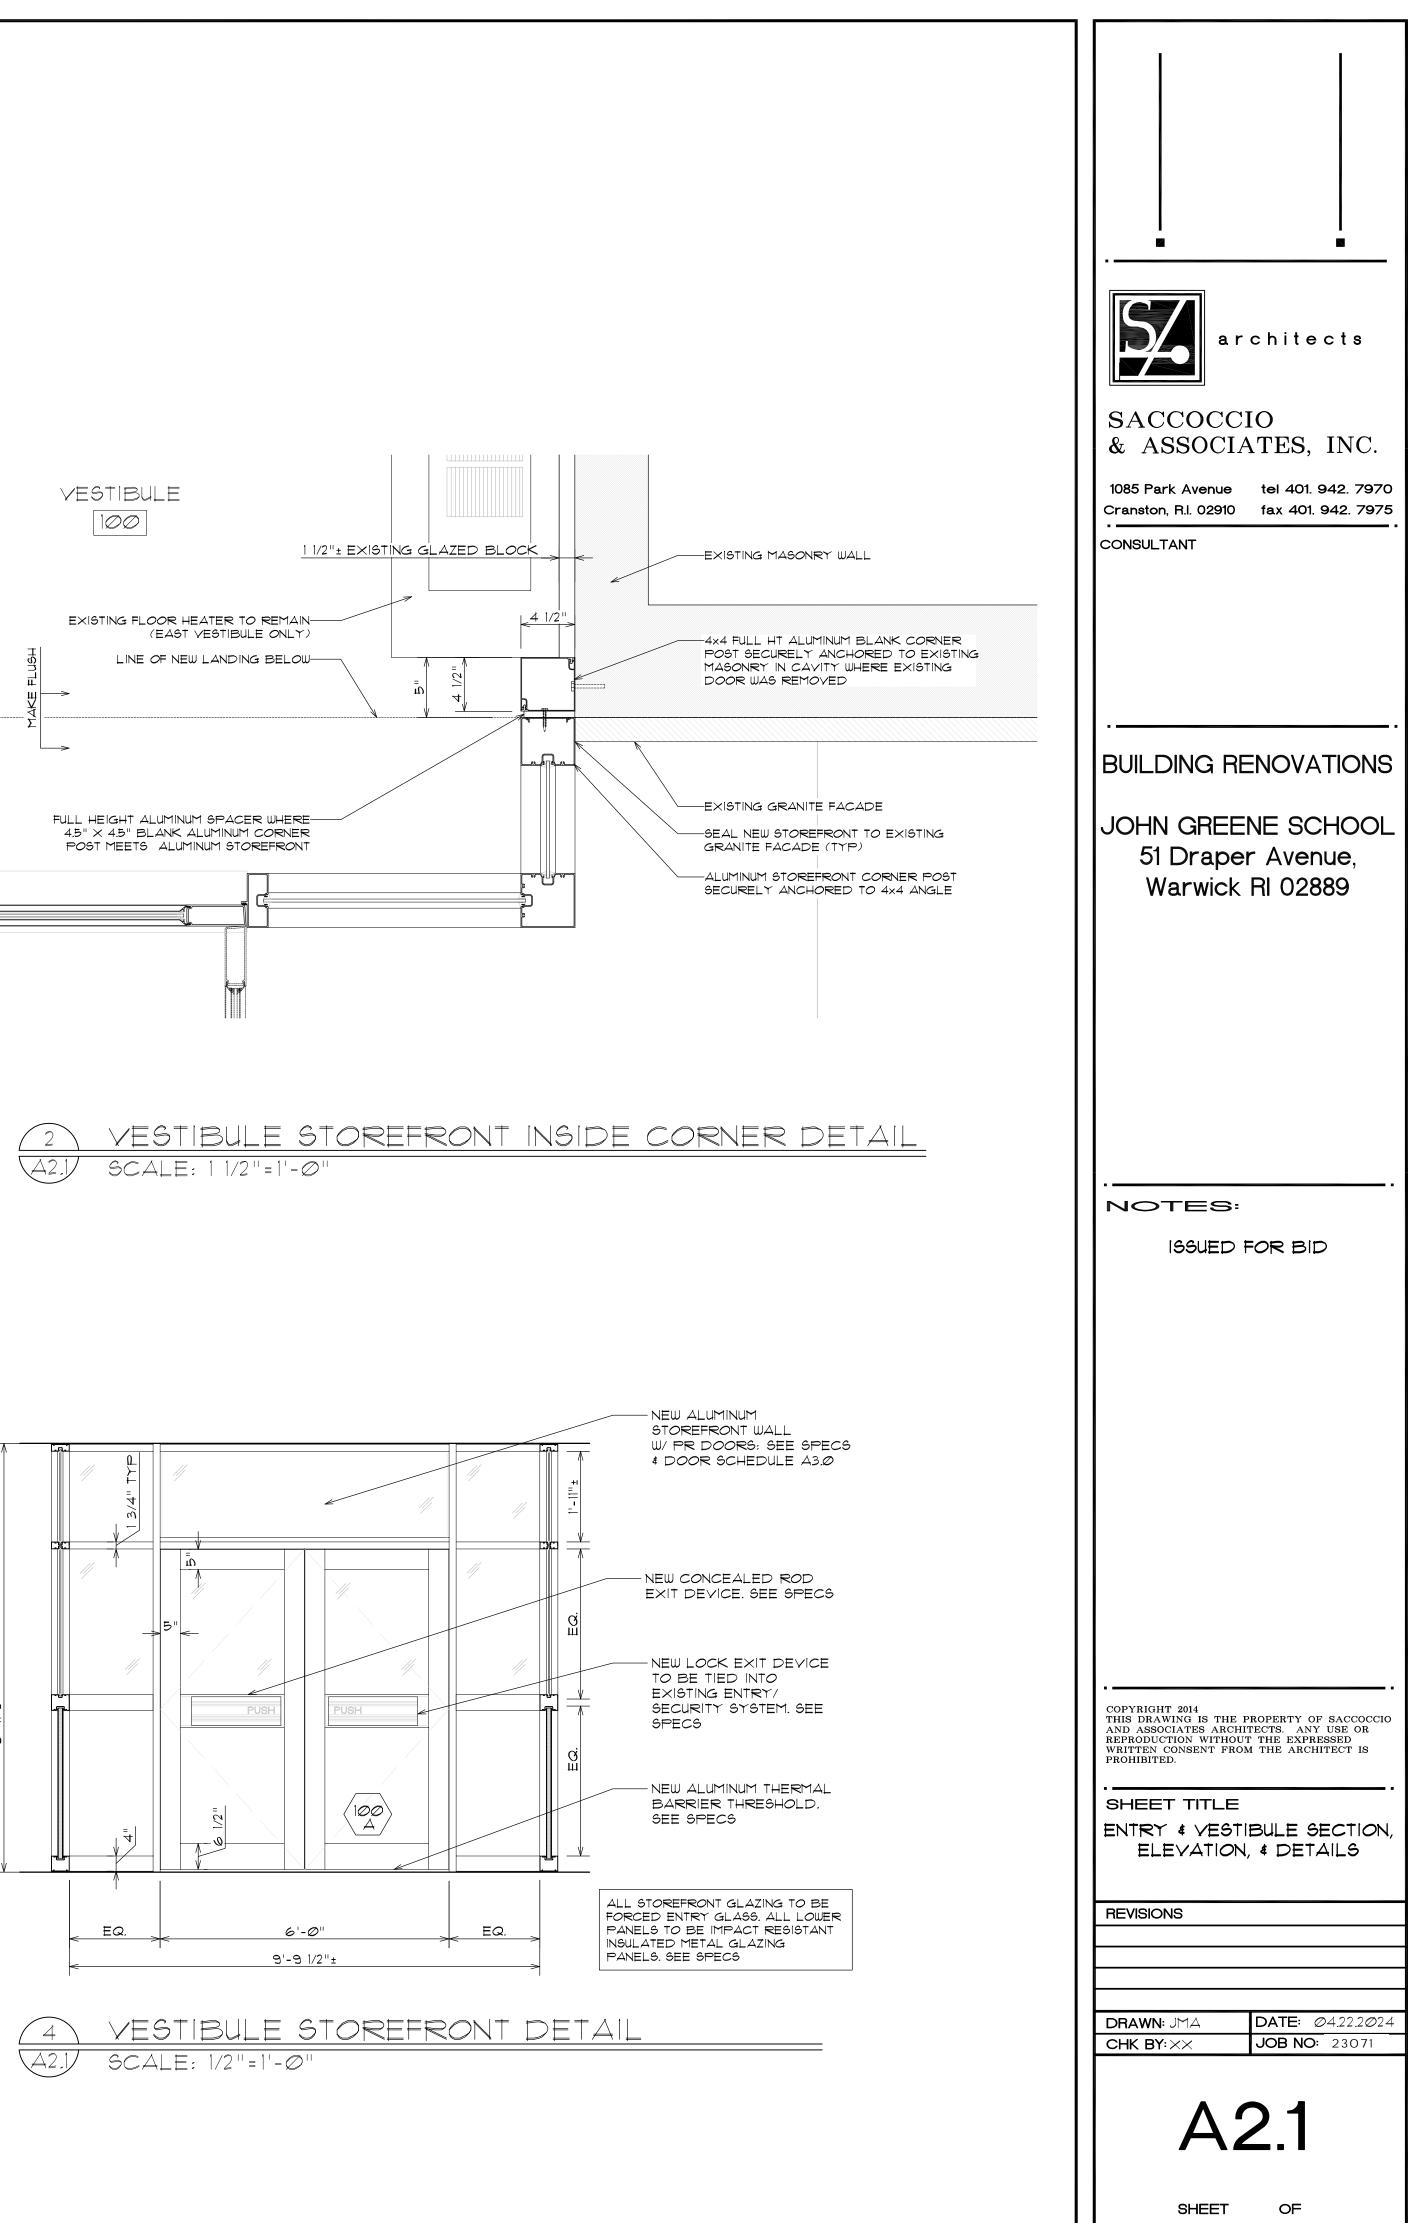


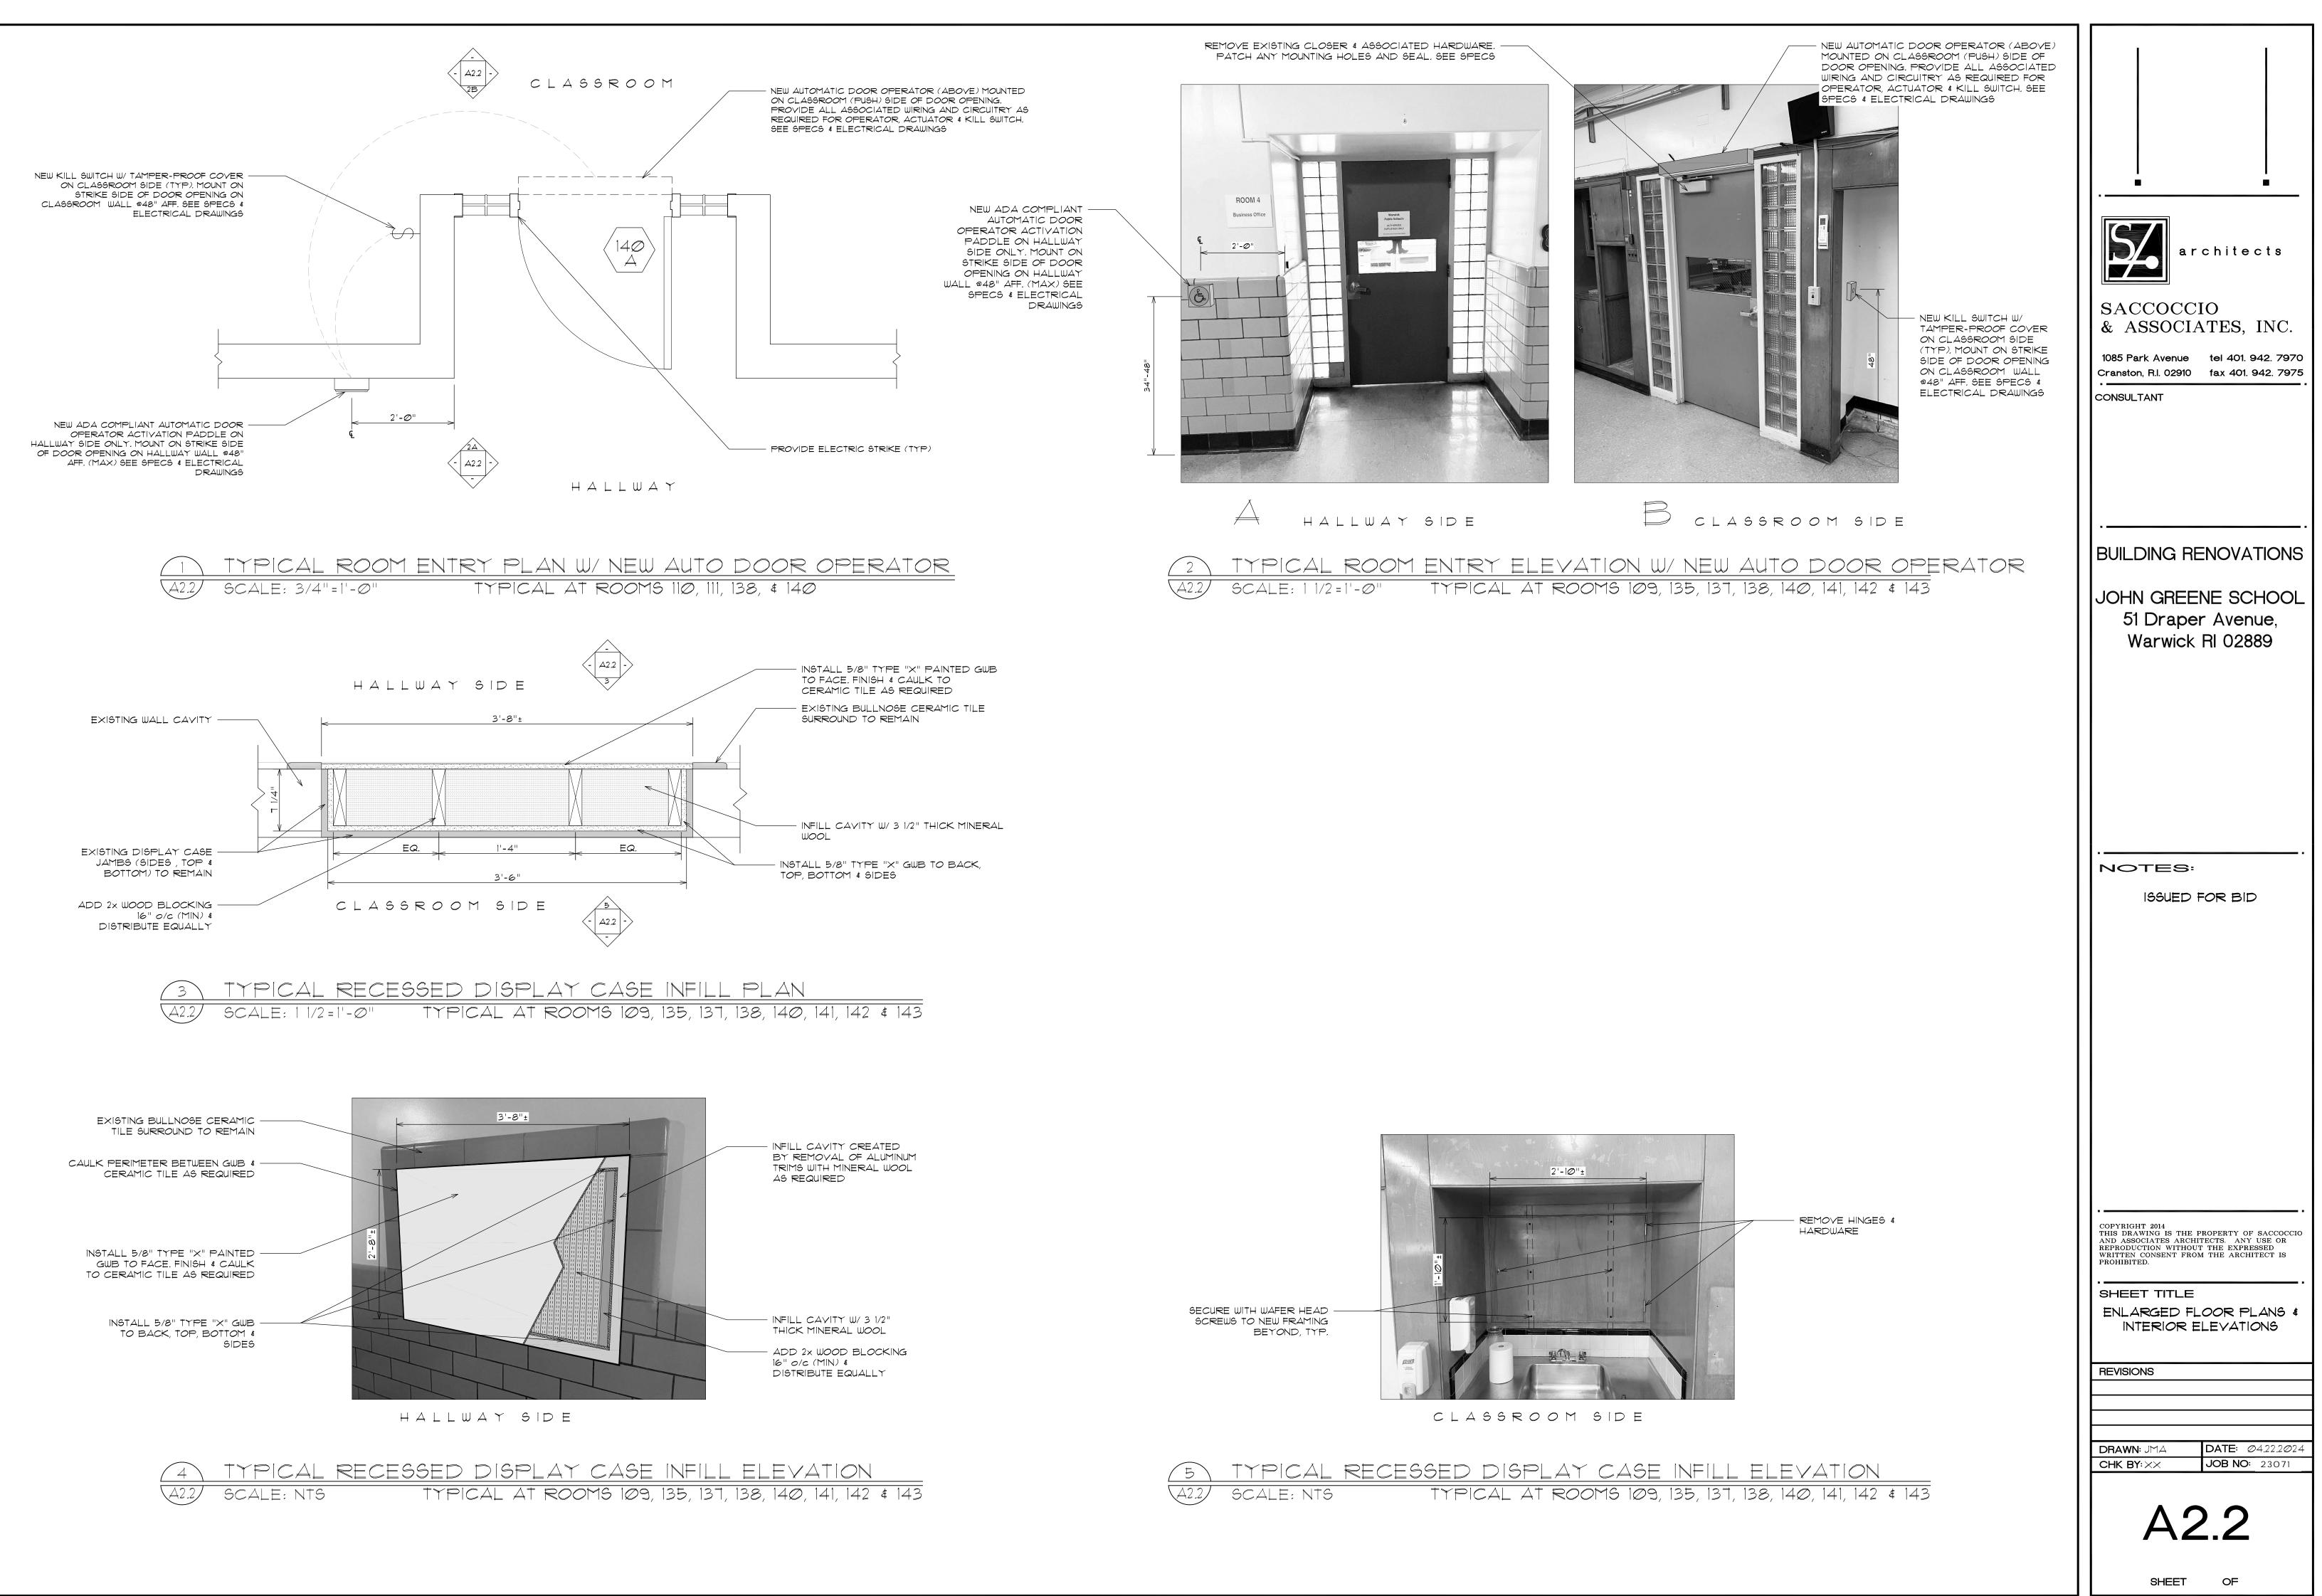
architects SACCOCCIO & ASSOCIATES, INC. 1085 Park Avenue tel 401. 942. 7970 Cranston, R.I. 02910 fax 401. 942. 7975 CONSULTANT
 BUILDING RENOVATIONS JOHN GREENE SCHOOL 51 Draper Avenue, Warwick RI 02889
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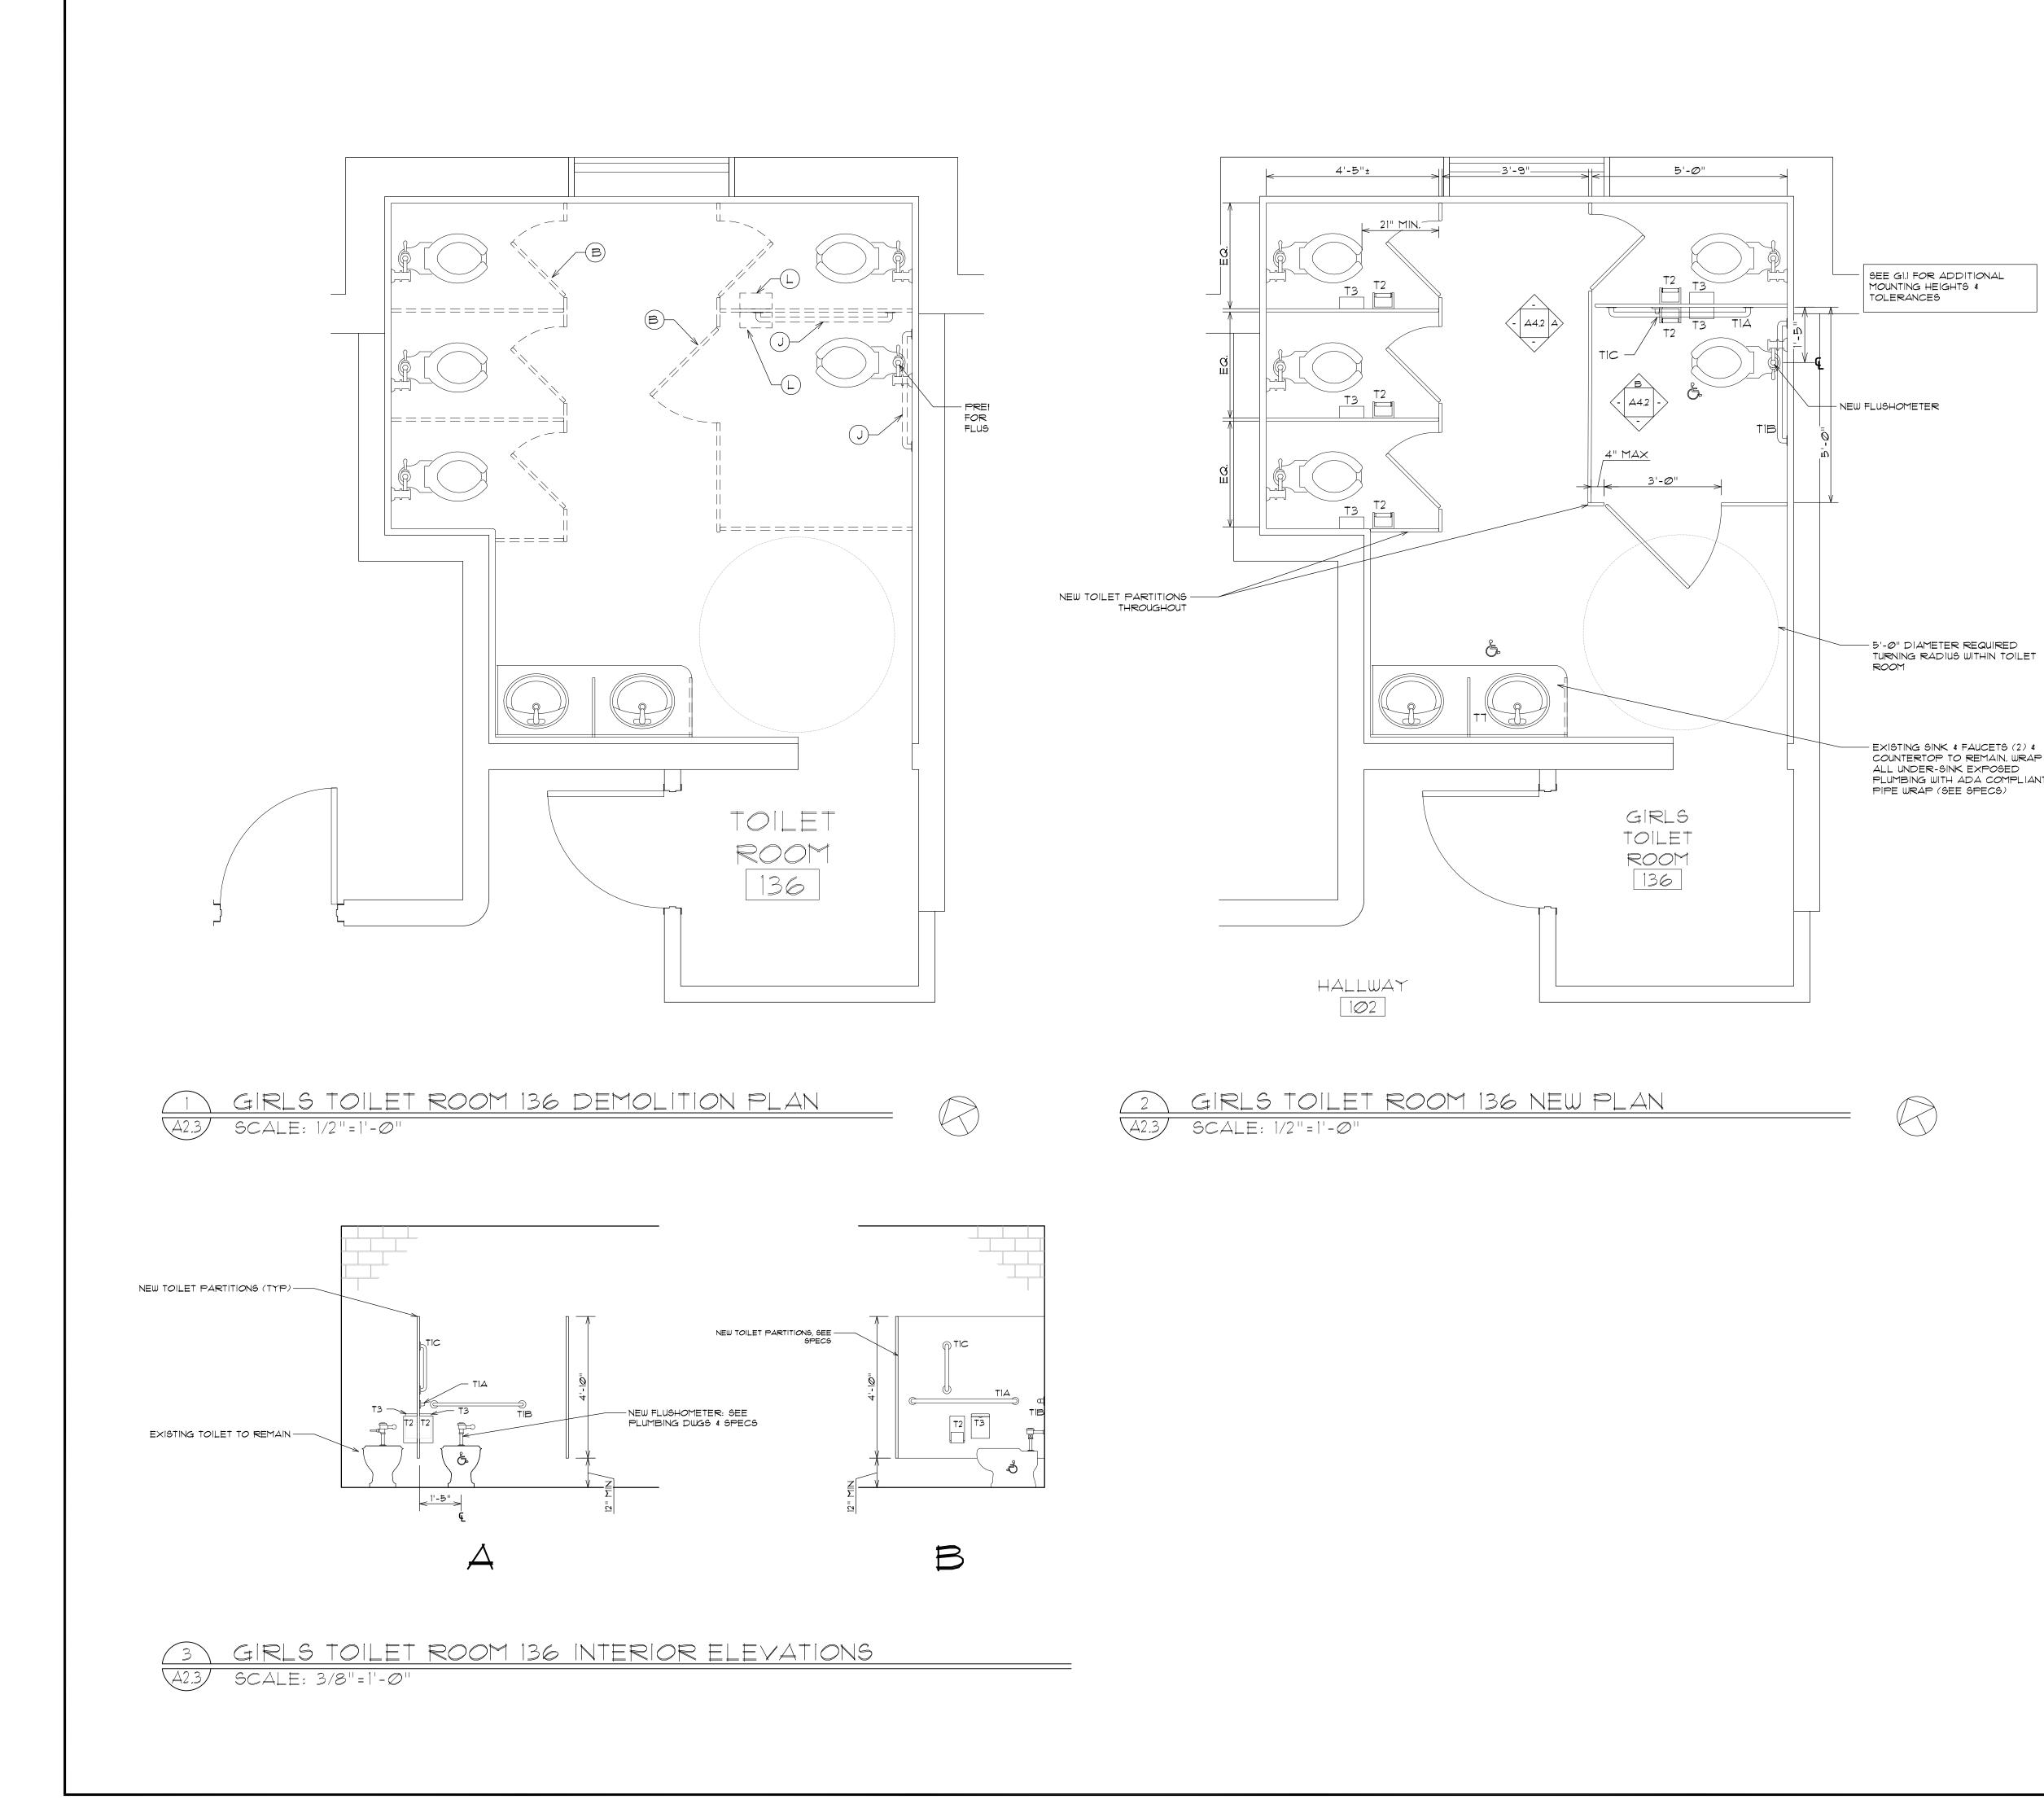




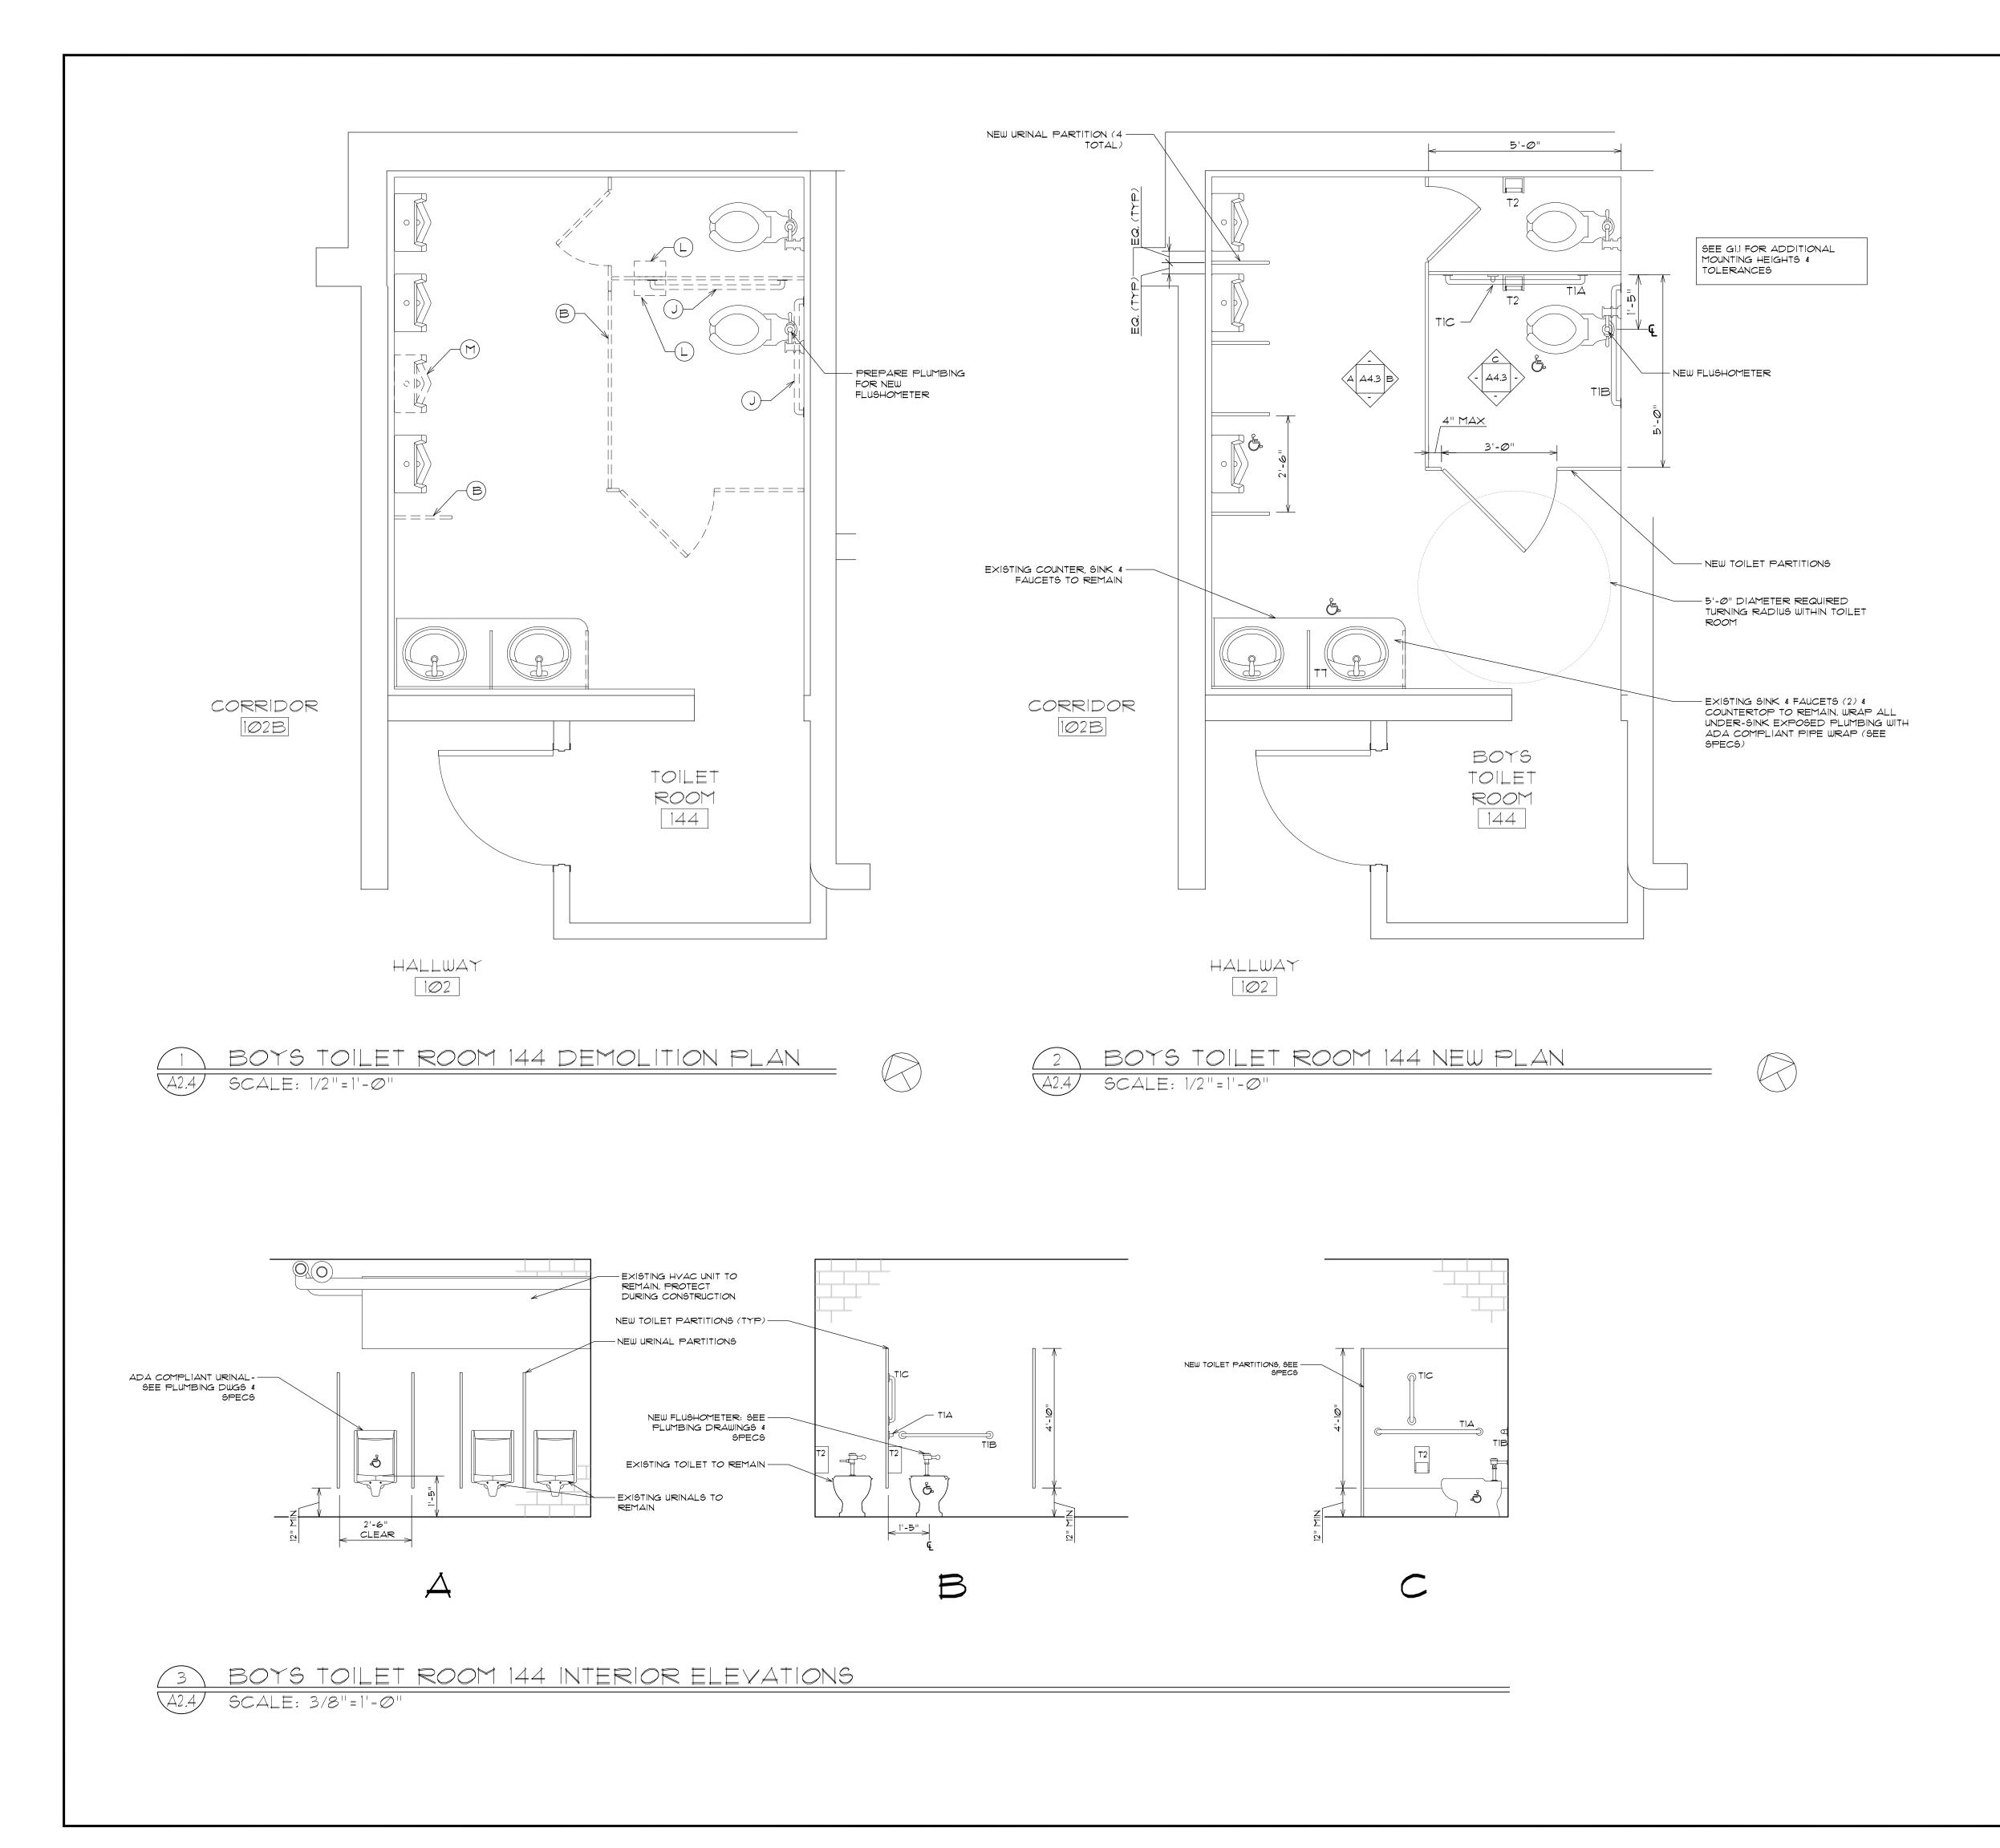
(2)	VESTIBULE STOREFRO
A2.1	$SCALE: 1 1/2'' = 1' - \emptyset''$



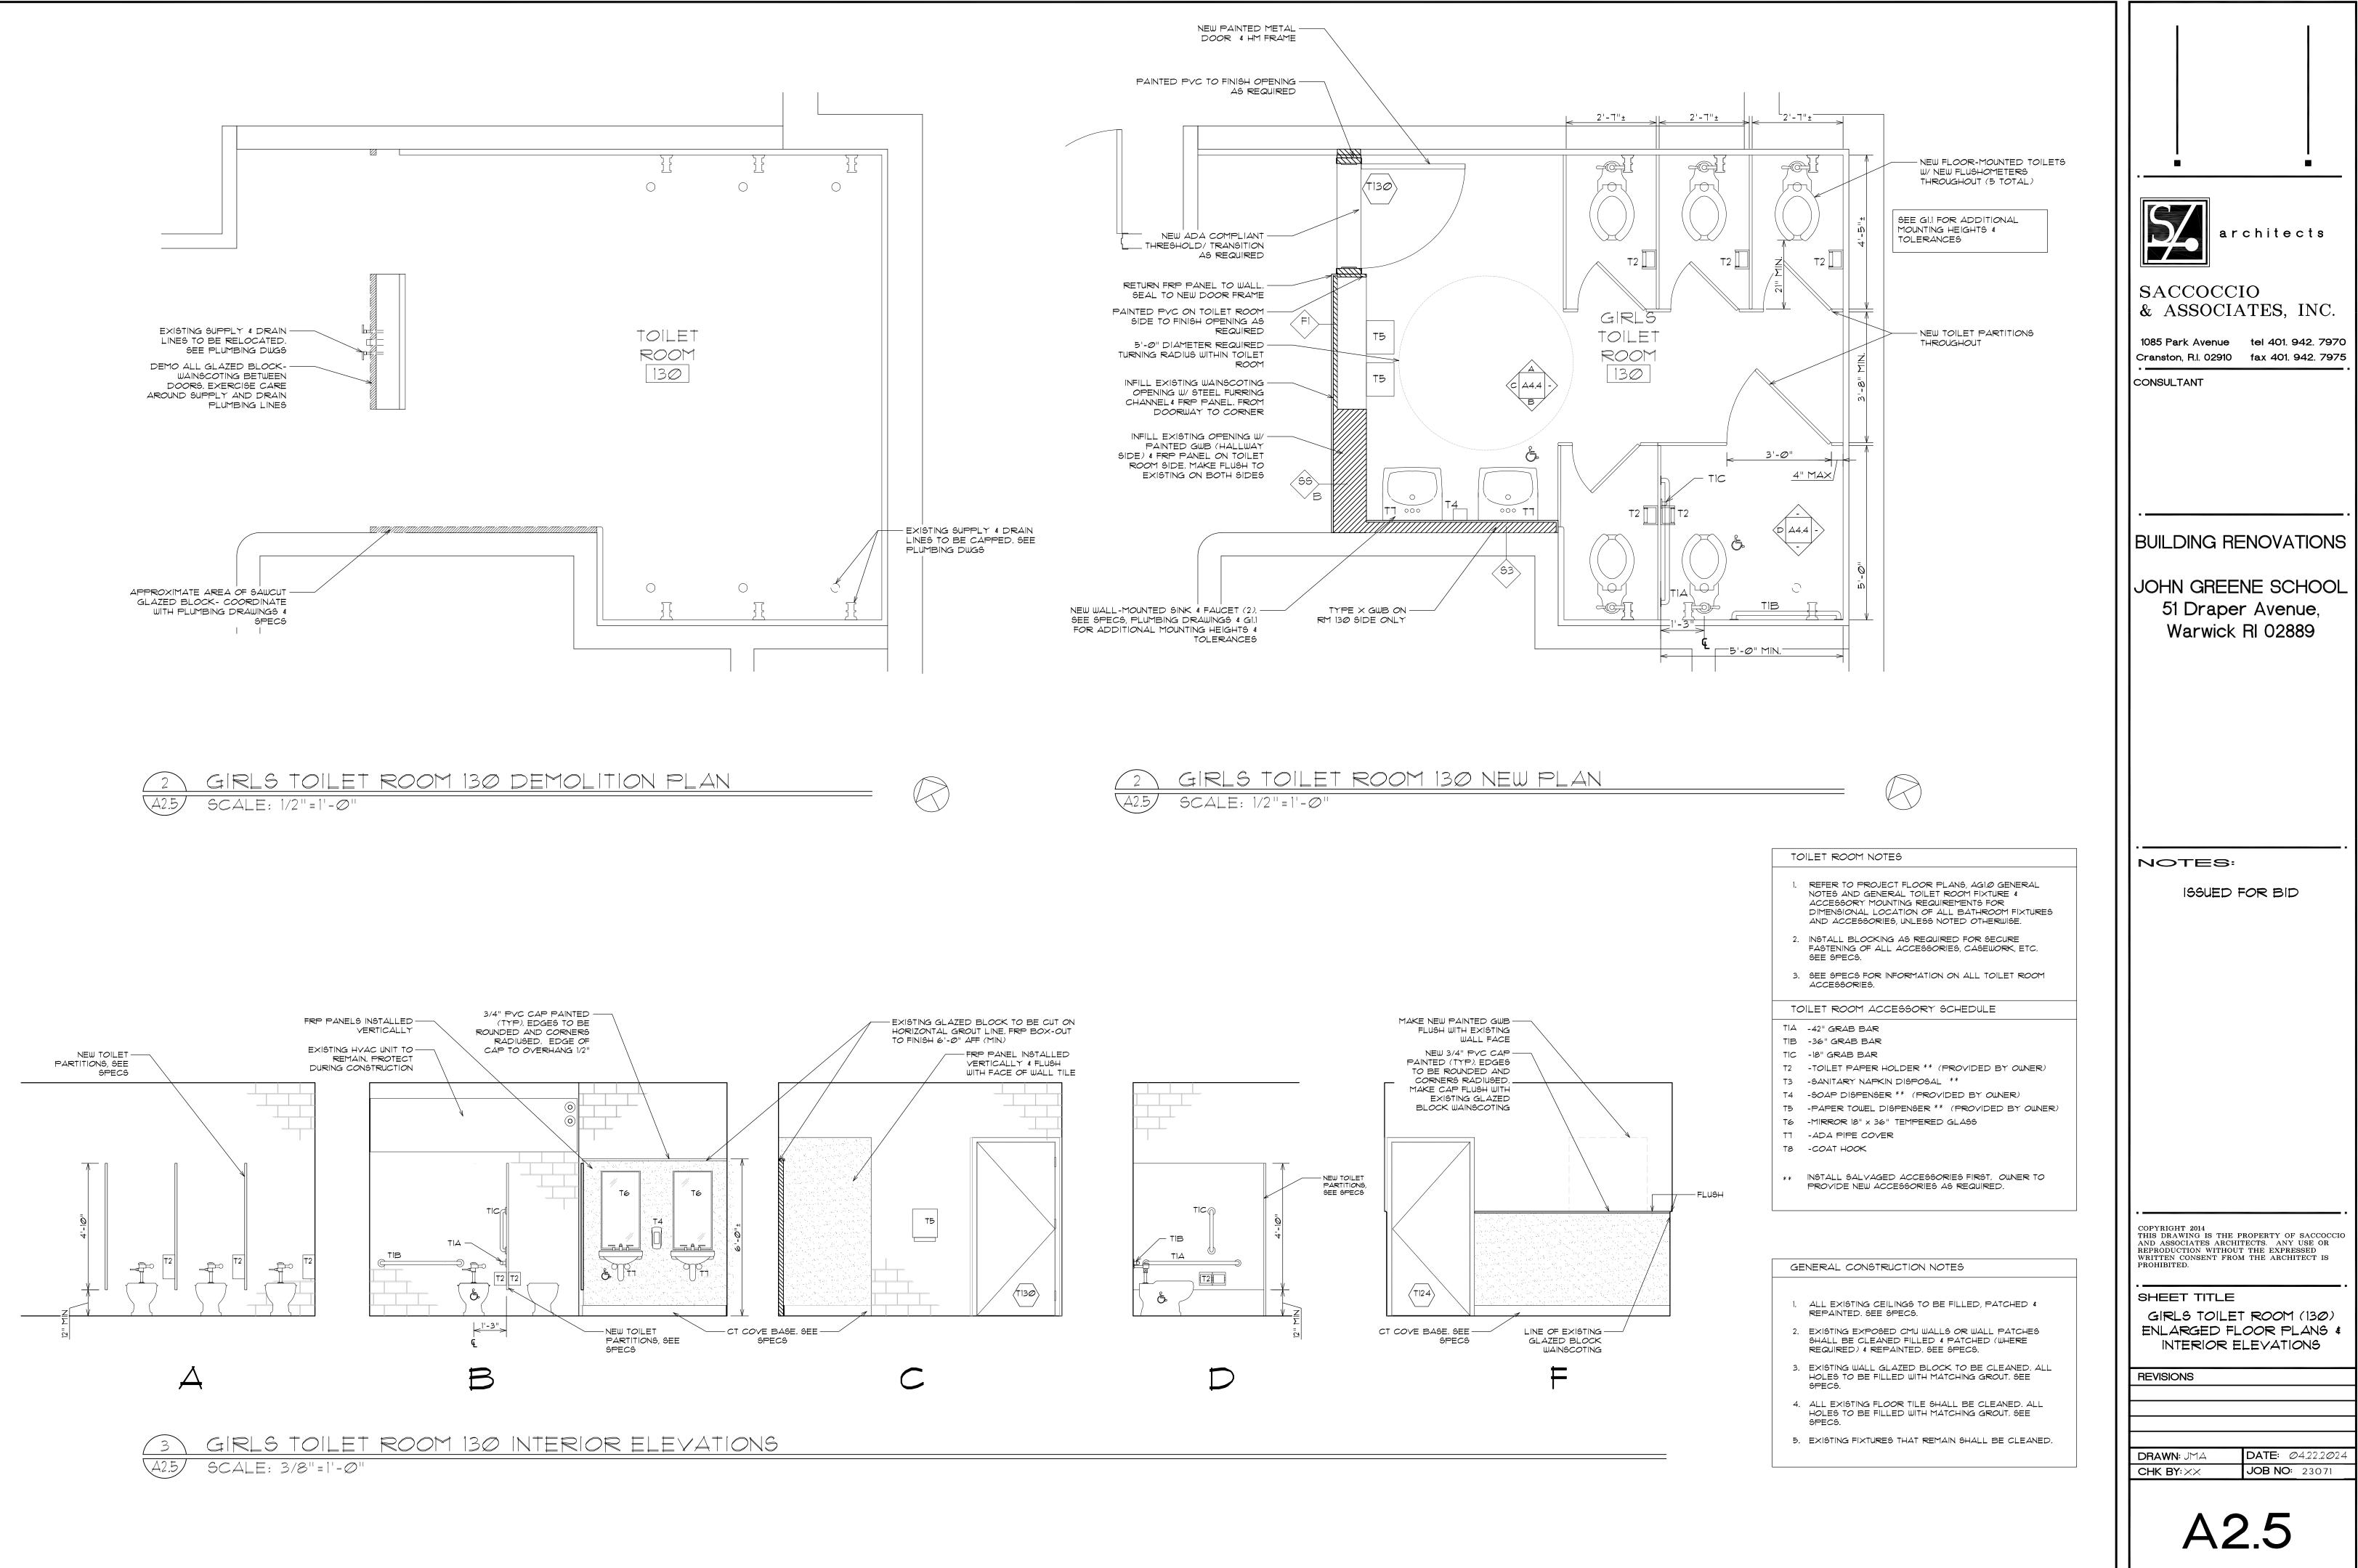




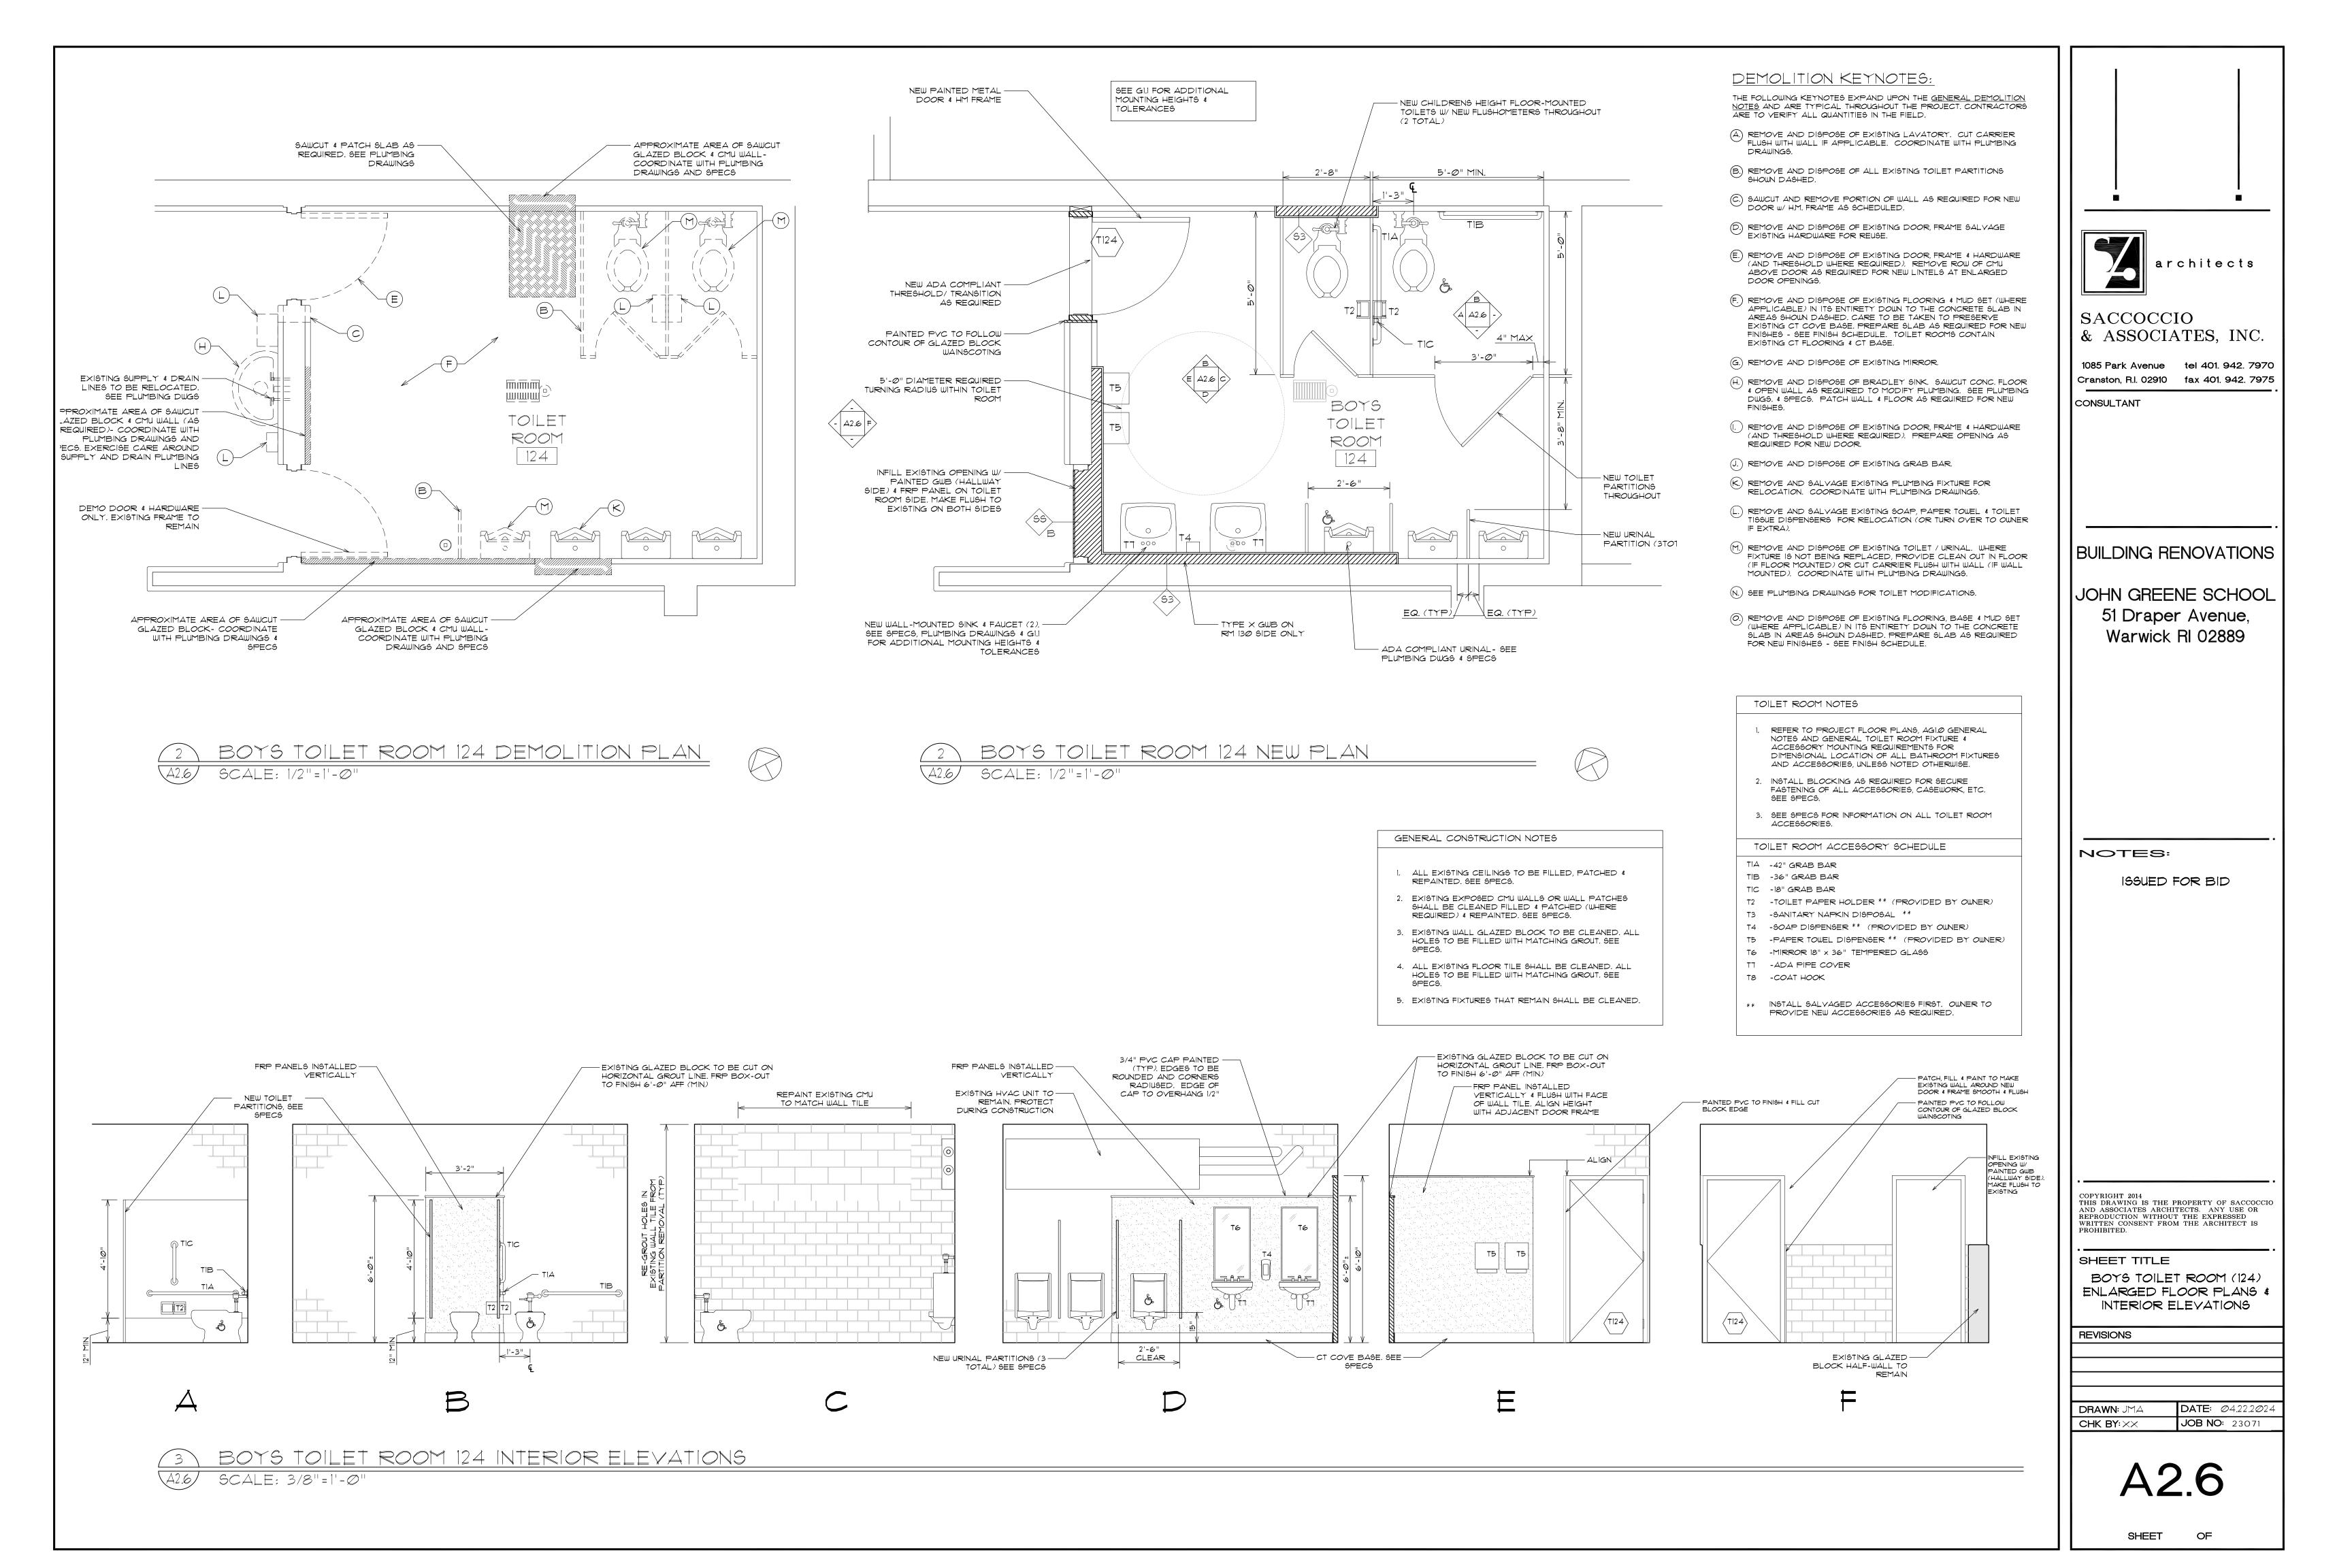
DEMOLITION KEYNOTES:	
THE FOLLOWING KEYNOTES EXPAND UPON THE <u>GENERAL DEMOLITION</u> <u>NOTES</u> AND ARE TYPICAL THROUGHOUT THE PROJECT, CONTRACTORS ARE TO VERIFY ALL QUANTITIES IN THE FIELD,	
(A.) REMOVE AND DISPOSE OF EXISTING LAVATORY. CUT CARRIER FLUSH WITH WALL IF APPLICABLE. COORDINATE WITH PLUMBING DRAWINGS.	
(B.) REMOVE AND DISPOSE OF ALL EXISTING TOILET PARTITIONS SHOWN DASHED.	
(C.) SAWCUT AND REMOVE PORTION OF WALL AS REQUIRED FOR NEW DOOR $_{\rm W}/$ H.M. FRAME AS SCHEDULED.	
\bigcirc REMOVE AND DISPOSE OF EXISTING DOOR, FRAME SALVAGE EXISTING HARDWARE FOR REUSE.	
(E.) REMOVE AND DISPOSE OF EXISTING DOOR, FRAME & HARDWARE (AND THRESHOLD WHERE REQUIRED). REMOVE ROW OF CMU ABOVE DOOR AS REQUIRED FOR NEW LINTELS AT ENLARGED DOOR OPENINGS.	architects
F. REMOVE AND DISPOSE OF EXISTING FLOORING & MUD SET (WHERE APPLICABLE) IN ITS ENTIRETY DOWN TO THE CONCRETE SLAB IN AREAS SHOWN DASHED. CARE TO BE TAKEN TO PRESERVE EXISTING CT COVE BASE. PREPARE SLAB AS REQUIRED FOR NEW FINISHES - SEE FINISH SCHEDULE. TOILET ROOMS CONTAIN EXISTING CT FLOORING & CT BASE.	SACCOCCIO & ASSOCIATES, INC.
G.) REMOVE AND DISPOSE OF EXISTING MIRROR. (\widehat{H} .) REMOVE AND DISPOSE OF BRADLEY SINK. SAWCUT CONC. FLOOR	1085 Park Avenue tel 401. 942. 79 Cranston, R.I. 02910 fax 401. 942. 79
4 OPEN WALL AS REQUIRED TO MODIFY PLUMBING. SEE PLUMBING DWGS. 4 SPECS. PATCH WALL 4 FLOOR AS REQUIRED FOR NEW FINISHES.	CONSULTANT
 (I.) REMOVE AND DISPOSE OF EXISTING DOOR, FRAME & HARDWARE (AND THRESHOLD WHERE REQUIRED). PREPARE OPENING AS REQUIRED FOR NEW DOOR. (J.) REMOVE AND DISPOSE OF EXISTING GRAB BAR. 	
(K.) REMOVE AND SALVAGE EXISTING PLUMBING FIXTURE FOR RELOCATION. COORDINATE WITH PLUMBING DRAWINGS.	
L. REMOVE AND SALVAGE EXISTING SOAP, PAPER TOWEL & TOILET TISSUE DISPENSERS FOR RELOCATION (OR TURN OVER TO OWNER IF EXTRA).	
M. REMOVE AND DISPOSE OF EXISTING TOILET / URINAL. WHERE FIXTURE IS NOT BEING REPLACED, PROVIDE CLEAN OUT IN FLOOR (IF FLOOR MOUNTED) OR CUT CARRIER FLUSH WITH WALL (IF WALL MOUNTED). COORDINATE WITH PLUMBING DRAWINGS.	BUILDING RENOVATION
 N. SEE PLUMBING DRAWINGS FOR TOILET MODIFICATIONS. O. REMOVE AND DISPOSE OF EXISTING FLOORING, BASE & MUD SET (WHERE APPLICABLE) IN ITS ENTIRETY DOWN TO THE CONCRETE SLAB IN AREAS SHOWN DASHED. PREPARE SLAB AS REQUIRED FOR NEW FINISHES - SEE FINISH SCHEDULE. 	JOHN GREENE SCHOC 51 Draper Avenue, Warwick RI 02889
TOILET ROOM NOTES	
1. REFER TO PROJECT FLOOR PLANS, AGLØ GENERAL NOTES AND GENERAL TOILET ROOM FIXTURE & ACCESSORY MOUNTING REQUIREMENTS FOR DIMENSIONAL LOCATION OF ALL BATHROOM FIXTURES AND ACCESSORIES, UNLESS NOTED OTHERWISE.	
2. INSTALL BLOCKING AS REQUIRED FOR SECURE FASTENING OF ALL ACCESSORIES, CASEWORK, ETC. SEE SPECS.	
3. SEE SPECS FOR INFORMATION ON ALL TOILET ROOM ACCESSORIES.	
TOILET ROOM ACCESSORY SCHEDULE TIA -42" GRAB BAR	NOTES:
TIB -36" GRAB BAR TIC -18" GRAB BAR T2 -TOILET PAPER HOLDER ** (PROVIDED BY OWNER)	ISSUED FOR BID
T2-TOILET PAPER HOLDER ** (PROVIDED BY OWNER)T3-SANITARY NAPKIN DISPOSAL **T4-SOAP DISPENSER ** (PROVIDED BY OWNER)	
T5 -PAPER TOWEL DISPENSER ** (PROVIDED BY OWNER) T6 -MIRROR 18" × 36" TEMPERED GLASS	
TI - ADA PIPE COVER T8 - COAT HOOK	
** INSTALL SALVAGED ACCESSORIES FIRST, OWNER TO PROVIDE NEW ACCESSORIES AS REQUIRED.	
GENERAL CONSTRUCTION NOTES	
1. ALL EXISTING CEILINGS TO BE FILLED, PATCHED 4	
REPAINTED. SEE SPECS. 2. EXISTING EXPOSED CMU WALLS OR WALL PATCHES SUBALL BE CLEANED FULLED (WULLED	
SHALL BE CLEANED FILLED & PATCHED (WHERE REQUIRED) & REPAINTED. SEE SPECS.	
3. EXISTING WALL GLAZED BLOCK TO BE CLEANED. ALL HOLES TO BE FILLED WITH MATCHING GROUT. SEE SPECS.	COPYRIGHT 2014 THIS DRAWING IS THE PROPERTY OF SACCOCC
4. ALL EXISTING FLOOR TILE SHALL BE CLEANED. ALL HOLES TO BE FILLED WITH MATCHING GROUT. SEE SPECS.	AND ASSOCIATES ARCHITECTS. ANY USE OR REPRODUCTION WITHOUT THE EXPRESSED WRITTEN CONSENT FROM THE ARCHITECT IS PROHIBITED.
5. EXISTING FIXTURES THAT REMAIN SHALL BE CLEANED.	
	GIRLS TOILET ROOM (136) ENLARGED FLOOR PLANS INTERIOR ELEVATIONS
	REVISIONS
	DRAWN: JMA DATE: Ø4.22.2Ø CHK BY: XX JOB NO: 23071
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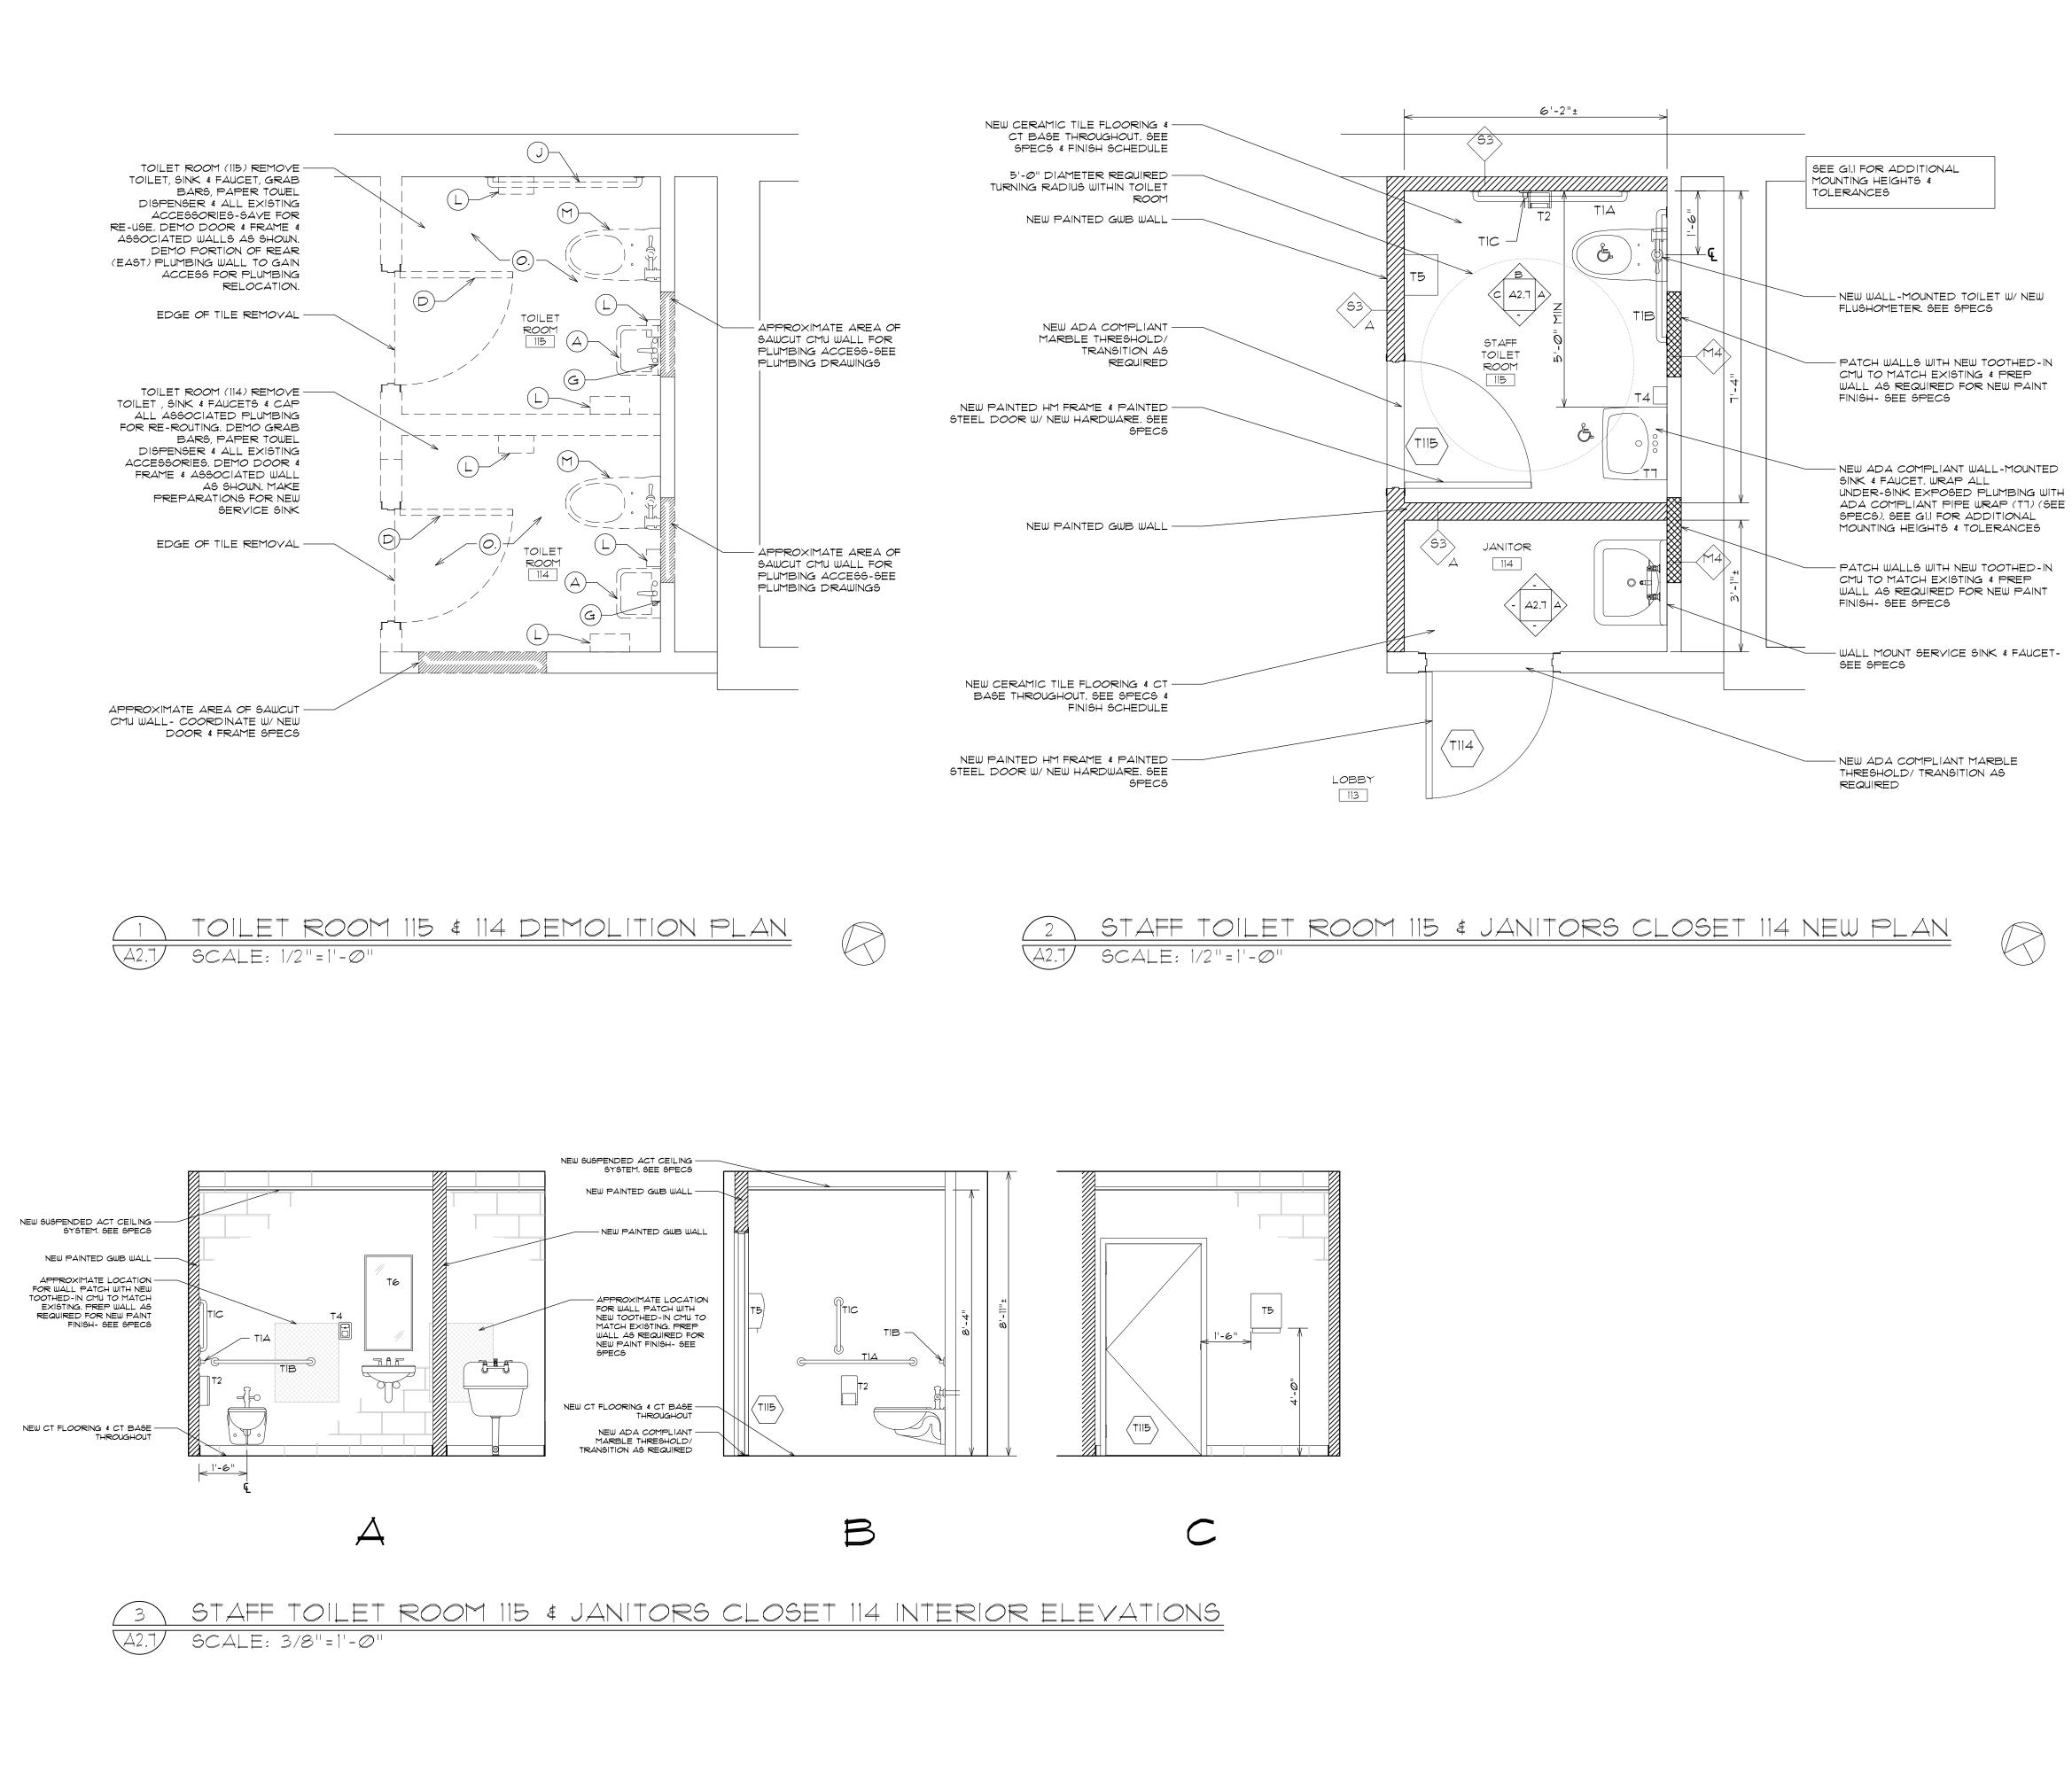


DEMOLITION KEYNOTES: The following keynotes expand upon the general demolition	
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F. REMOVE AND DISPOSE OF EXISTING FLOORING & MUD SET (WHERE APPLICABLE) IN ITS ENTIRETY DOWN TO THE CONCRETE SLAB IN AREAS SHOWN DASHED. CARE TO BE TAKEN TO PRESERVE EXISTING CT COVE BASE. PREPARE SLAB AS REQUIRED FOR NEW FINISHES - SEE FINISH SCHEDULE. TOILET ROOMS CONTAIN EXISTING CT FLOORING & CT BASE.	SACCOCCIO & ASSOCIATES, INC.
(G) REMOVE AND DISPOSE OF EXISTING MIRROR.	1085 Park Avenue tel 401. 942. 7970
 (H.) REMOVE AND DISPOSE OF BRADLEY SINK. SAWOUT CONC. FLOOR ¢ OPEN WALL AS REQUIRED TO MODIFY PLUMBING. SEE PLUMBING DWGS. ¢ SPECS. PATCH WALL ¢ FLOOR AS REQUIRED FOR NEW FINISHES. 	Cranston, R.I. 02910 fax 401. 942. 7975
 REMOVE AND DISPOSE OF EXISTING DOOR, FRAME & HARDWARE (AND THRESHOLD WHERE REQUIRED). PREPARE OPENING AS REQUIRED FOR NEW DOOR. REMOVE AND DISPOSE OF EXISTING GRAB BAR. 	
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N.) SEE PLUMBING DRAWINGS FOR TOILET MODIFICATIONS.	JOHN GREENE SCHOOL
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3. EXISTING WALL GLAZED BLOCK TO BE CLEANED, ALL HOLES TO BE FILLED WITH MATCHING GROUT, SEE SPECS.	COPYRIGHT 2014
4. ALL EXISTING FLOOR TILE SHALL BE CLEANED. ALL HOLES TO BE FILLED WITH MATCHING GROUT. SEE	THIS DRAWING IS THE PROPERTY OF SACCOCCIO AND ASSOCIATES ARCHITECTS. ANY USE OR REPRODUCTION WITHOUT THE EXPRESSED WRITTEN CONSENT FROM THE ARCHITECT IS PROHIBITED.
SPECS. 5. EXISTING FIXTURES THAT REMAIN SHALL BE CLEANED.	SHEET TITLE
	BOYS TOILET ROOM (144) ENLARGED FLOOR PLANS & INTERIOR ELEVATIONS
	REVISIONS
	DRAWN: JMA DATE: Ø4.22.2Ø24 CHK BY: XX JOB NO: 23071
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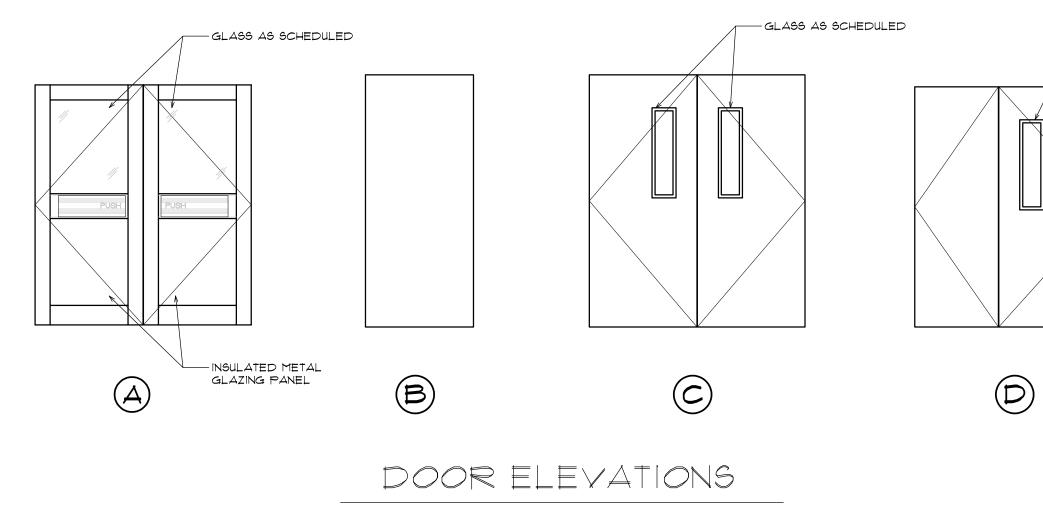




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REMOVE AND DISPOSE OF EXISTING MIRROR.	1085 Park Avenue tel 401. 942. 79 Cranston, R.I. 02910 fax 401. 942. 79
(H.) REMOVE AND DISPOSE OF BRADLEY SINK. SAWCUT CONC. FLOOR & OPEN WALL AS REQUIRED TO MODIFY PLUMBING. SEE PLUMBING DWGS. & SPECS. PATCH WALL & FLOOR AS REQUIRED FOR NEW FINISHES.	CONSULTANT
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(N.) SEE PLUMBING DRAWINGS FOR TOILET MODIFICATIONS.	JOHN GREENE SCHOO
(O.) REMOVE AND DISPOSE OF EXISTING FLOORING, BASE & MUD SET	51 Draper Avenue,
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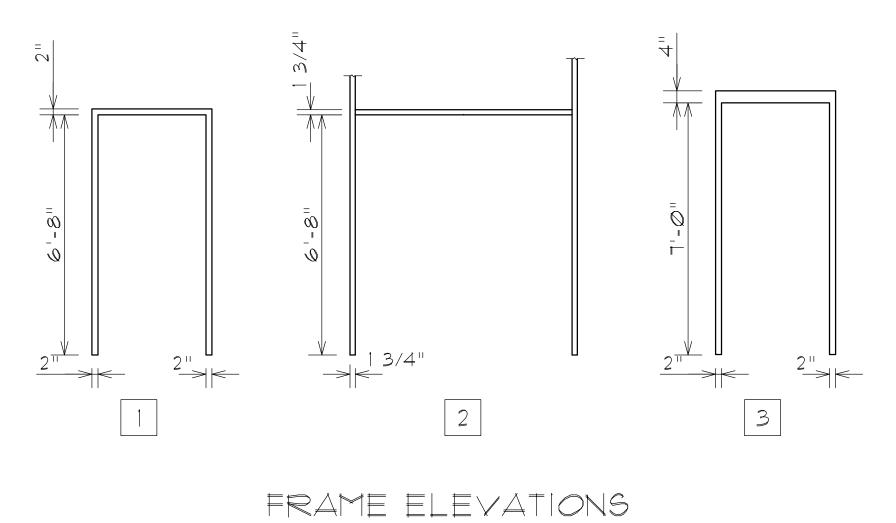
SHEET OF

							DOOR	SCHE	DULE						
	LOCATION	DOOR SI	ZE	DC	OR TY	PE	FR	RAME T	T PE	D	ETAILS		LABEL	HRD. SET	REMARKS
DOOR NO	. ROOM NAME	ω H	Ť	ELEV.	MAT,	GLAZ.	ELEV.	MAT,	FINISH	HEAD	JAMB	SILL			
100-A	MAIN ENTRY	3'-Ø" × 6'-8" >	< 13/4"	A	ALUM	FERG	2	ALUM	-	-	-	-	-	1	BASED ON EFCO D518 WIDE STILE WITH EXIT DEVICE
100-A	MAIN ENTRY	3'-Ø" × 6'-8" ×	< 13/4"	А	ALUM	FERG	2	ALUM	-	-	-	-	-	-	BASED ON EFCO D518 WIDE STILE WITH EXIT DEVICE
100-B	FOYER	3'-Ø" × 6'-8" >	< 13/4"	А	ALUM	TEMP	2	ALUM	-	-	-	-	-	-	BASED ON EFCO D518 WIDE STILE WITH EXIT DEVICE
100-B	FOYER	3'-Ø" × 6'-8" ×	K 13/4"	А	ALUM	TEMP	2	ALUM	-	-	-	-	-	-	BASED ON EFCO D518 WIDE STILE WITH EXIT DEVICE
1Ø2 – A	HALLWAY 102	3'-Ø" × 6'-8" ×	< 13/4"	D	GHM	FERG	EXIST	-	-	-	-	-	-	2	EXISTING FRAME TO REMAIN
1Ø2 – A	HALLWAY 102	2'-4" × 6'-8" ×	1 3/4"	D	GHM	FERG	EXIST	-	-	-	-	-	-	2	EXISTING FRAME TO REMAIN
102-B	HALLWAY 102	3'-Ø" × 7'-Ø" ×	< 13/4"	С	GHM	FERG	EXIST	-	-	-	-	-	-	2	EXISTING FRAME TO REMAIN
102-B	HALLWAY 102	3'-Ø" × 7'-Ø" ×	< 13/4"	С	GHM	FERG	EXIST	-	-	-	-	-	-	2	EXISTING FRAME TO REMAIN
1Ø2-C	HALLWAY 102	3'-0" × 6'-8" ×	< 13/4"	D	GHM	FERG	EXIST	-	-	-	-	-	-	2	EXISTING FRAME TO REMAIN
1Ø2-C	HALLWAY 102	2'-4" × 6'-8" ×	1 3/4"	D	GHM	FERG	EXIST	-	-	-	-	-	-	2	EXISTING FRAME TO REMAIN
1Ø3-B	CORRIDOR 103B	3'-0" × 6'-8" ×	<13/4"	D	GHM	FERG	EXIST	-	-	-	-	-	-	2	EXISTING FRAME TO REMAIN
103-B	CORRIDOR 103B	2'-4" × 6'-8" ×	1 3/4"	D	GHM	FERG	EXIST	-	-	-	-	-	-	2	EXISTING FRAME TO REMAIN
11Ø	CLASSROOM 110	-	-	-	-	-	-	-	-	-	-	-	-	-	EXISTING DOOR & FRAME TO REMAIN. NEW ELECTRIC STRIKE REQUIRED
111	CLASSROOM III	-	-	-	-	-	-	-	-	-	-	-	-	-	EXISTING DOOR & FRAME TO REMAIN. NEW ELECTRIC STRIKE REQUIRED
114	JANITOR	3'-Ø" × 7'-Ø" ×	<13/4"	в	ΗМ	-	3	ΗМ	PAINT	E	С	F	(45 MIN)	5	
115	STAFF TOILET ROOM	3'-Ø" × 7'-Ø" ×	<13/4"	в	ΗМ	-	3	ΗМ	PAINT	в	А	F	(45 MIN)	4	
124	BOYS TOILET ROOM	3'-Ø" × 6'-8" ×	<13/4"	в	HМ	-	1	ΗМ	PAINT	D	С	F	-	3	
13Ø	GIRLS TOILET ROOM	3'-0" × 6'-8" ×	<13/4"	в	HМ	-	1	HМ	PAINT	D	С	F	-	3	
138	CLASSROOM 138	-	_	-	-	-	-	-	-	-	-	-	-	6	EXISTING DOOR & FRAME TO REMAIN. NEW ELECTRIC STRIKE REQUIRED
14Ø	CLASSROOM 140	-	-	-	-	-	-	-	-	-	-	-	-	6	EXISTING DOOR & FRAME TO REMAIN. NEW ELECTRIC STRIKE REQUIRED



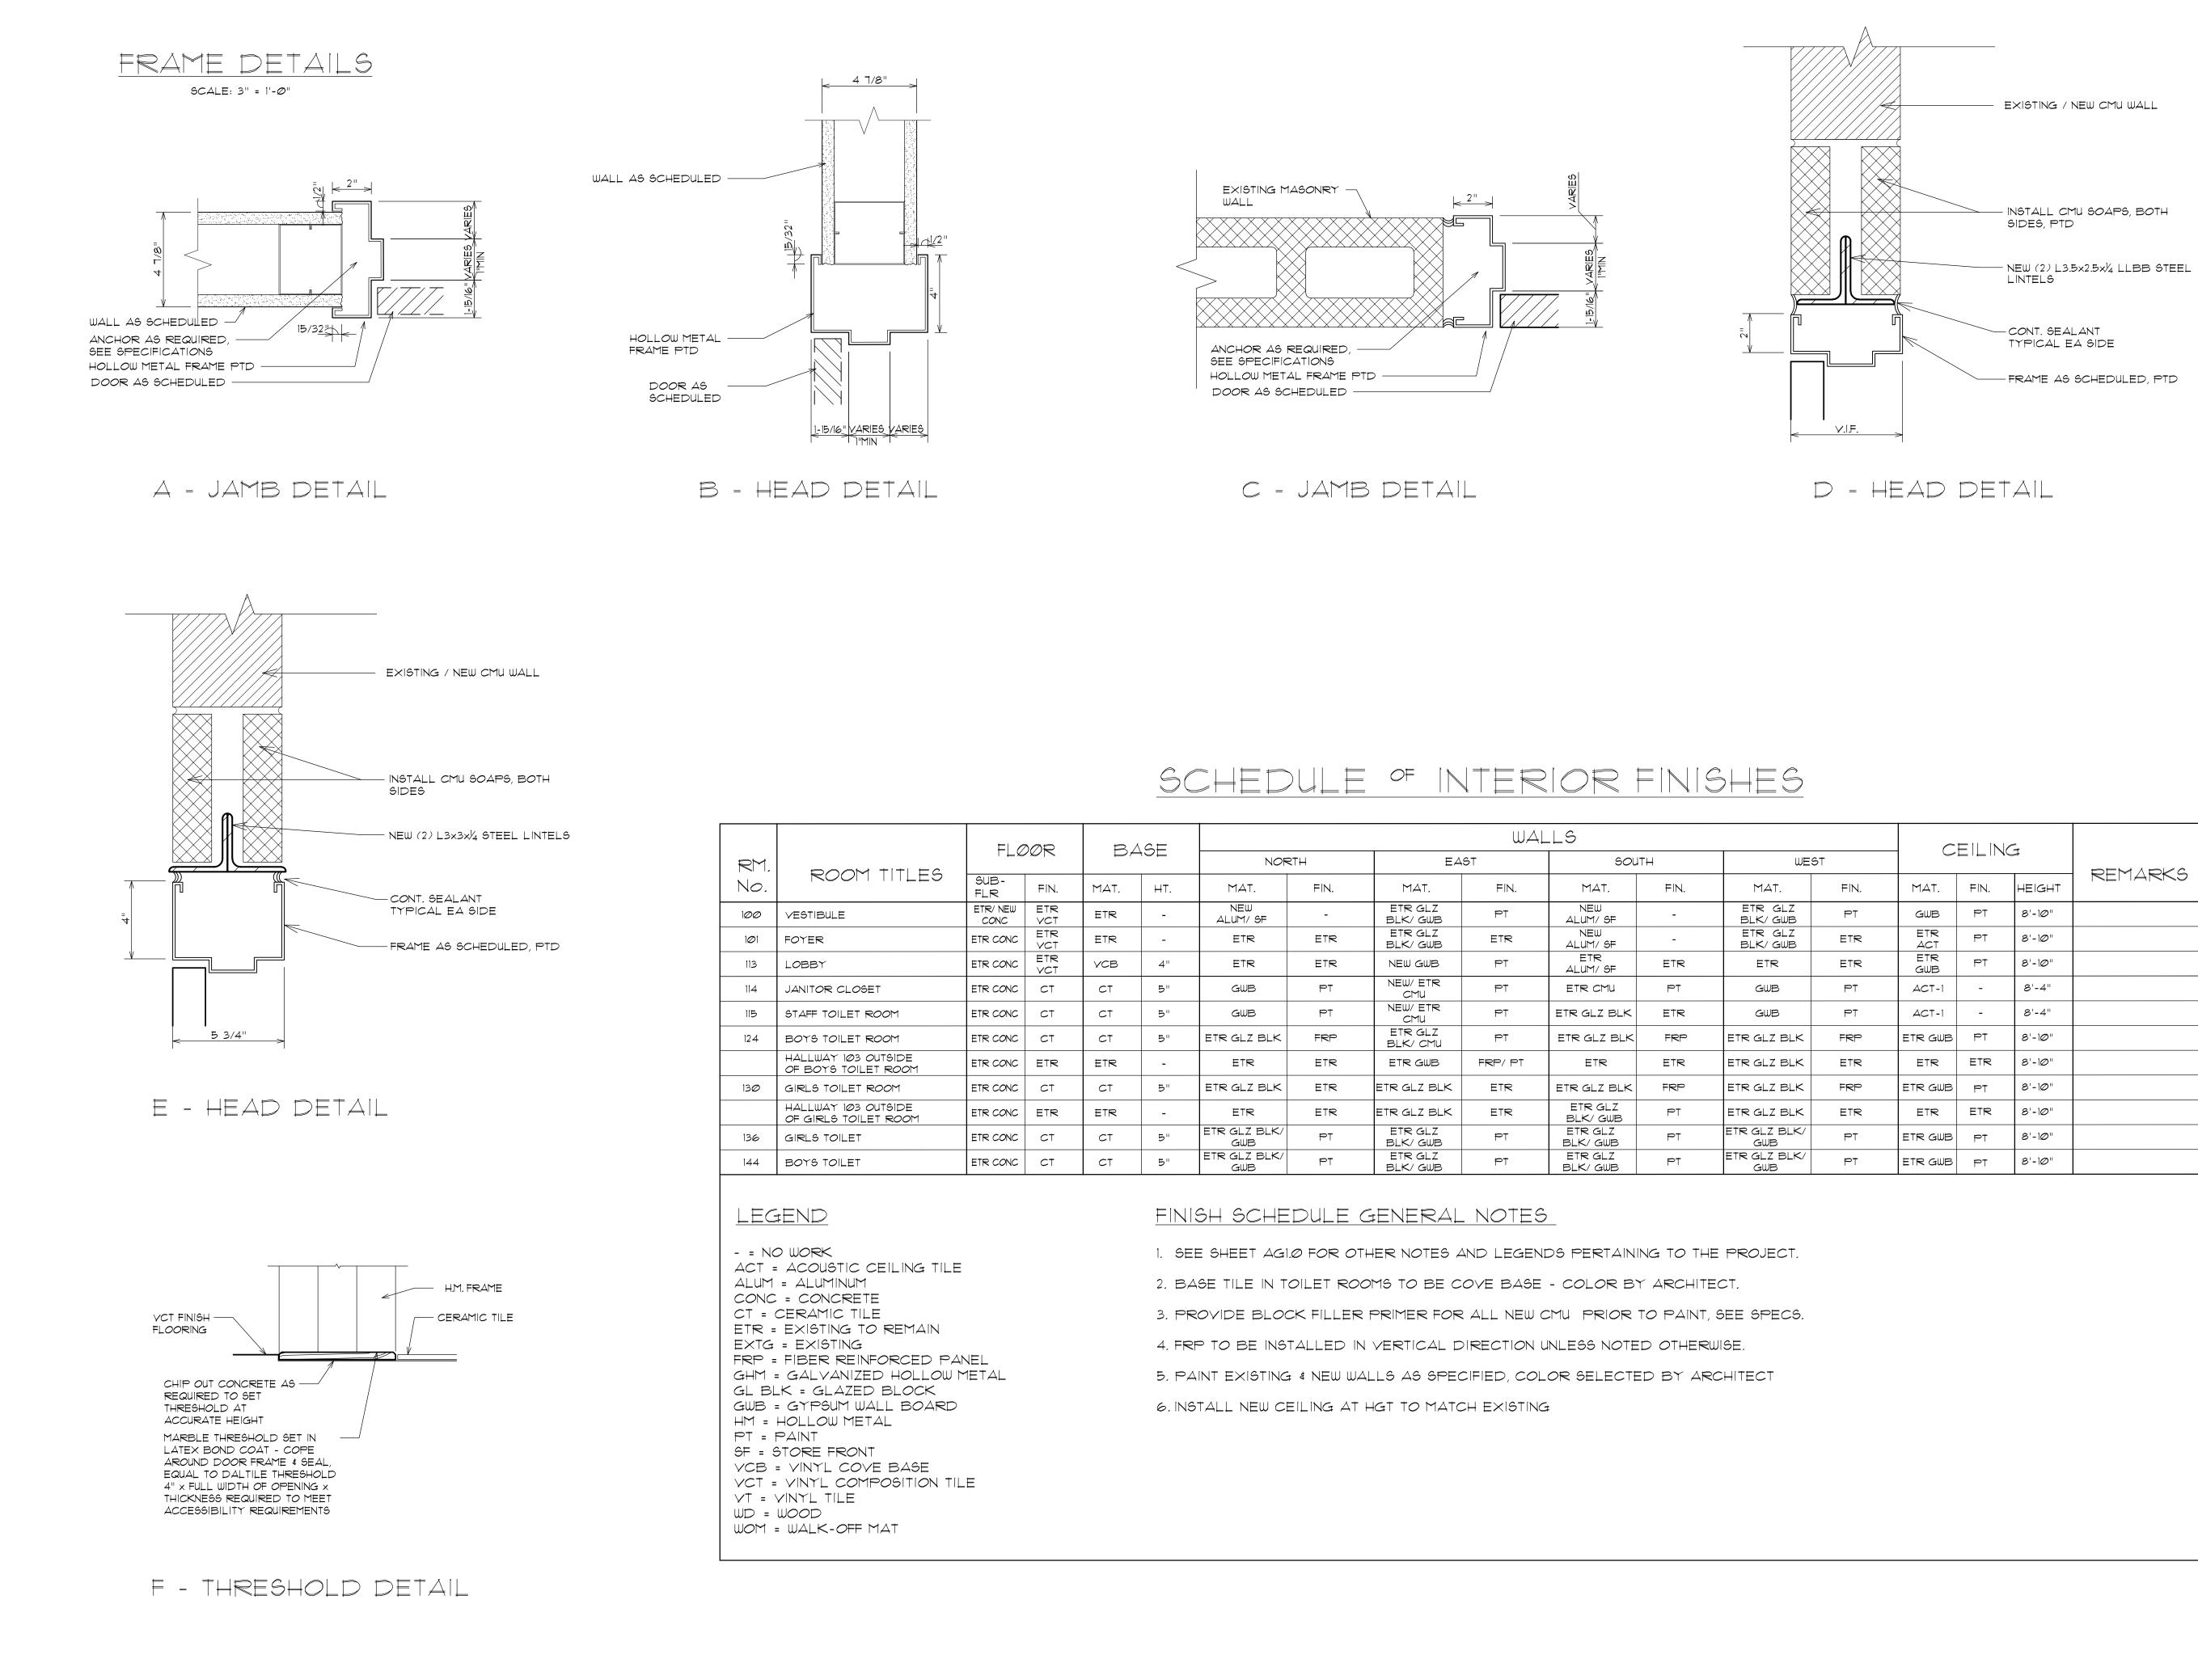
SCALE: 3/8"=1'-Ø"

GLASS AS SCHEDULED



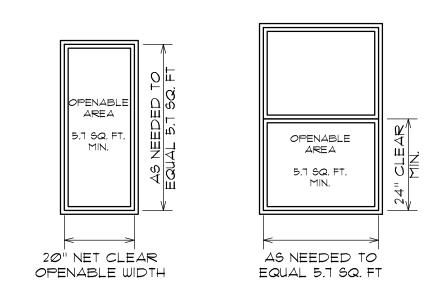
SCALE: 3/8"=1'-Ø"

LEGEND - = NO WORK ALUM = ALUMINUM CONC = CONCRETE CLR = CLEAR FINISH ETR = EXISTING TO REMAIN EXTG = EXISTING FERG = FORCED ENTRY RESISTANT GLASS FRYSTY = FIRE RATED SAFETY GLAZING GHM = GALVANIZED HOLLOW METAL GWB = GYPSUM WALL BOARD HM = HOLLOW METAL INSUL = INSULATED MAS = MASONRY MAT = MATERIAL MT = MATERIAL MT = MARBLE THRESHOLD PT = PAINT RM = RCOM RS = REDUCER STRIP S4F = STAIN AND FINISH TS = TRANSITION STRIP TEMP = TEMPERED WD = WOOD	Image: Second system SACCOCCIO & ASSOCIATES, INC. N85 Park Avenue tel 401.942.7970 Cranston, R.I. 02910 fax 401.942.7975 CONSULTANT
 DOOR SCHEDULE GENERAL NOTES: 1. ALL NEW DOORS AND FRAMES SCHEDULED TO BE INSTALLED SHALL BE FIELD VERIFIED FOR ALL DIMENSIONS AND CONDITIONS PRIOR TO FABRICATION. 2. ALL NEW HY DOORS AND ALL HY FRAMES ARE TO BE PAINTED, UNLESS NOTED OTHER WISE - COLOR TO MATCH EXISTING. 3. EXIT DEVICES AND DOOR GLAZING 4 FRAMES TO BE PROVIDED PER APPLICABLE CODE. 4. FILL HOLLOW METAL FRAMES WITH SOUND ATTENUATION BATT INSULATION. 5. HOLLOW METAL FRAMES PROVIDE THREE WALL AND ONE FLOOR ANCHOR BOTH SIDES OF DOOR, ANCHOR TYPE APPROPRIATE FOR WALL TYPE, UNLESS NOTED OTHER WISE. SEE SPECS. 6. SEE DOOR FRAME DETAILS A3.0. 1. SEE SHEET AGI<i>Ø</i> FOR OTHER NOTES AND LEGENDS PERTAINING TO THE REPOJECT. 8. FROVIDE NEW MARBLE THRESHOLD PER DETAIL FASI AT TOILET ROOM DOORS WHERE WE ARE REPLACING THE FRAME. 9. PAINT EXISTING FRAMES AS NOTED COLOR SELECTED BY ARCHITECT. 10. PROVIDE WEATHER STRIPPING AT ALL EXTERIOR DOORS - SEE SPECS. 	BUILDING RENOVATIONS JOHN GREENE SCHOOL 51 Draper Avenue, Warwick RI 02889
	COPYRIGHT 2014 THIS DRAWING IS THE PROPERTY OF SACCOCCIO AND ASSOCIATES ARCHITECTS ANY USE OR BRODUCTION WITHOUT THE EXPRESSED WRITTEN CONSENT FROM THE ARCHITECT IS PROHIBITED. SHEET TITLE DOOR TYPES & SCHEDULES REVISIONS DRAWN: JMA DATE: 04.22.004 CHK BY: XX JOB NO: 23071 AGAGO SHEET OF



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ITLES	SUB- Flr	FIN.	MAT.	HT.	MAT.	FIN.	MAT.	FIN.	MAT.	FIN.	MAT.	FIN.	MAT.	FIN.	HEIGHT	REMARKS
	ETR/ NEW CONC	ETR VCT	ETR	-	NEW ALUM/ SF	-	ETR GLZ BLK/ GWB	P†	NEW ALUM/ SF	-	ETR GLZ BLK/GWB	PŤ	GWB	PT	8'-10"	
	ETR CONC	ETR VCT	ETR	-	ETR	ETR	ETR GLZ BLK/ GWB	ETR	NEW ALUM/ SF	-	ETR GLZ BLK/GWB	ETR	ETR Act	PT	8'-1Ø"	
	ETR CONC	ETR VCT	∨СВ	4"	ETR	ETR	NEW GWB	PT	ETR ALUM/ SF	ETR	ETR	ETR	ETR GWB	PT	8'-10"	
	ETR CONC	CŤ	CT	5"	GWB	PT	NEW/ ETR CMU	PT	ETR CMU	PT	GWB	PT	ACT-1	-	8'-4"	
Μ	ETR CONC	CT	CT	5"	GWB	PT	NEW/ ETR CMU	PŤ	ETR GLZ BLK	ETR	GWB	PT	ACT-1	-	8'-4"	
Μ	ETR CONC	CT	CT	5"	ETR GLZ BLK	FRP	ETR GLZ BLK/ CMU	PT	ETR GLZ BLK	FRP	ETR GLZ BLK	FRP	ETR GWB	PT	8'-10"	
DE 200M	ETR CONC	ETR	ETR	-	ETR	ETR	ETR GWB	FRP/ PT	ETR	ETR	ETR GLZ BLK	ETR	ETR	ETR	8'-10"	
Μ	ETR CONC	CT	ст	5"	ETR GLZ BLK	ETR	ETR GLZ BLK	ETR	ETR GLZ BLK	FRP	ETR GLZ BLK	FRP	ETR GWB	PT	8'-10"	
NDE 200M	ETR CONC	ETR	ETR	-	ETR	ETR	ETR GLZ BLK	ETR	ETR GLZ BLK/ GWB	PT	ETR GLZ BLK	ETR	ETR	ETR	8'-10"	
	ETR CONC	CT	CŤ	Б"	ETR GLZ BLK/ GWB	PT	ETR GLZ BLK/ GWB	PT	ETR GLZ BLK/ GWB	PT	ETR GLZ BLK/ GWB	PT	ETR GWB	PT	8'-10"	
	ETR CONC	СТ	CT	5"	ETR GLZ BLK/ GWB	PT	ETR GLZ BLK/ GWB	PT	ETR GLZ BLK/ GWB	PT	ETR GLZ BLK/ GWB	PT	ETR GWB	PT	8'-10"	

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REVISIONS
DRAWN: JMA DATE: Ø4.22.2Ø24 CHK BY: XX JOB NO: 23071
A3.1
SHEET OF

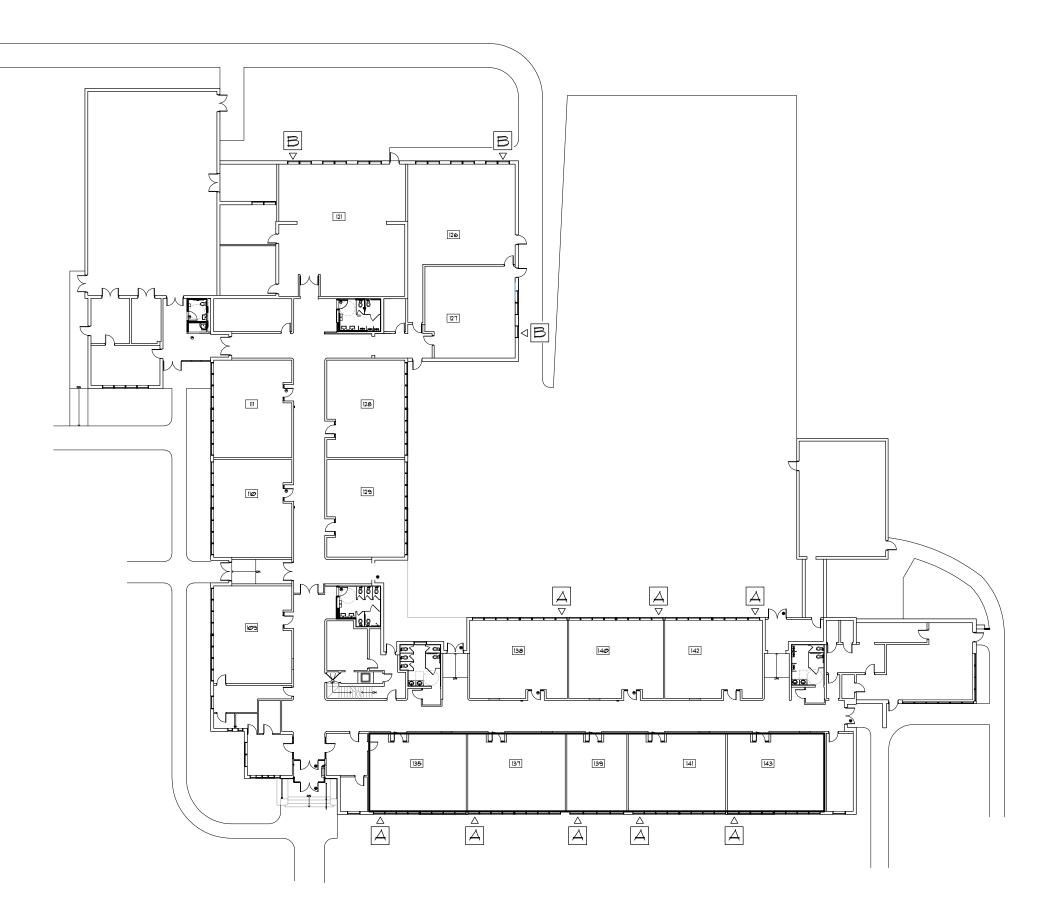


EGRESS WINDOW REQUIREMENTS

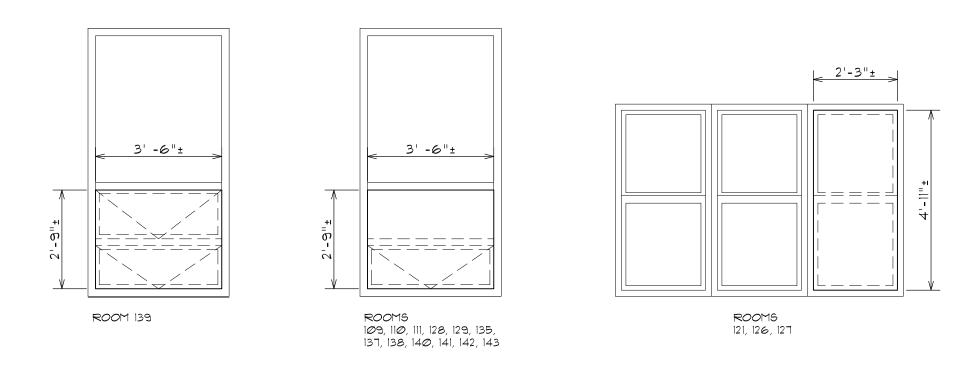
SCALE: 3/8"=1'-Ø"

GENERAL WINDOW & DOOR NOTES THE CONTRACTOR/S SHALL:

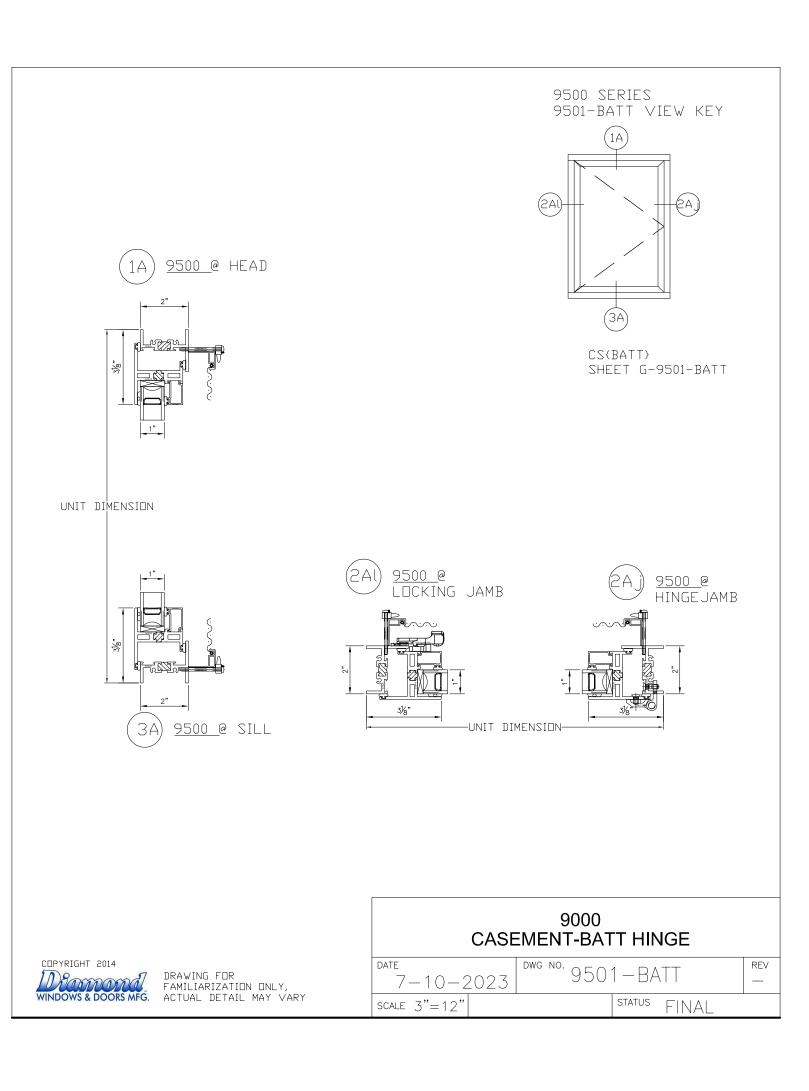
- 1. CONTRACTOR TO CONFIRM ALL NEW WINDOW LOCATIONS & SITE DIMENSIONS PRIOR TO FABRICATION & CONSTRUCTION
- 2. ALL WINDOW FLASHING MATERIALS AND METHODS SHALL CONFORM TO THE REQUIREMENTS OF THE ENERGY & ENVIRONMENTAL BUILDING ASSOCIATIONS GUIDELINES FOR WATER MANAGEMENT AROUND WINDOW OPENINGS AS WELL AS SPECIFICATIONS.
- 3. SPACE BETWEEN WINDOW FRAMES AND ROUGH OPENINGS ARE TO BE FILLED WITH LOW EXPANSION FOAM UNLESS WINDOW/ DOOR MANUFACTURER REQUIREMENT STATES OTHERWISE.
- 4. PROVIDE BLOCKING (FIRE-TREATED WHERE REQUIRED) AS REQUIRED FOR THE INSTALLATION OF ALL WINDOW TRIM/ CASINGS, SILLS, ETC. AT ALL WINDOWS.



1 LOCUS MAP A3.1/ NTS

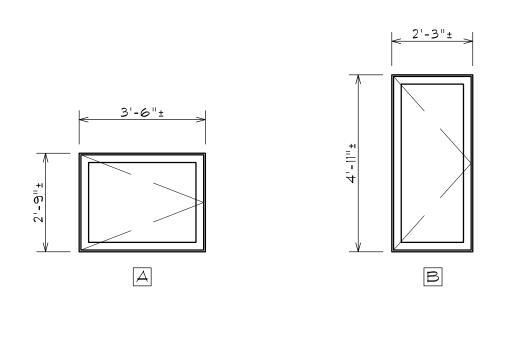






 \frown (A3.)

WINDOW DETAILS SCALE: 3"=1'-0"



WINDOW ELEVATIONS SCALE: 3/8"=1'-Ø"

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A3.2 SHEET OF

PLUMBING DEMOLITION NOTES

- 1. PRIOR TO SUBMITTING BID, THE CONTRACTOR SHALL VISIT THE PROJECT SITE TO BECOME FAMILIAR WITH ALL EXISTING CONDITIONS AND TO DETERMINE THE EXTENT OF WORK TO REMOVE THE EXISTING PLUMBING SYSTEM INDICATED TO BE REMOVED. IF DISCREPANCIES EXIST BETWEEN DRAWINGS AND/OR SITE CONDITIONS, THE CONTRACTOR SHALL NOTIFY THE ARCHITECT/ENGINEER AND THE OWNER PRIOR TO SIGNING OF CONTRACT. REQUESTS FOR COMPENSATION FOR EXTRA WORK, WHICH WOULD HAVE BEEN EVIDENT BY COMPLIANCE WITH THE PREVIOUS STATEMENT, WILL NOT BE CONSIDERED.
- 2. DISCONNECT, DISMANTLE AND DEMOLISH ALL EXISTING DOMESTIC WATER, AND SANITARY WASTE & VENT PIPING BACK TO RESPECTIVE MAINS. EXISTING PLUMBING FIXTURES AND EQUIPMENT SHALL BE REMOVED IN THEIR ENTIRETY AND PROPERLY DISPOSED OF. EXISTING STORM DRAINAGE SUPPLY PIPING AND ROOF DRAINS SHALL REMAIN. REMOVE ALL DEBRIS AND DISCONNECTED EQUIPMENT AND CLEAN OUT EXISTING SPACES. REFER TO ARCHITECTURAL AND PLUMBING CONTRACT DOCUMENTS FOR DEMOLITION WORK.
- 3. REMOVE ALL EXISTING DOMESTIC, SANITARY WASTE & VENT PIPING SYSTEMS INDICATED TO BE DEMOLISHED AND CAP BACK TO RESPECTIVE EXISTING MAIN LINES TO REMAIN. REMOVE AND DISCARD EXISTING PLUMBING ABANDONED STACKS, MAINS, BRANCHES AND VENTS SERVING FIXTURES TO BE DEMOLISHED. OBTAIN EXISTING RECORD DRAWINGS FROM OWNER.
- 4. VERIFY PIPING SERVES ONLY PLUMBING FIXTURES INDICATED FOR DEMOLITION BEFORE SHUT-DOWN FOR DISCONNECTION. IDENTIFY EXISTING PIPING WHICH SERVES FIXTURES TO REMAIN. PROMPTLY NOTIFY ARCHITECT OF ACTIVE PIPING TO BE MAINTAINED WHEN LOCATED IN PARTITIONS TO BE DEMOLISHED.
- 5. COORDINATE ALL SHUT-DOWNS, TIE-INS, ETC., WITH THE G.C. ELECTRICAL MAKE-SAFE OF PLUMBING EQUIPMENT REQUIRING DEMOLITION SHALL BE COMPLETED BY THE ELECTRICAL SUBCONTRACTOR.
- 6. DEMOLITION SUBCONTRACTOR MUST PROTECT EXISTING SLAB, WALL, FENCING AND BUILDING STRUCTURE DURING DEMOLITION PHASE. DAMAGE TO EXISTING STRUCTURE SHALL BE REPAIRED AT DEMOLITION SUBCONTRACTORS EXPENSE.
- 7. ALL DEMOLITION WORK PERFORMED SHALL BE DONE IN ACCORDANCE WITH THE APPLICABLE NATIONAL, STATE AND LOCAL CODES, LAWS AND ORDINANCES.
- 8. EXISTING UNDERGROUND PIPING NOTE: CONTRACTOR SHALL SCOPE AND VERIFY INVERT ELEVATIONS OF ALL EXISTING UNDERGROUND SANITARY WASTE PIPING, IN AREA OF WORK, TO DETERMINE EXACT CONNECTION POINTS FOR NEW UNDERGROUND PIPING TO EXISTING PIPING PRIOR TO INSTALLATION. CONTRACTOR SHALL ALSO UNCLOG (ROOTER) AND FLUSH CLEAN EXISTING UNDERGROUND SANITARY WASTE PIPING AS REQUIRED. PROVIDE AS-BUILT DOCUMENTATION OF EXISTING UNDERGROUND PIPING LAYOUT TO OWNER PRIOR TO COMMENCEMENT OF DEMOLITION WORK.

SYMBOL	DESCRIPTION		FIXTURE				FIXTURE		SERVICES					REMARKS
STMDUL	DESCRIPTION	MANUFACTURER	MODEL	TYPE	SIZE	MANUFACTURER	MODEL	TYPE	<u>s/w</u>	۷	CW	HW	TW	
<u>WC-1</u>	WATER CLOSET - YOUTH	AMERICAN STANDARD	2599.001	FLOOR MOUNTED	1.28 GPF	SLOAN	G2 8111-1.28	SENSOR FLUSH VALVE	4"	2"	1"	-	-	VITREOUS CHINA, ELONGATED, LOW CONSUMPTION SENSOR FLUSH VALVE. PROVIDE OPEN FRONT SEAT AMERICAN STANDARD #5901.100 OR EQUAL. PROV HEAVY DUTY CHROME PLATED SUPPLY & STOP. COORDINATE INSTALLATION OF FIXTURE WITH ARCHITECTURAL DRAWINGS.(15" TOP OF SEAT HEIGHT)
<u>WC-2</u>	WATER CLOSET — YOUTH ADA	AMERICAN STANDARD	2599.001	FLOOR MOUNTED	1.28 GPF	SLOAN	G2 8111-1.28	SENSOR FLUSH VALVE	4"	2"	1"	-	_	VITREOUS CHINA, ELONGATED, LOW CONSUMPTION SENSOR FLUSH VALVE. PROVIDE OPEN FRONT SEAT AMERICAN STANDARD #5901.100 OR EQUAL. PROVIDE HEAVY DUTY CHROME PLATED SUPPLY & STOP. BARRIER FREE, ADA COMPLIANT. COORDINATE INSTALLATION OF ADA FIXTURES W/ ARCHITECTURAL DRAWINGS. (15" TOP OF SEAT HEIGHT)
<u>WC-3</u>	WATER CLOSET — ADA	AMERICAN STANDARD	3351.101	WALL MOUNTED	1.28 GPF	SLOAN	G2 8111-1.28	SENSOR FLUSH VALVE	4"	2"	1"	-	_	VITREOUS CHINA, ELONGATED, LOW CONSUMPTION, BATTERY-POWERED, SENSOR FLUSH VALVE. PROVIDE OPEN FRONT SEAT AMERICAN STANDARD #5901. OR EQUAL. PROVIDE W/ WALL CARRIER. PROVIDE HEAVY DUTY CHROME PLATED SUPPLY & STOP. BARRIER FREE, ADA COMPLIANT. COORDINATE INSTALL OF ADA FIXTURES W/ ARCHITECTURAL DRAWINGS. (15" TOP OF SEAT HEIGHT) REMOVE AND REPLACE EXISTING SUPPLY SHUT-OFF VALVES WITH NEW VA
<u>WC-4</u>	WATER CLOSET FLUSH VALVE	_	-	-	1.28 GPF	SLOAN	G2 8111-1.28	SENSOR FLUSH VALVE	-	-	1"	-	-	BATTERY-POWERED SENSOR FLUSH VALVE. INSTALL ON ETR WATER CLOSET. ADA COMPLIANT. COORDINATE INSTALLATION OF ADA FIXTURES W/ ARCHITECTURAL DRAWINGS. REMOVE AND REPLACE EXISTING SUPPLY SHUT-OFF VALVES WITH NEW VALVES.
<u>L-1</u>	LAVATORY	AMERICAN STANDARD	0355.012	WALL MOUNTED	20"x18¼"	CHICAGO	802-E70-317XKABCP	MANUAL	1½"	1½"	1/2"	1/2"	Ι	VITREOUS CHINA, WALL MOUNTED LAVATORY AND 2-HOLE, 4"O.C., 0.5 GPM FAUCET WITH WRISTBLADE HANDLES. PROVIDE AND INSTALL <u>TMV-1</u> UNDER LAVATORY. PROVIDE W/ WALL BRACKETS. PROVIDE GRID DRAIN W/ OVERFLOW. PROVIDE CHROME PLATED HEAVY DUTY OFFSET P-TRAP W/ CLEANOUT, SUPPLIES & STOPS. REMOVE AND REPLACE EXISTING SUPPLY SHUT-OFF VALVES WITH NEW VALVES.
<u>L-2</u>	LAVATORY - ADA	AMERICAN STANDARD	0355.012	WALL MOUNTED	20"×18¼"	CHICAGO	802-E70-317XKABCP	MANUAL	1½"	1½"	1/2"	1/2"	-	VITREOUS CHINA, WALL MOUNTED LAVATORY AND 2-HOLE, 4"O.C., 0.5 GPM FAUCET WITH WRISTBLADE HANDLES. PROVIDE AND INSTALL <u>TMV-1</u> UNDER LAVATORY. PROVIDE W/ WALL BRACKETS. PROVIDE GRID DRAIN W/ OVERFLOW. PROVIDE CHROME PLATED HEAVY DUTY OFFSET P-TRAP W/ CLEANOUT, SUPPLIES & STOPS. PROVIDE TRUEBRO LAVGUARD INSULATION ON EXPOSED PIPING. BARRIER FREE, ADA COMPLIANT. COORDINATE INSTALLATION OF ADA FIXTURES WITH ARCHITECTURAL DRAWINGS. REMOVE AND REPLACE EXISTING SUPPLY SHUT-OFF VALVES WITH NEW VALVES.
<u>U-2</u>	URINAL — ADA	AMERICAN STANDARD	6590.001	WALL HUNG	0.5 GPF	SLOAN	REGAL 183 SFSM-0.5	SENSOR	-	-	3/4"	-	_	TOP-SPUD, LOW CONSUMPTION, BATTERY-POWERED, SENSOR FLUSH VALVE. PROVIDE CONCEALED WALL CARRIER. PROVIDE HEAVY DUTY CHROME PLATED SUPPLY & STOP. ADA COMPLIANT. COORDINATE INSTALLATION OF ADA FIXTURES W/ ARCHITECTURAL DRAWINGS.
<u>SS-1</u>	SERVICE SINK	AMERICAN STANDARD	7695.008	WALL MOUNTED	21½"x23"x33½"	CHICAGO	540LD897SGCCP	MANUAL	3"	2"	1/2"	1/2"	_	WALL MOUNTED, ENAMELED CAST IRON SINK. WALL MOUNTED, CHROME PLATED, 8" O.C. LEVER FAUCET, VACUUM BREAKER. PROVIDE SPLASH GUARDS, MOP & HOSE BRACKETS.
<u>HB-1</u>	HOSE BIBB	JR SMITH	5670-H-CP	WALL MOUNTED	3½"x2¾"	-	-	-	-	-	1/2"	-	-	BRASS BODY, VACUUM BREAKER AND REMOVABLE WHEEL HANDLE.
<u>TMV-1</u>	THERMOSTATIC MIXING VALVE	LEONARD	170A-lf-bp-brkt	_	-	_	-	-	-	-	1/2"	1/2"	1/2"	THERMOSTATIC MIXING VALVE. PROVIDE WITH COLD WATER BYPASS AND MOUNTING BRACKET. SET TEMPERATURE TO 105'F. COORDINATE WITH CONTRACT DRAWINGS FOR SINKS THAT REQUIRE MIXING VALVES.

PLUMBING GENERAL NOTES

- 1. GENERAL NOTES, SYMBOLS LIST AND DETAILS ARE APPLICABLE TO ALL PLUMBING DRAWINGS.
- 2. DRAWINGS ARE DIAGRAMMATIC: DETERMINE LOCATIONS OF
- SYSTEMS AND COMPONENTS IN FIELD. DO NOT SCALE DRAWINGS.
- 3. NEITHER ACCURACY NOR COMPLETION OF UTILITY LOCATIONS SHOWN ON DRAWINGS IS GUARANTEED. DETERMINE EXACT LOCATIONS OF EXISTING UTILITIES IN FIELD, WHETHER OR NOT SHOWN ON DRAWINGS. EXERCISE CAUTION AND IDENTIFY LOCATIONS OF UNMARKED UTILITY LINES AS NECESSARY TO PERFORM WORK OF THIS SECTION.
- 4. ALL PLUMBING WORK SHALL BE IN ACCORDANCE WITH THE PRESIDING PLUMBING CODE AND ALL APPLICABLE LOCAL CODES.
- 5. IT SHALL BE THE RESPONSIBILITY OF THIS CONTRACTOR TO COORDINATE WORK WITH THAT OF ALL OTHER TRADES, INCLUDING (BUT NOT LIMITED TO), ELECTRICAL, HVAC, STRUCTURAL AND GENERAL ARCHITECTURE.
- 6. ANY INTERFERENCE SHALL BE BROUGHT TO THE ATTENTION OF THE GENERAL CONTRACTOR, AND/OR THE OWNER'S REPRESENTATIVE, AND RESOLVED PRIOR TO THE INSTALLATION OF THE WORK INVOLVED.
- 7. ALL PIPING PENETRATING CEILINGS AND WALLS SHALL BE INSTALLED WITH CHROME (STAINLESS WHERE NOTED) PLATED ESCUTCHEONS AT THE PENETRATION. ALL PIPING PENETRATING EXTERIOR WALLS AND ROOFS SHALL BE FLASHED IN AN APPROVED MANNER AND SHALL BE SEALED WEATHERTIGHT. PIPING PENETRATING RATED PARTITIONS SHALL BE PROTECTED WITH UL LISTED SEALS OF EQUAL RATING AND AS REQUIRED BY LOCAL CODE AUTHORITY.
- 8. MANUFACTURERS' MODEL NUMBERS ARE SPECIFIED SOLELY TO ESTABLISH STANDARDS OF QUALITY FOR PERFORMANCE AND MATERIALS.
- 9. ALL PRODUCT INSTALLATION SHALL ADHERE TO THE MANUFACTURERS' RECOMMENDATIONS.
- 10. PROVIDE ACCESS PANELS FOR ALL EQUIPMENT THAT REQUIRES PERIODIC SERVICE AND FOR ALL VALVES.
- 11. CONTRACTOR SHALL COORDINATE ELECTRICAL CHARACTERISTICS AND REQUIREMENTS OF ALL PLUMBING EQUIPMENT WITH THE ELECTRICAL DRAWINGS, AND SHALL FURNISH EQUIPMENT WIRED FOR THE VOLTAGES SHOWN HEREIN.
- 12. ALL PLUMBING EQUIPMENT, PIPING, INSULATION, ETC., INSTALLED IN HVAC PLENUM SPACES SHALL MEET CODE REQUIREMENTS FOR SMOKE AND COMBUSTIBILITY.
- 13. PROVIDE SHUTOFF VALVES ON ALL BRANCH PIPING AND SUPPLIES TO INDIVIDUAL FIXTURES AND EQUIPMENT. PROVIDE BALL VALVES ON ALL WATER MAIN BRANCHES IN CORRIDORS AND WHERE INDICATED ON DRAWINGS. ALL VALVES SHALL BE ACCESSIBLE.

- 14. ALL SLEEVES THROUGH CONCRETE FLOORS AND ALL CORE DRILLING OF CONCRETE FLOORS AND WALLS SHALL BE BY THIS CONTRACTOR. CONCRETE PADS AND PLATFORMS FOR WORK OF THIS SECTION WILL BE PROVIDED BY GENERAL CONTRACTOR. PROVIDE INFORMATION AS NECESSARY TO COORDINATE WORK.
- 15. RUN PIPING CONCEALED WHERE POSSIBLE, UNLESS SPECIFIED OTHERWISE.
- 16. STRUCTURAL WELDING SHALL BE 1/4-INCH
- FILLET UNLESS REQUIRED OTHERWISE. 17. PROVIDE CLAMPS, OFFSETS, EXPANSION JOINTS, ANCHORS AND
- GUIDES AS NECESSARY TO PREVENT STRESS ON PIPING.
- 18. PROVIDE VENTS AT HIGH POINTS IN PIPING SYSTEMS AND DRAIN VALVES AT LOW POINTS.
- 19. VERIFY EXACT SIZES, LOCATIONS, INVERTS AND ELEVATIONS PRIOR TO RUNNING ANY PIPING. REFER TO ARCHITECTURAL DRAWINGS AND FOOD SERVICE DRAWINGS FOR EXACT LOCATIONS OF ALL FIXTURES AND EQUIPMENT.
- 20. PIPE SUPPORTS FOR PLUMBING IN BUILDING SHAFTS ARE BY THIS CONTRACTOR. CAREFULLY COORDINATE WITH PLACEMENT OF STEEL GRATE SUPPORT BEAMS. SHAFT PIPE SUPPORT SHALL BEAR FROM WALL AND FROM FLOOR SUPPORT BEAMS.
- 21. GENERAL FLOOR CONTROL VALVES OF PIPED SERVICES SHALL
- BE IN THE PIPE SHAFTS UNLESS OTHERWISE INDICATED. 22. NO PIPING SHALL RUN OVER ELECTRICAL PANELS.
- 23. ALL PIPING THAT PENETRATES FLOORS OR FIRE RATED WALLS SHALL BE FIRE STOPPED W/ HILTI CAULKING

PER MANUFACTURERS RECOMMENDATIONS.

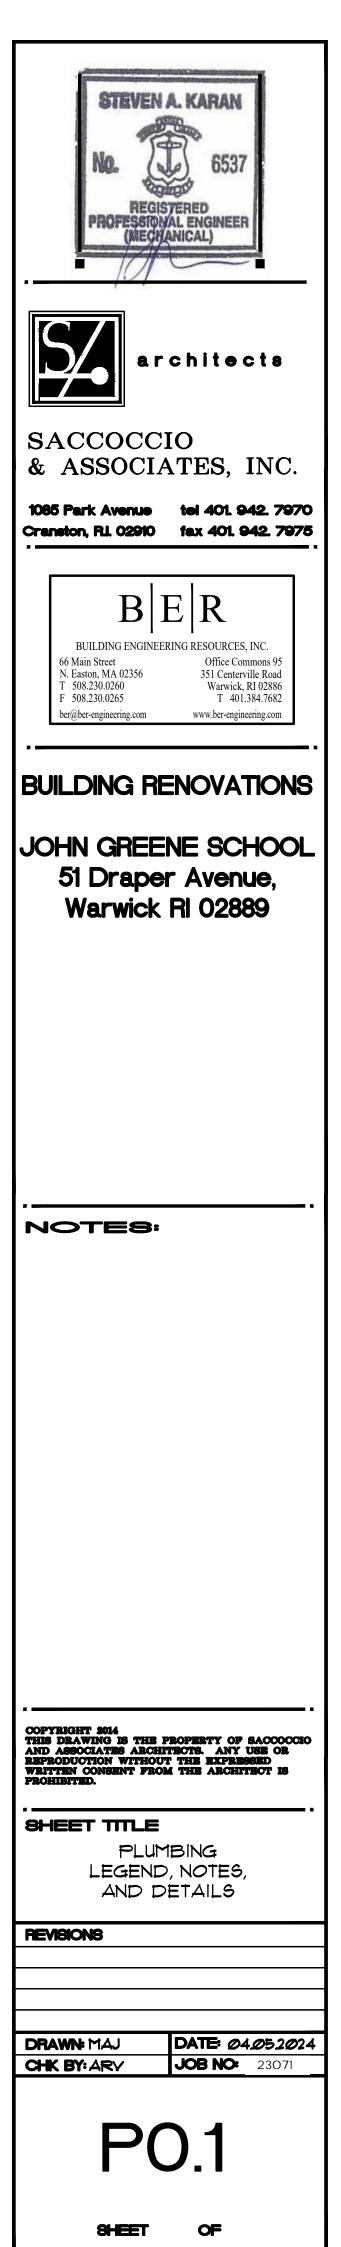
- 24. ELECTRICAL SUB CONTRACTOR IS RESPONSIBLE FOR PROVIDING POWER TO ALL EQUIPMENT AND CONTROLS WITHIN THE PLUMBING SYSTEMS FOR THIS PROJECT.
- 25. PC TO ORGANIZE/LOCATE CUT OUTS FOR PIPING/CONDUITS RUNNING PERPENDICULAR TO THE FLOOR JOISTS W/ GC. COORDINATE AND VERIFY IN FIELD.
- 26. COORDINATE ALL CEILING AND WALL MOUNTED FIXTURES AND EQUIPMENT WITH ARCHITECTURAL DRAWING. LOCATE FIXTURES AND EQUIPMENT AS INDICATED ON ARCHITECTURAL DRAWINGS WHERE ACCEPTABLE BY CODE.
- 27. ALL SLEEVES THROUGH CONCRETE FLOORS AND FIRE RATED WALLS OR PARTITIONS SHALL BE FIRE STOPPED WITH UL RATED ASSEMBLIES OF EQUAL FIRE RATING.

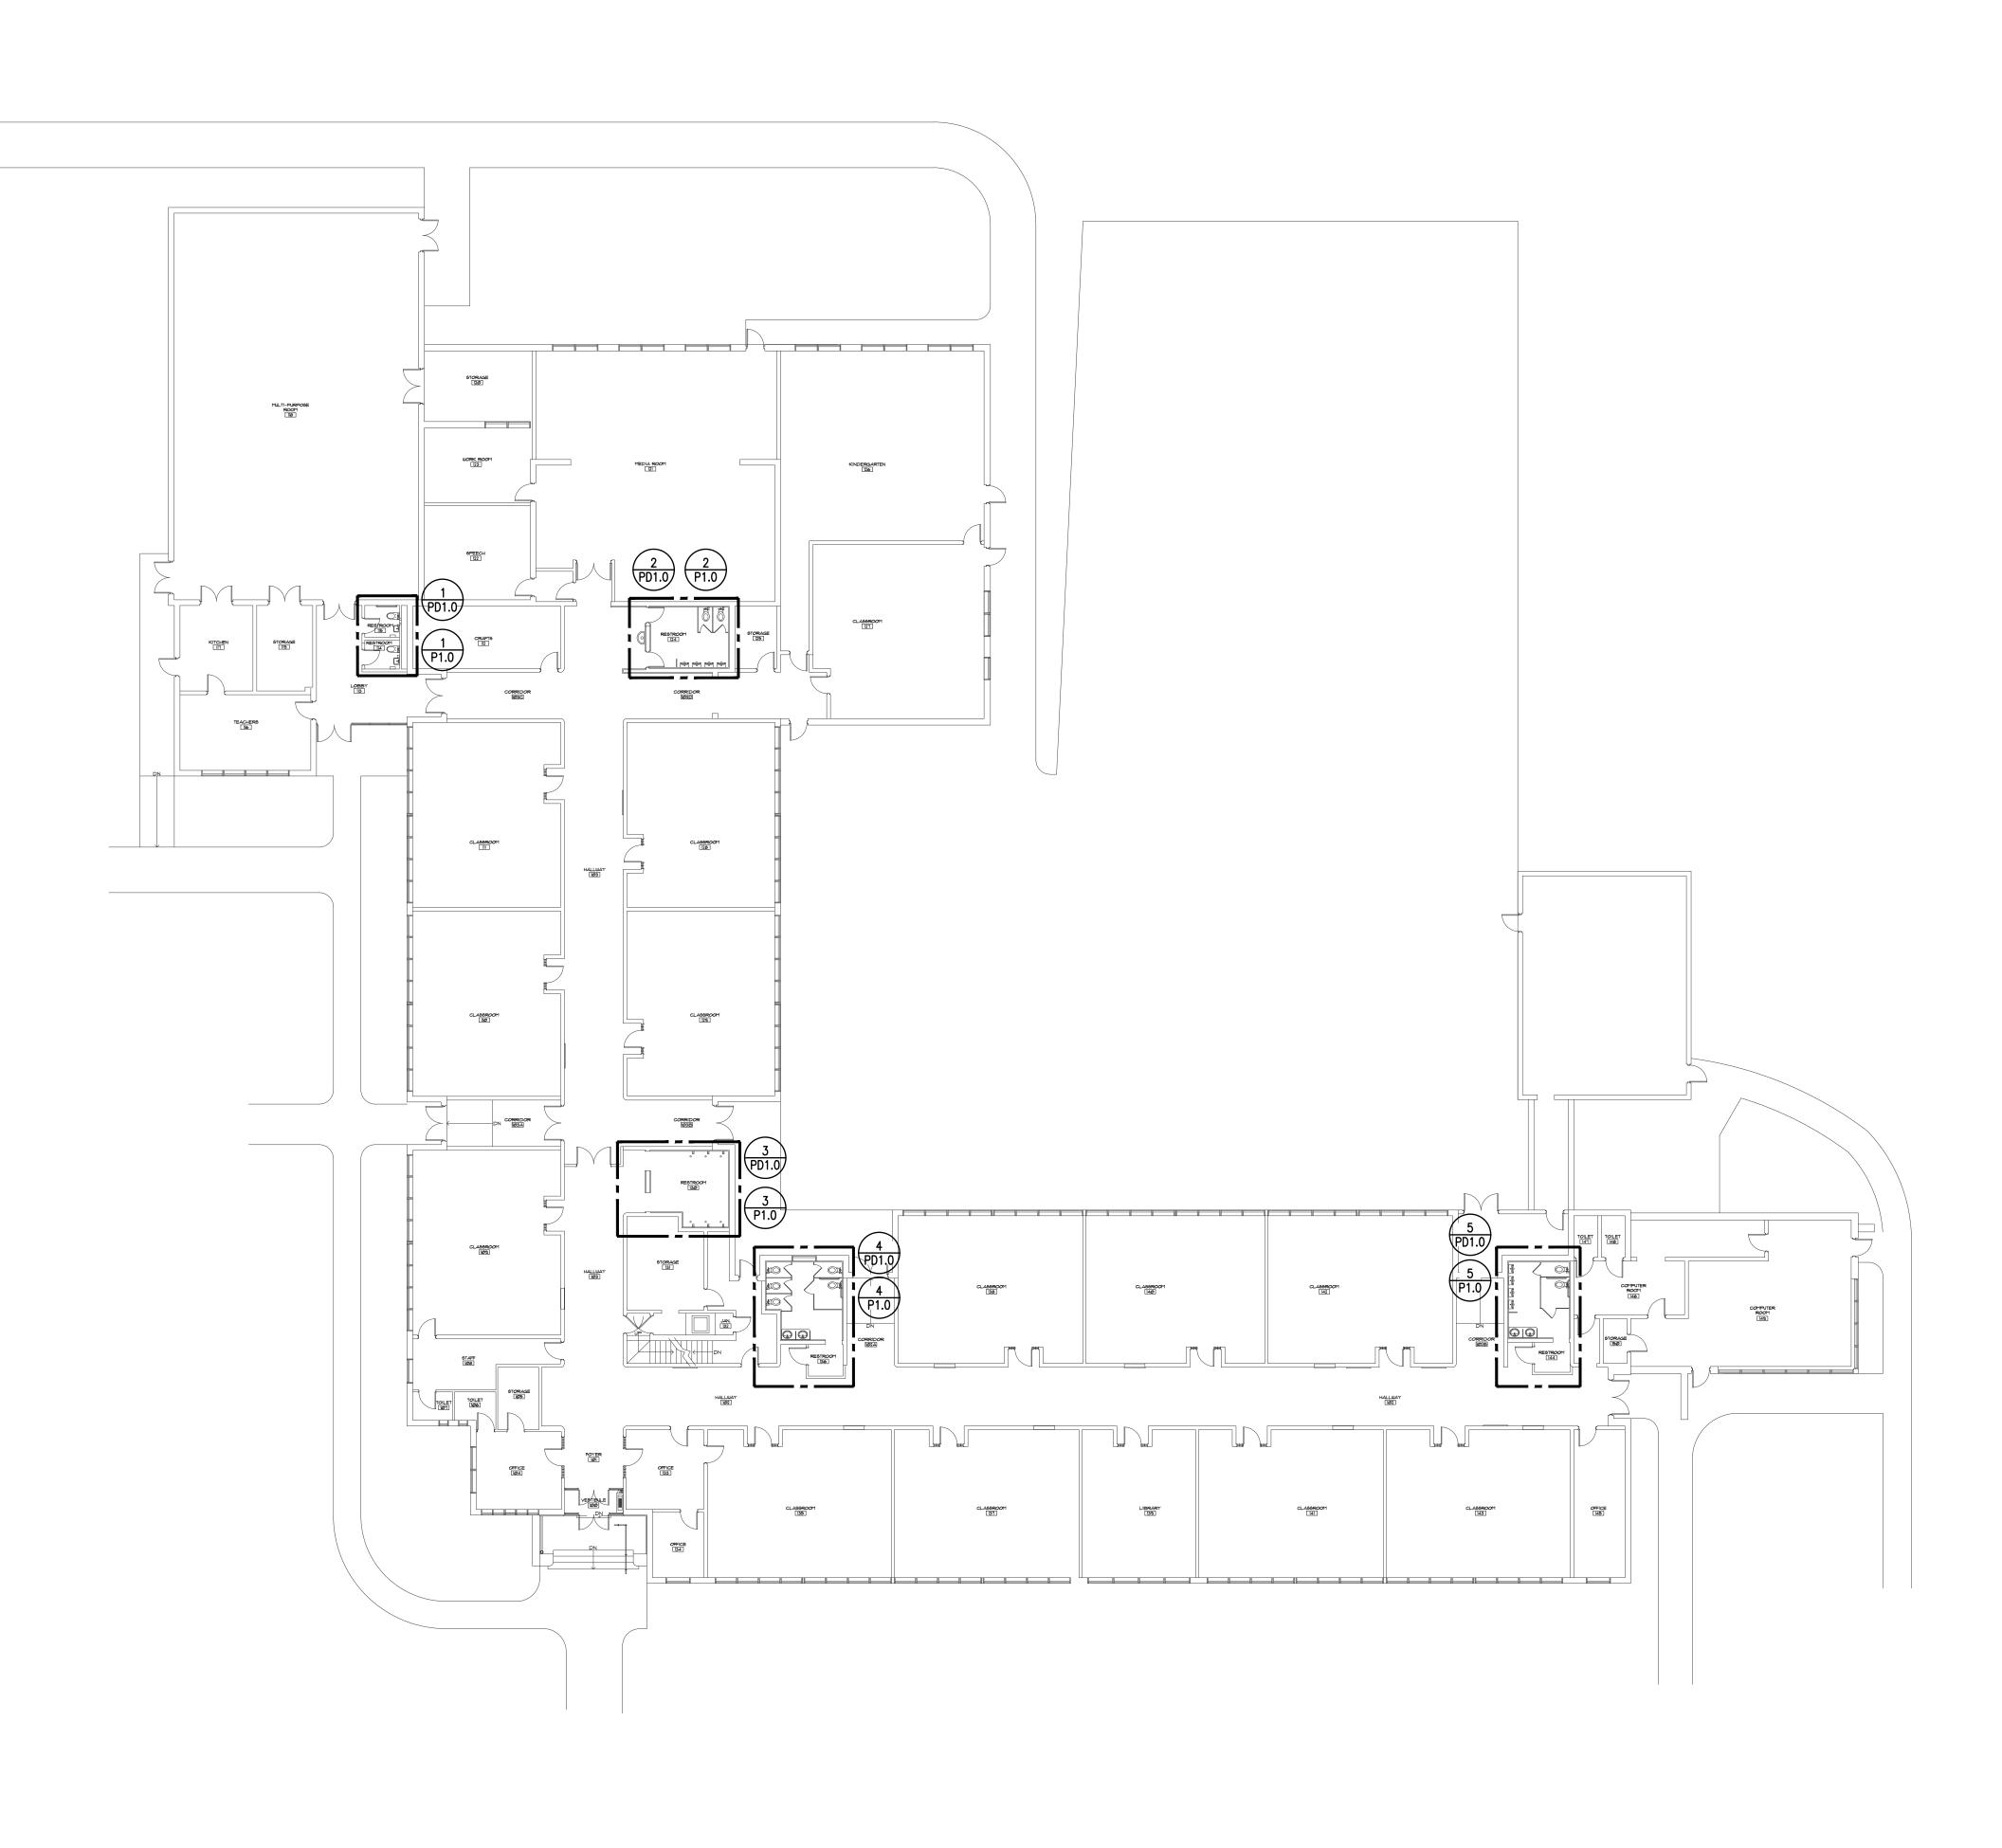
DRAIN & CLEANOUT SCHEDULE

SYMBOL	TYPE	MANUFACTURER	MODEL	OUTLET	STRAINER/COVER	REMARKS
<u>FD-1</u>	FLOOR DRAIN	WATTS	FD100-A	2"	6"ø NICKEL BRONZE	CAST IRON BODY, NO-HUB, ADJUSTABLE STRAINER, VANDAL RESISTANT.
<u>FC0</u>	FLOOR CLEANOUT	WATTS	CO20-4NH	4"	5%" $_{\varphi}$ stainless steel	4" FLOOR CLEANOUT, CAST IRON BODY, NO-HUB, STAINLESS STEEL TOP. SAWCUT AND PATCH EXISTING FLOOR AS NECESSARY FOR PROPER INSTALLATION.
<u>WCO</u>	WALL CLEANOUT	REAL-TITE	RTPFC20	VARIES	2.5" _{\$\$\phi\$\$} -5.375" _{\$\$} CHROME	COUNTERSUNK FLUSH CHROME EXPANSION PLUG W/ 4" CHROME COVER. COORDINATE WITH PLUMBING DRAWINGS AND EXISTING CONDITIONS FOR SIZE.
NOTES					-	

<u>NOTES:</u> 1. ALL FLOOR DRAINS SHALL HAVE TRAP SEAL GASKETS EQUAL TO "SURE SEAL". 2. INSTALLATIONS SHALL BE IN COMPLETE ACCORDANCE WITH STATE & LOCAL CODES.

PLUMBING L	EGENL)
	ETR	LIGHT LINE INDICATES EXISTING PIPING TO REMAIN.
	RE	REMOVE EXISTING PIPING/DUCT/EQUIPMENT
Θ	CTE	CONNECT TO EXISTING
XX	C&C	CUT & CAP
	CW	COLD WATER
CW	CW	COLD WATER BELOW FLOOR OR BURIED
	HW	HOT WATER
———— HW ————	HW	HOT WATER BELOW FLOOR OR BURIED
	HWR	HOT WATER RECIRCULATION
	S/W	SOIL OR WASTE
S/W	s/w	SOIL OR WASTE BELOW FLOOR OR BURIED
	V	VENT
— — _ v— — —	V	VENT BELOW FLOOR OR BURIED
	ST	STORM/RAINWATER
ST	ST	STORM/RAINWATER BELOW FLOOR OR BURIED
~~~~~~~~~~~~~~~~~~~~~~~~~~~~~~~~~~~~~~~		CONTINUATION
	UP/RISER	PIPE RISER
	DR/DN	PIPE DROP OR DOWN
<del></del>	TEE	PIPE TEE
þ		BALL VALVE
略	VIV	VALVE IN VERTICAL
及	BV	BALANCING VALVE
16f8~1424	BVA	BALANCING VALVE ASSEMBLY
	W&T	WASTE & TRAP
	co/wco	CLEANOUT PLUG OR WALL CLEANOUT
	FCO	FLOOR CLEANOUT
7		CAPPED PIPE
		ARROW INDICATES DIRECTION OF FLOW
.01		ARROW INDICATES DIRECTION OF SLOPE
	HB	HOSE BIBB
I.	no	
$\Box$	FD	FLOOR DRAIN
Ø	RD	ROOF DRAIN
	EX	EXISTING
	VTR	VENT THRU ROOF
	VIF	VERIFY LOCATION, SIZE & CONNECTION IN FIELD
	I.E.	INVERT ELEVATION
	TYP	TYPICAL
	NTS	NOT TO SCALE
	AFF	ABOVE FINISHED FLOOR
	FFE	FINISHED FLOOR ELEVATION
	GC	GENERAL CONTRACTOR
	FPC	FIRE PROTECTION CONTRACTOR
	PC	PLUMBING CONTRACTOR
	EC	ELECTRICAL CONTRACTOR
	HVAC	HVAC CONTRACTOR
	S=.01	SLOPE = 1/8" PER FOOT
	S=.02	SLOPE = 1/4" PER FOOT

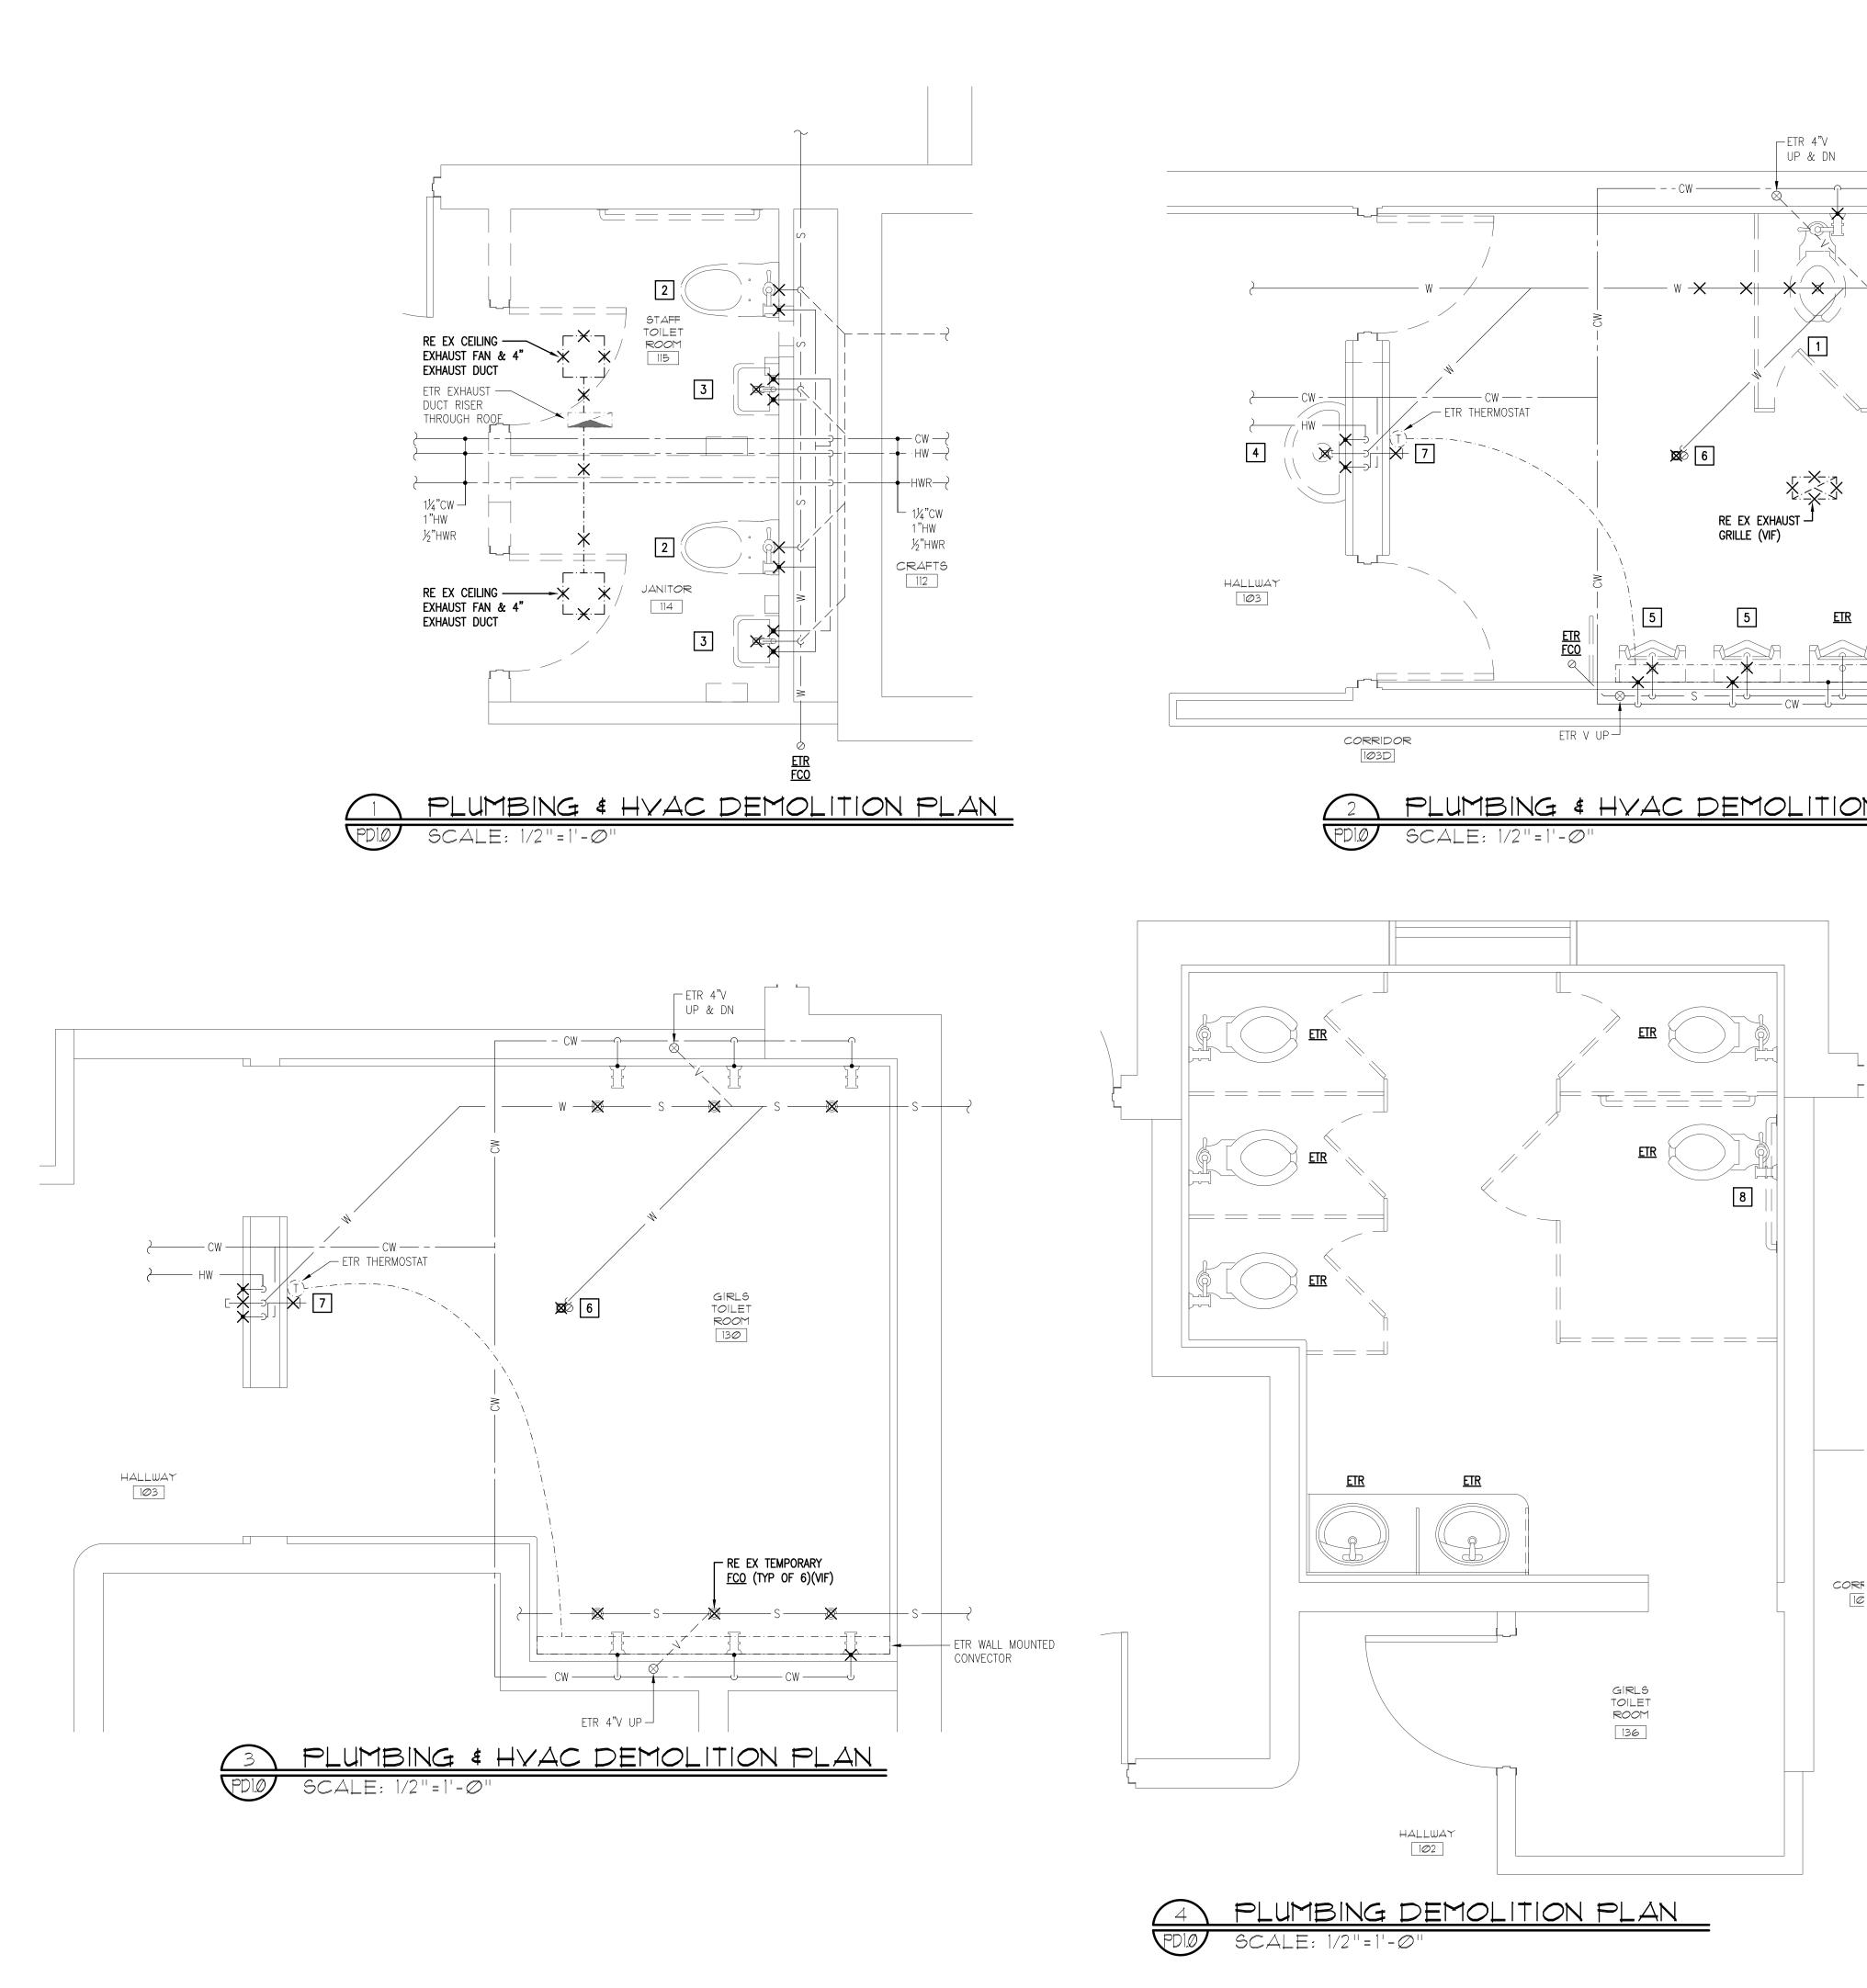


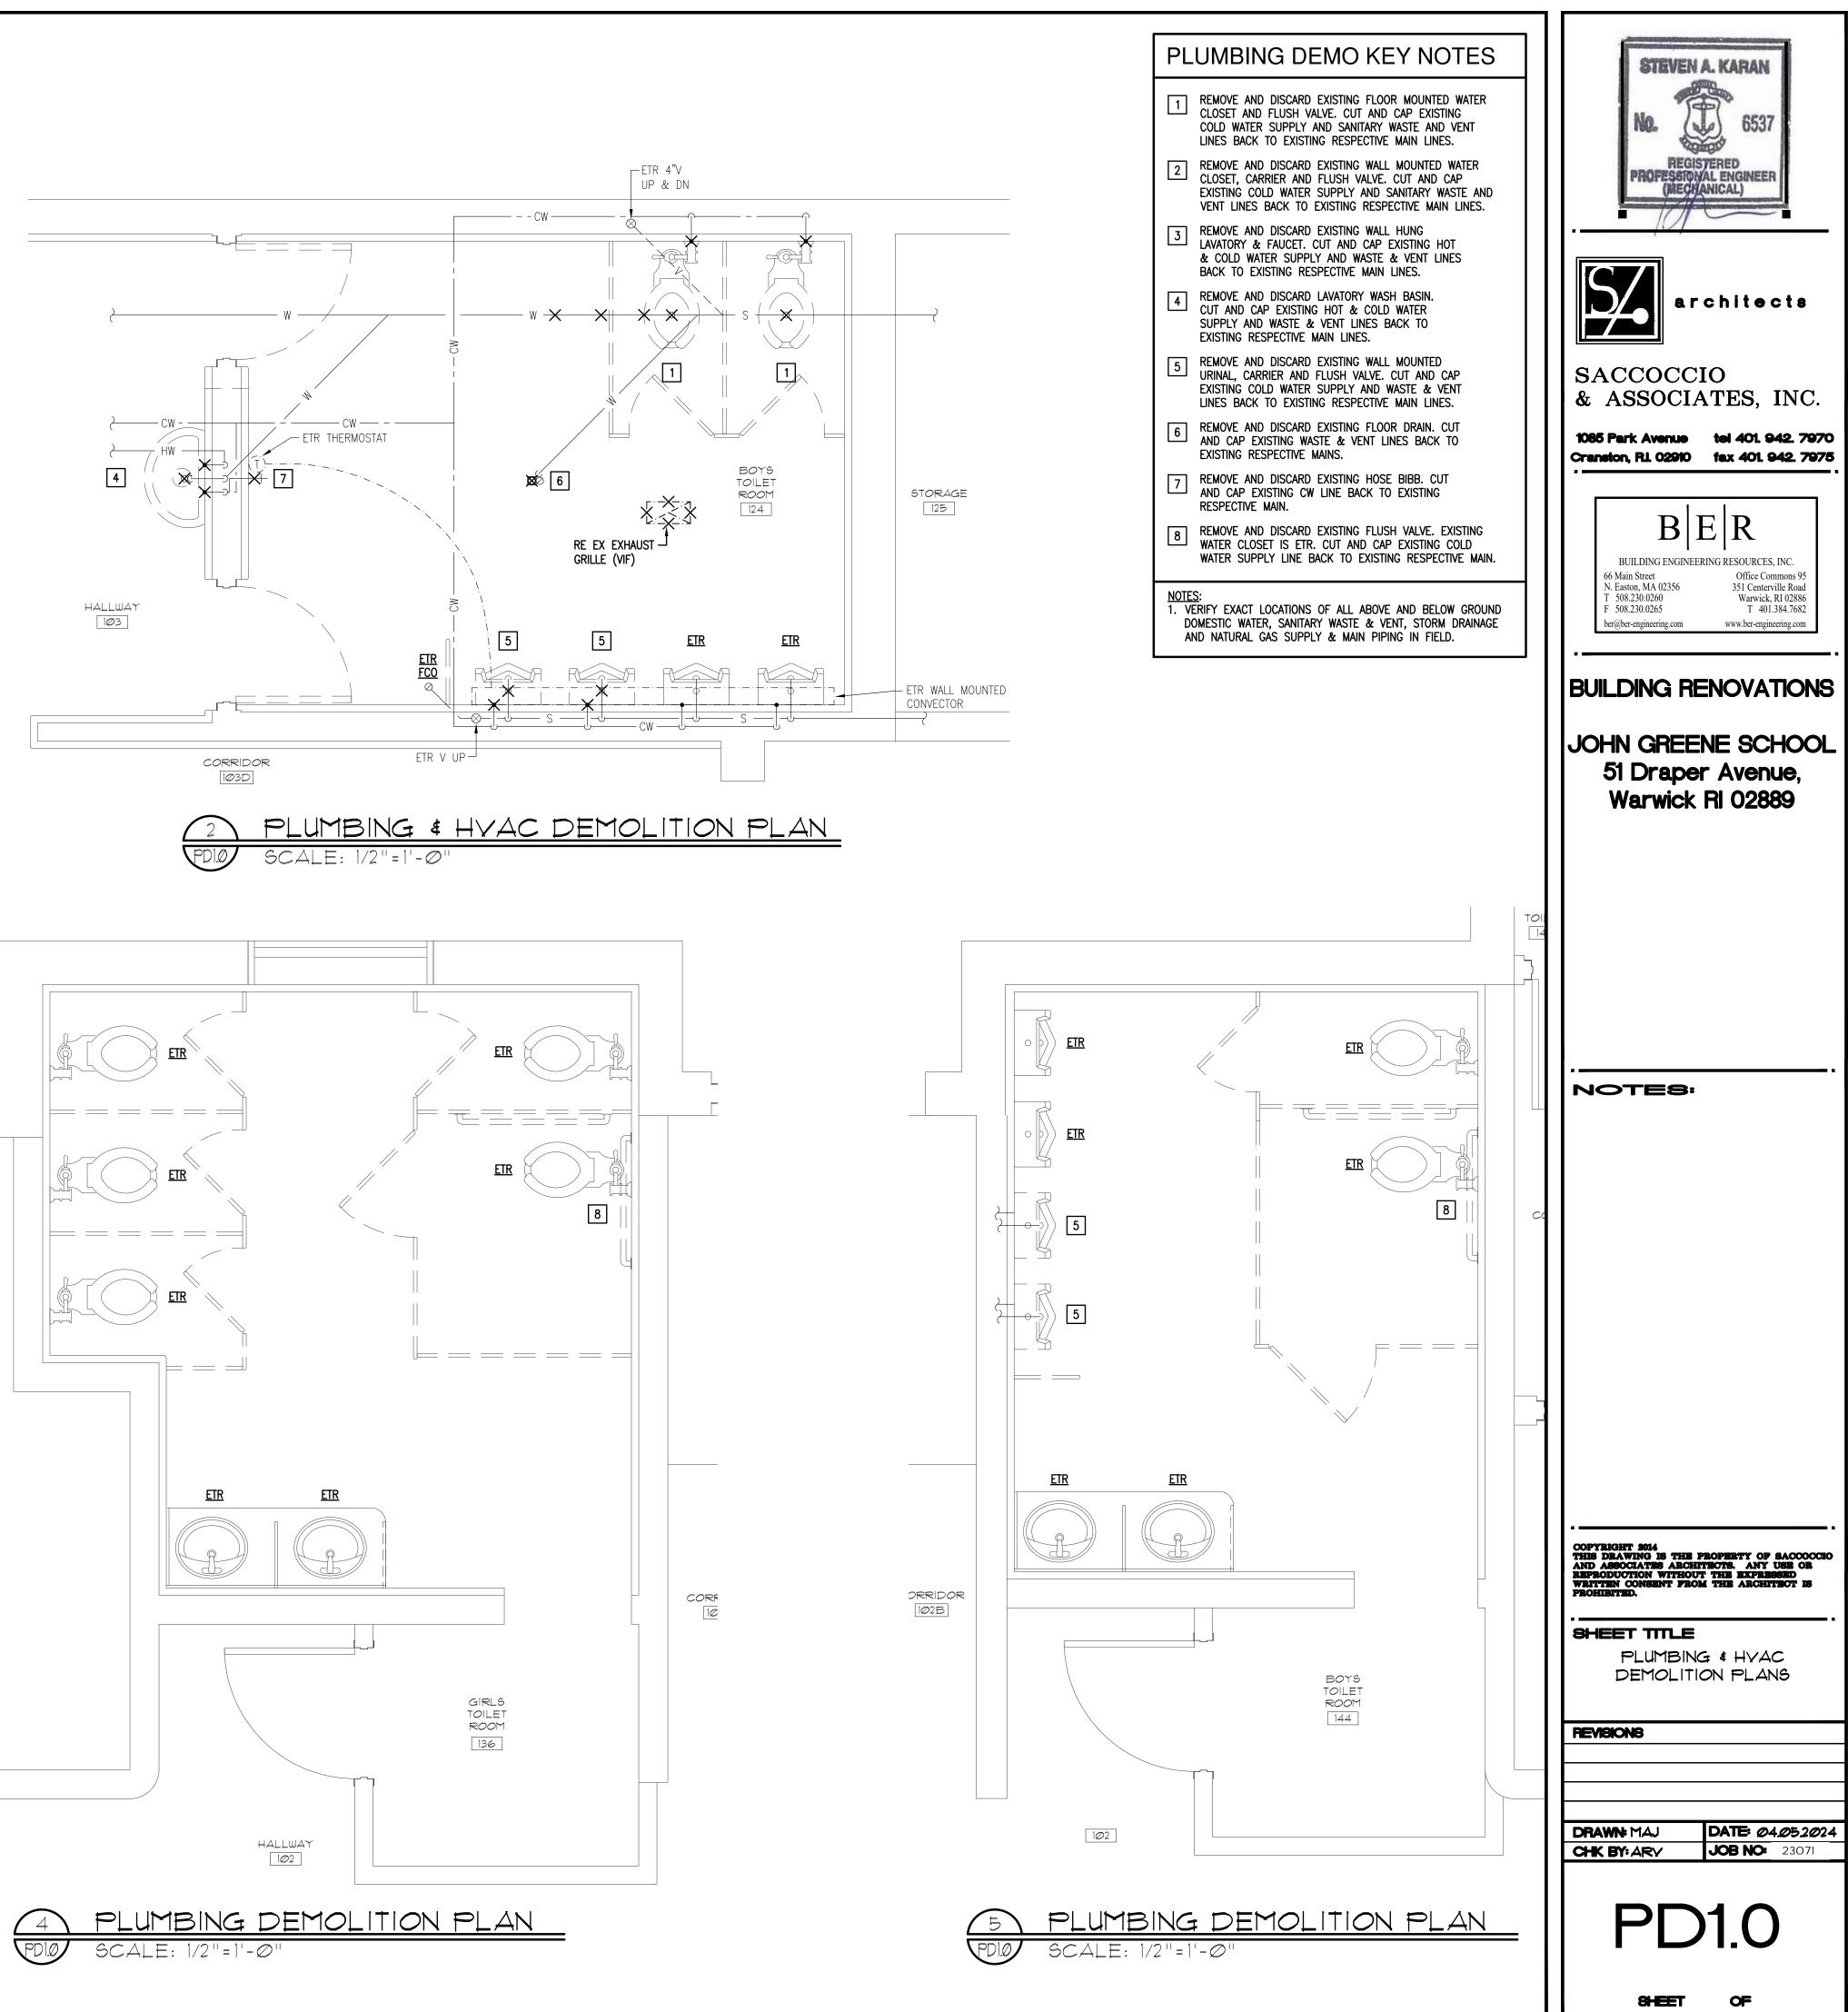


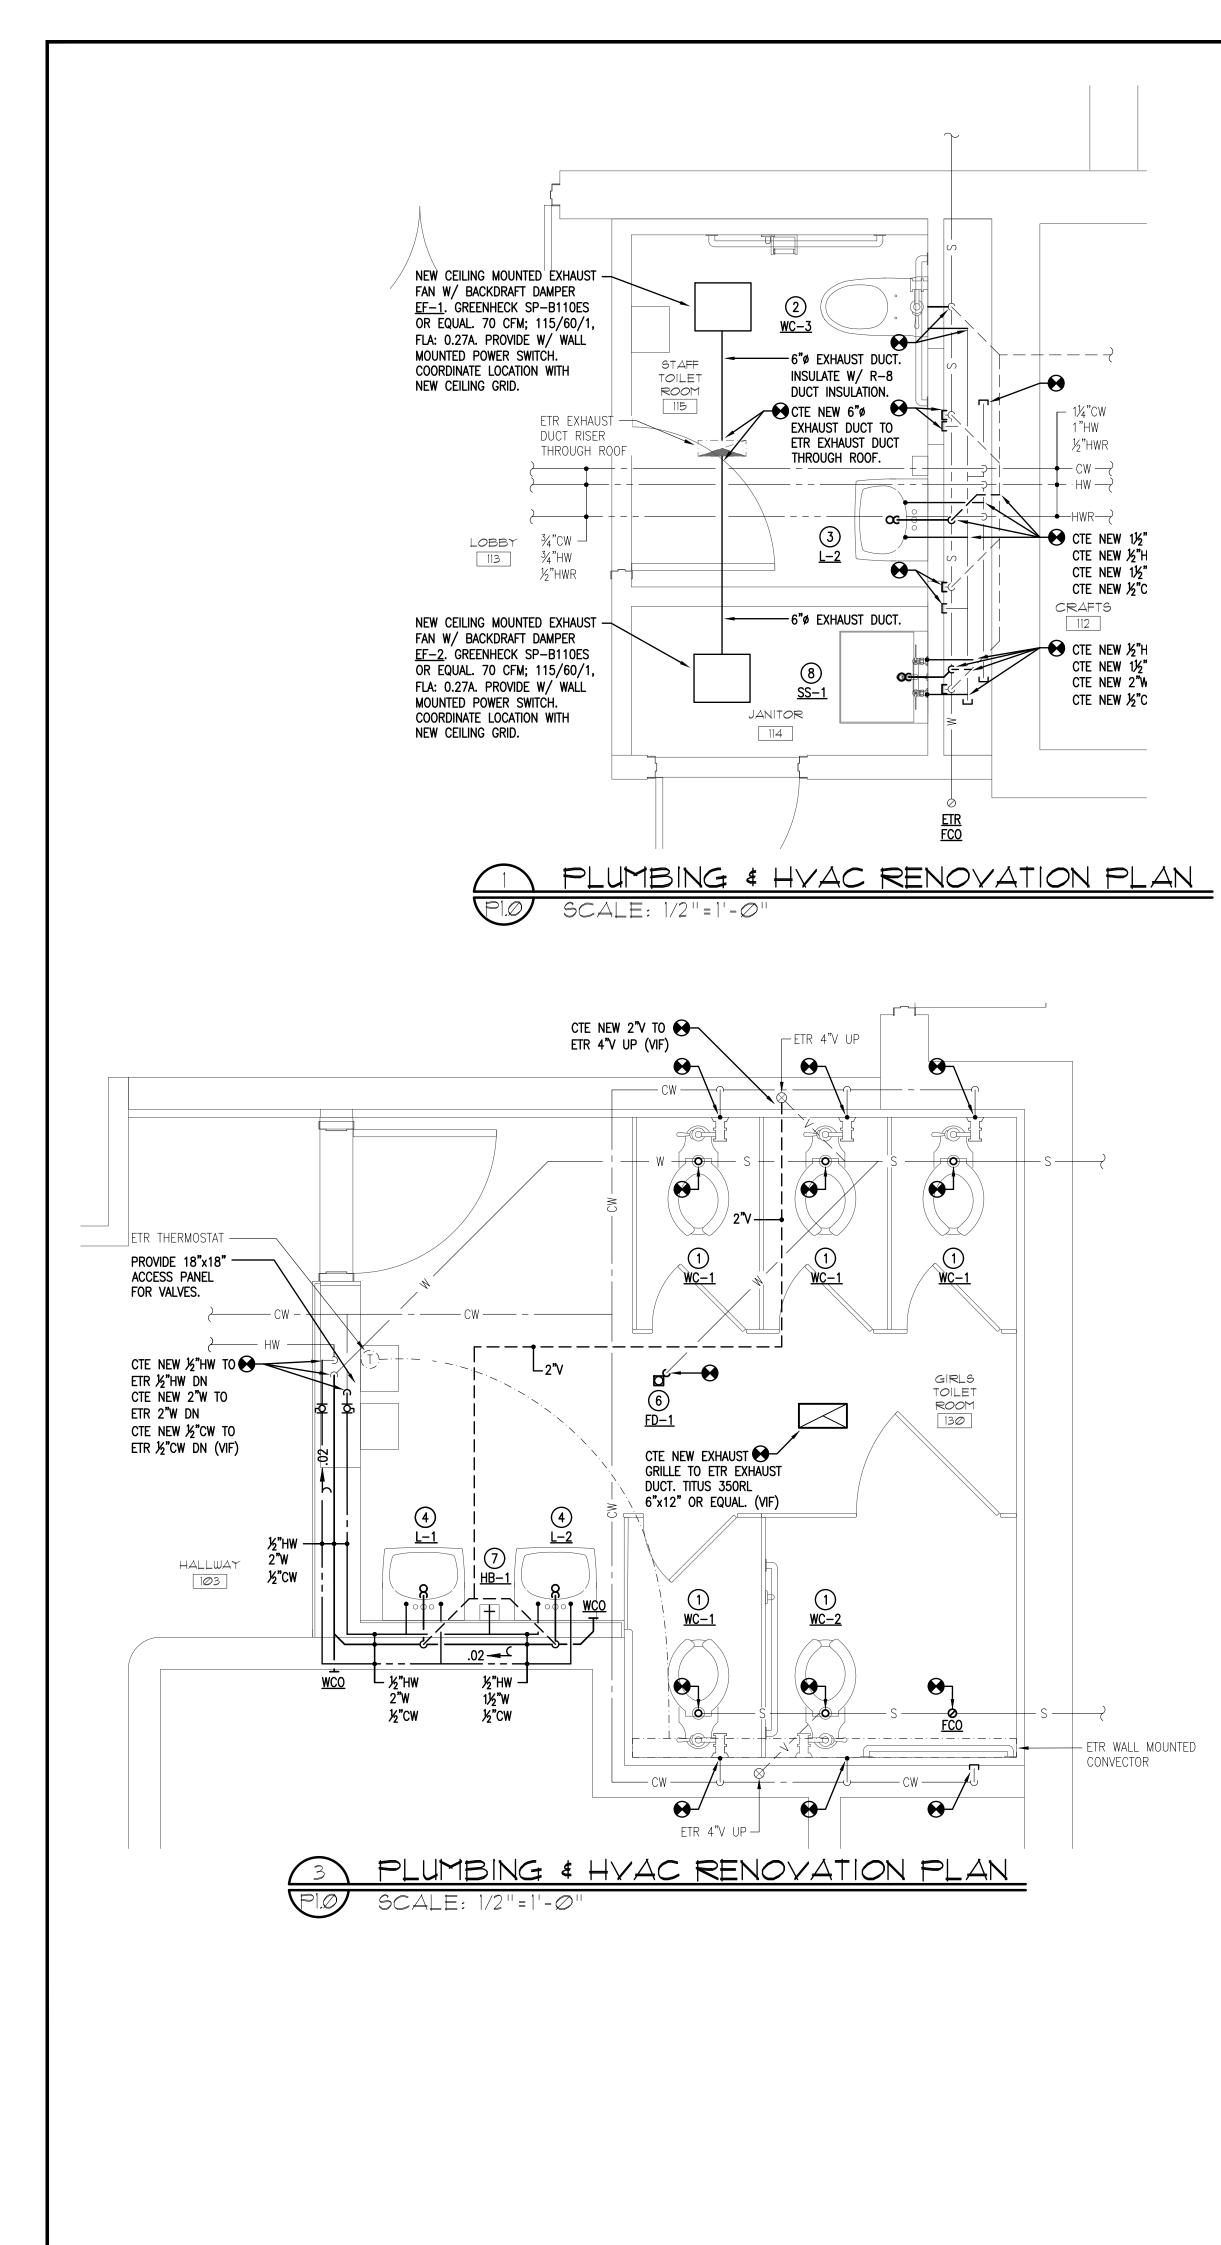
PLUMBING OVERALL PLAN SCALE: 1/16"=1'-0" PØ.2

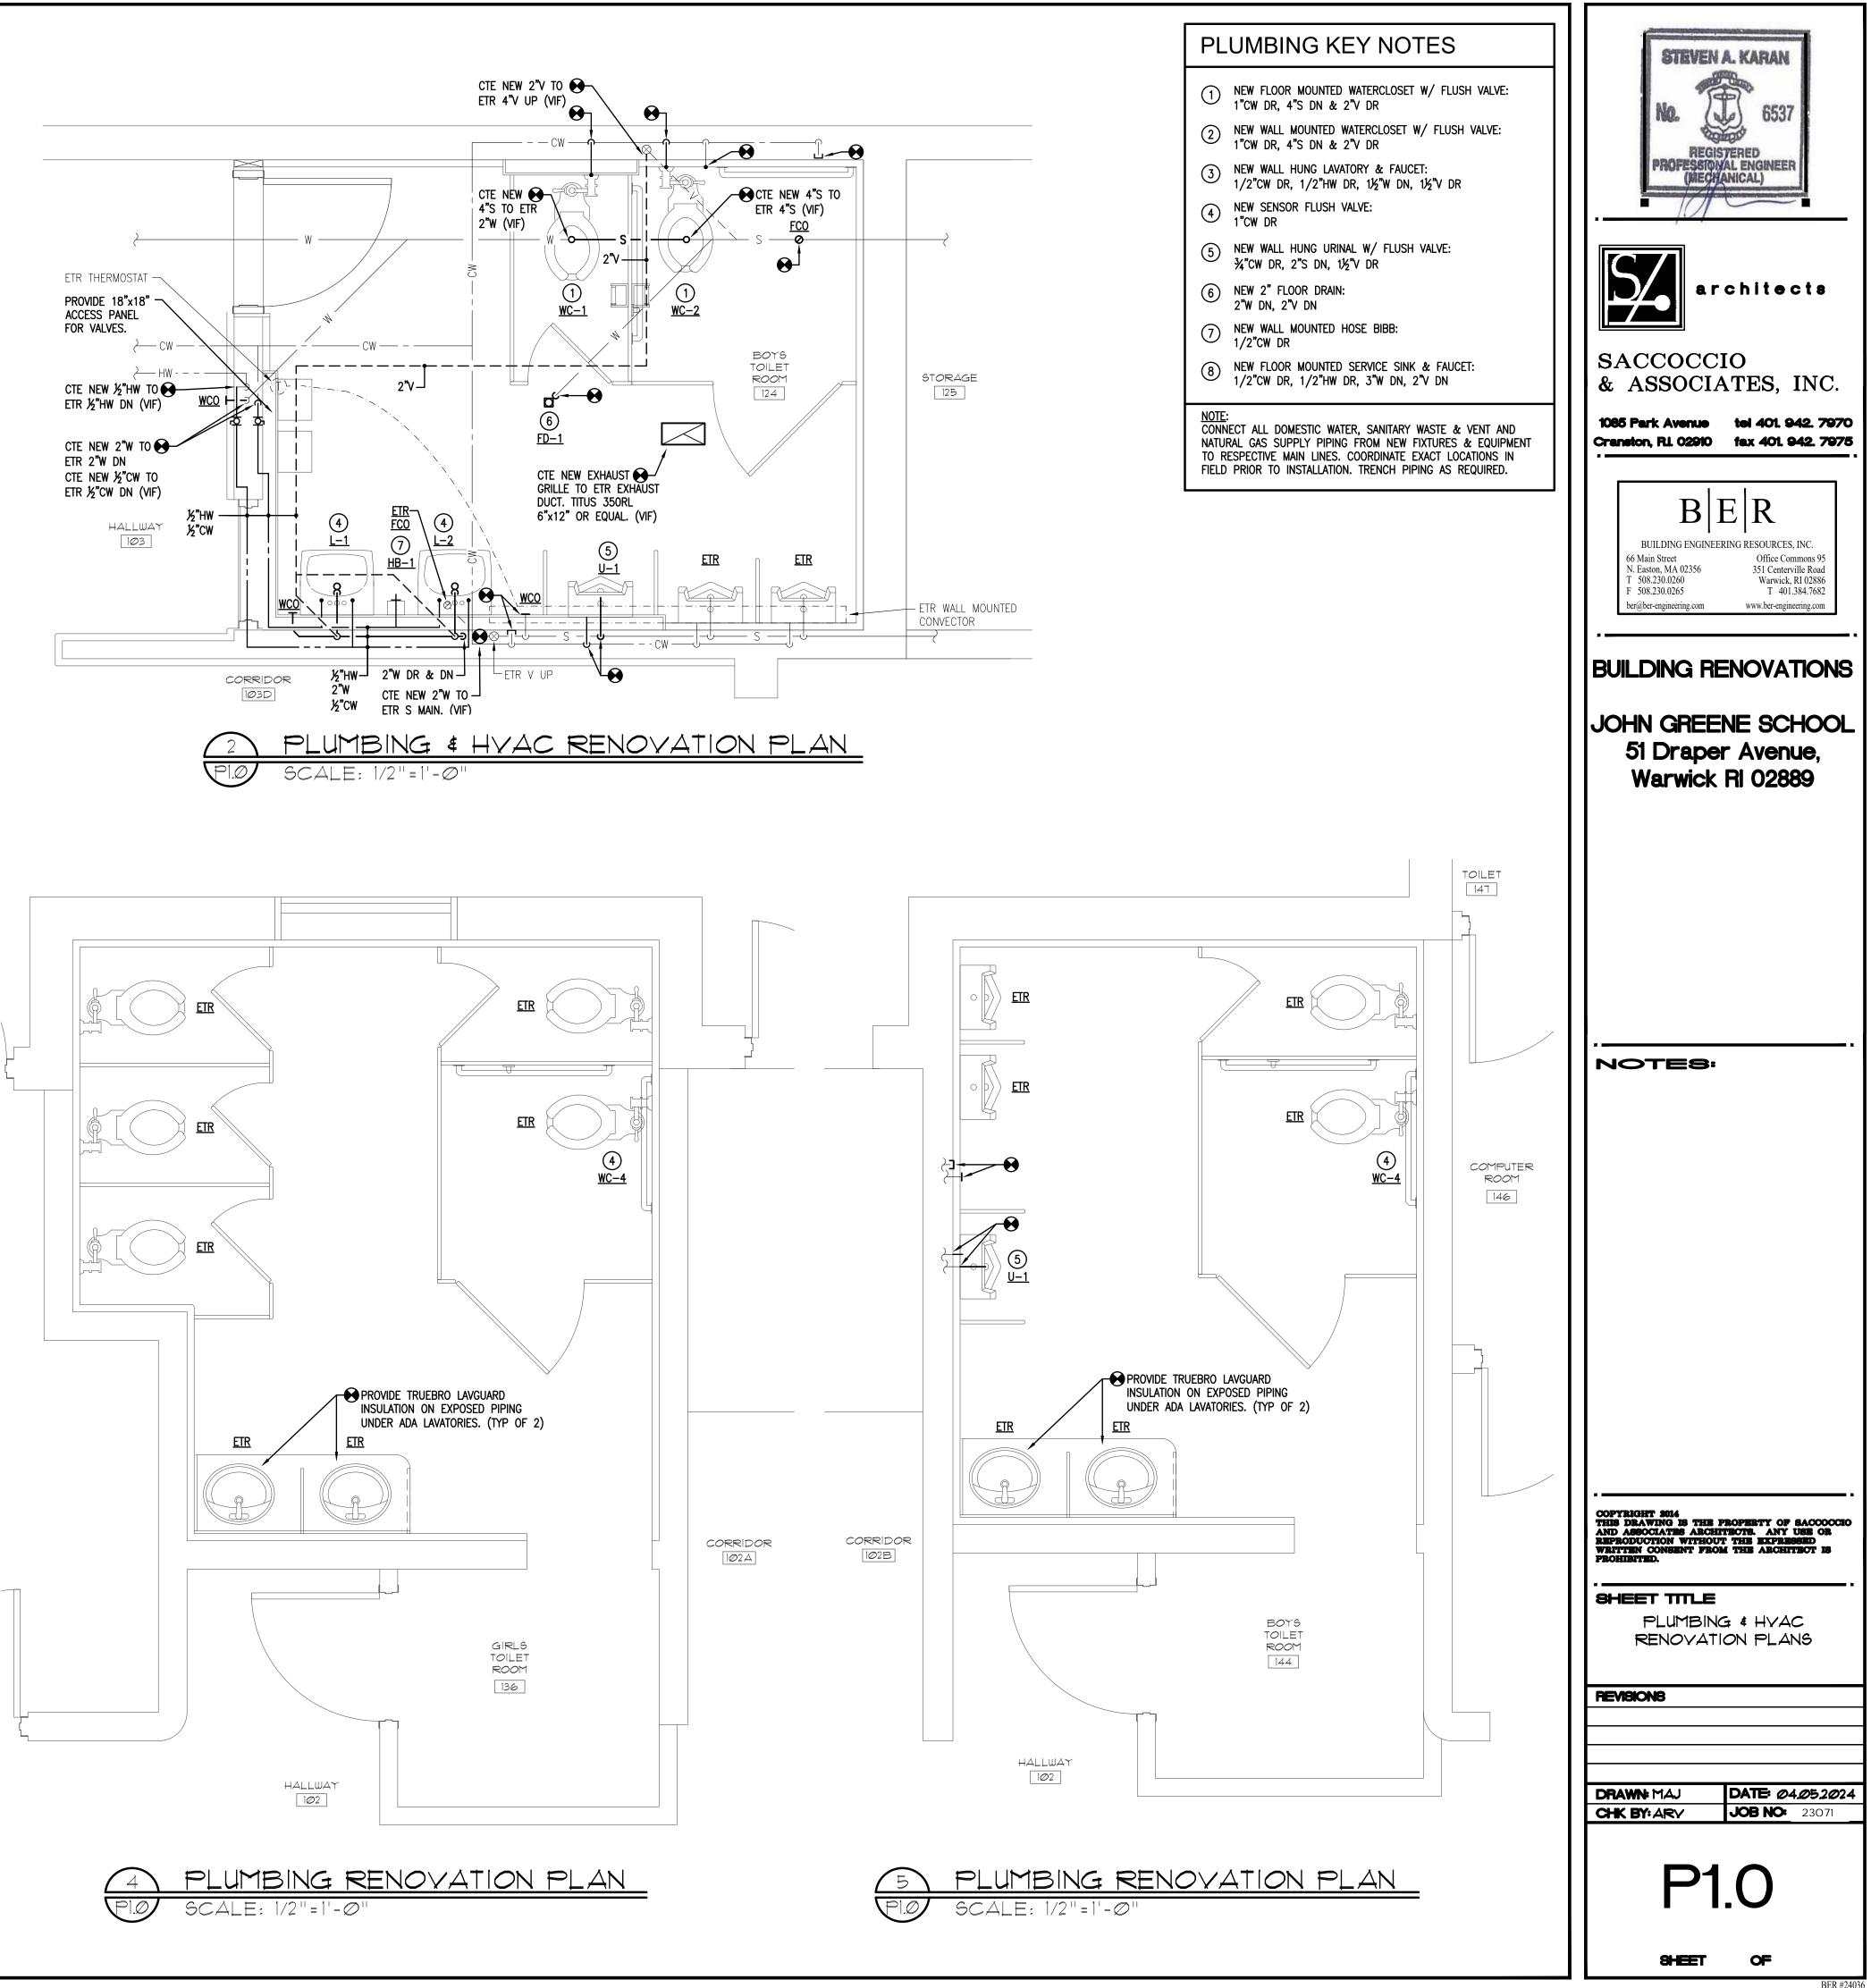
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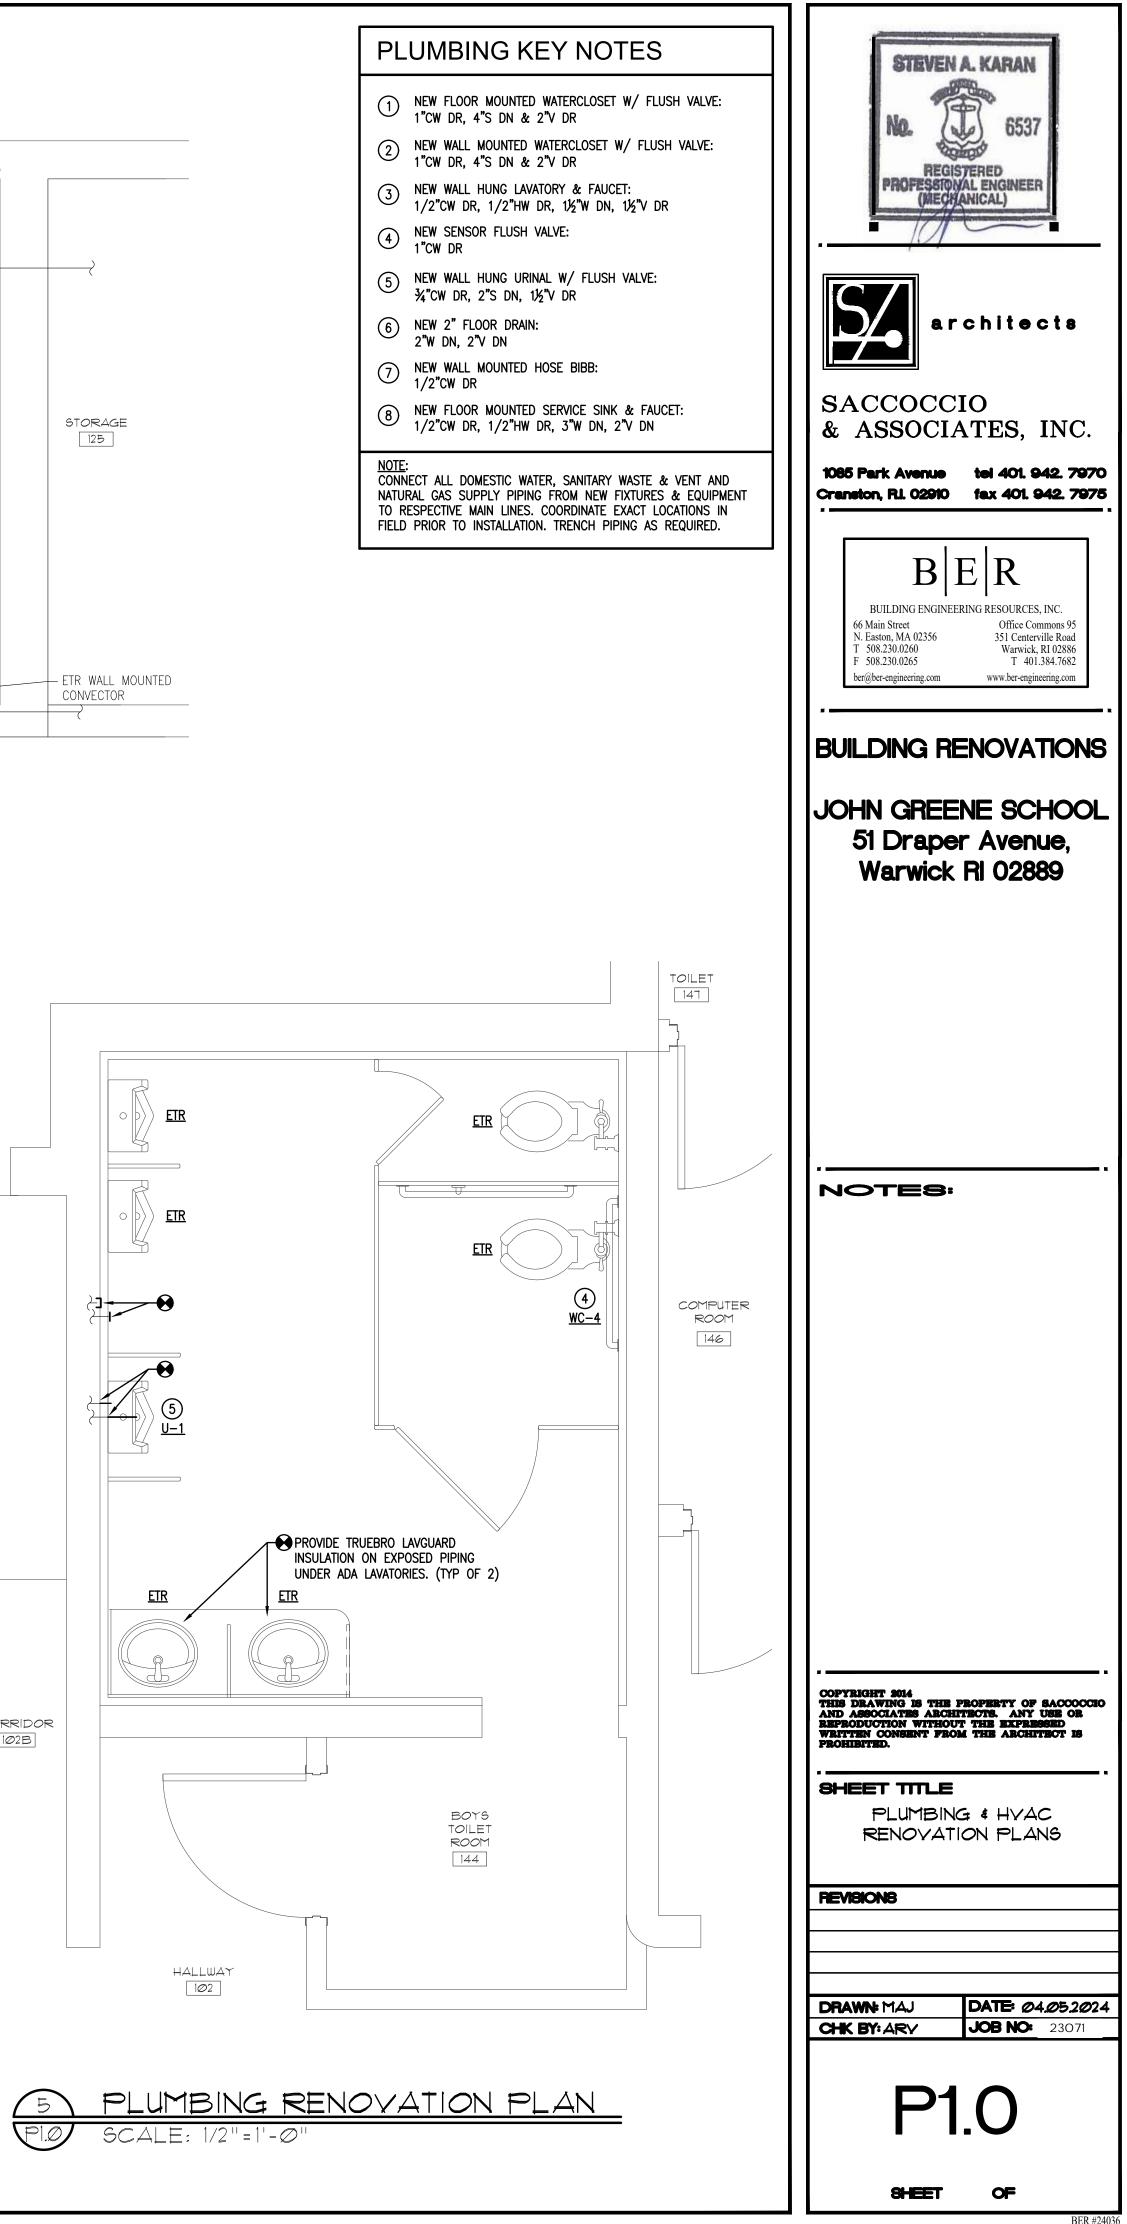


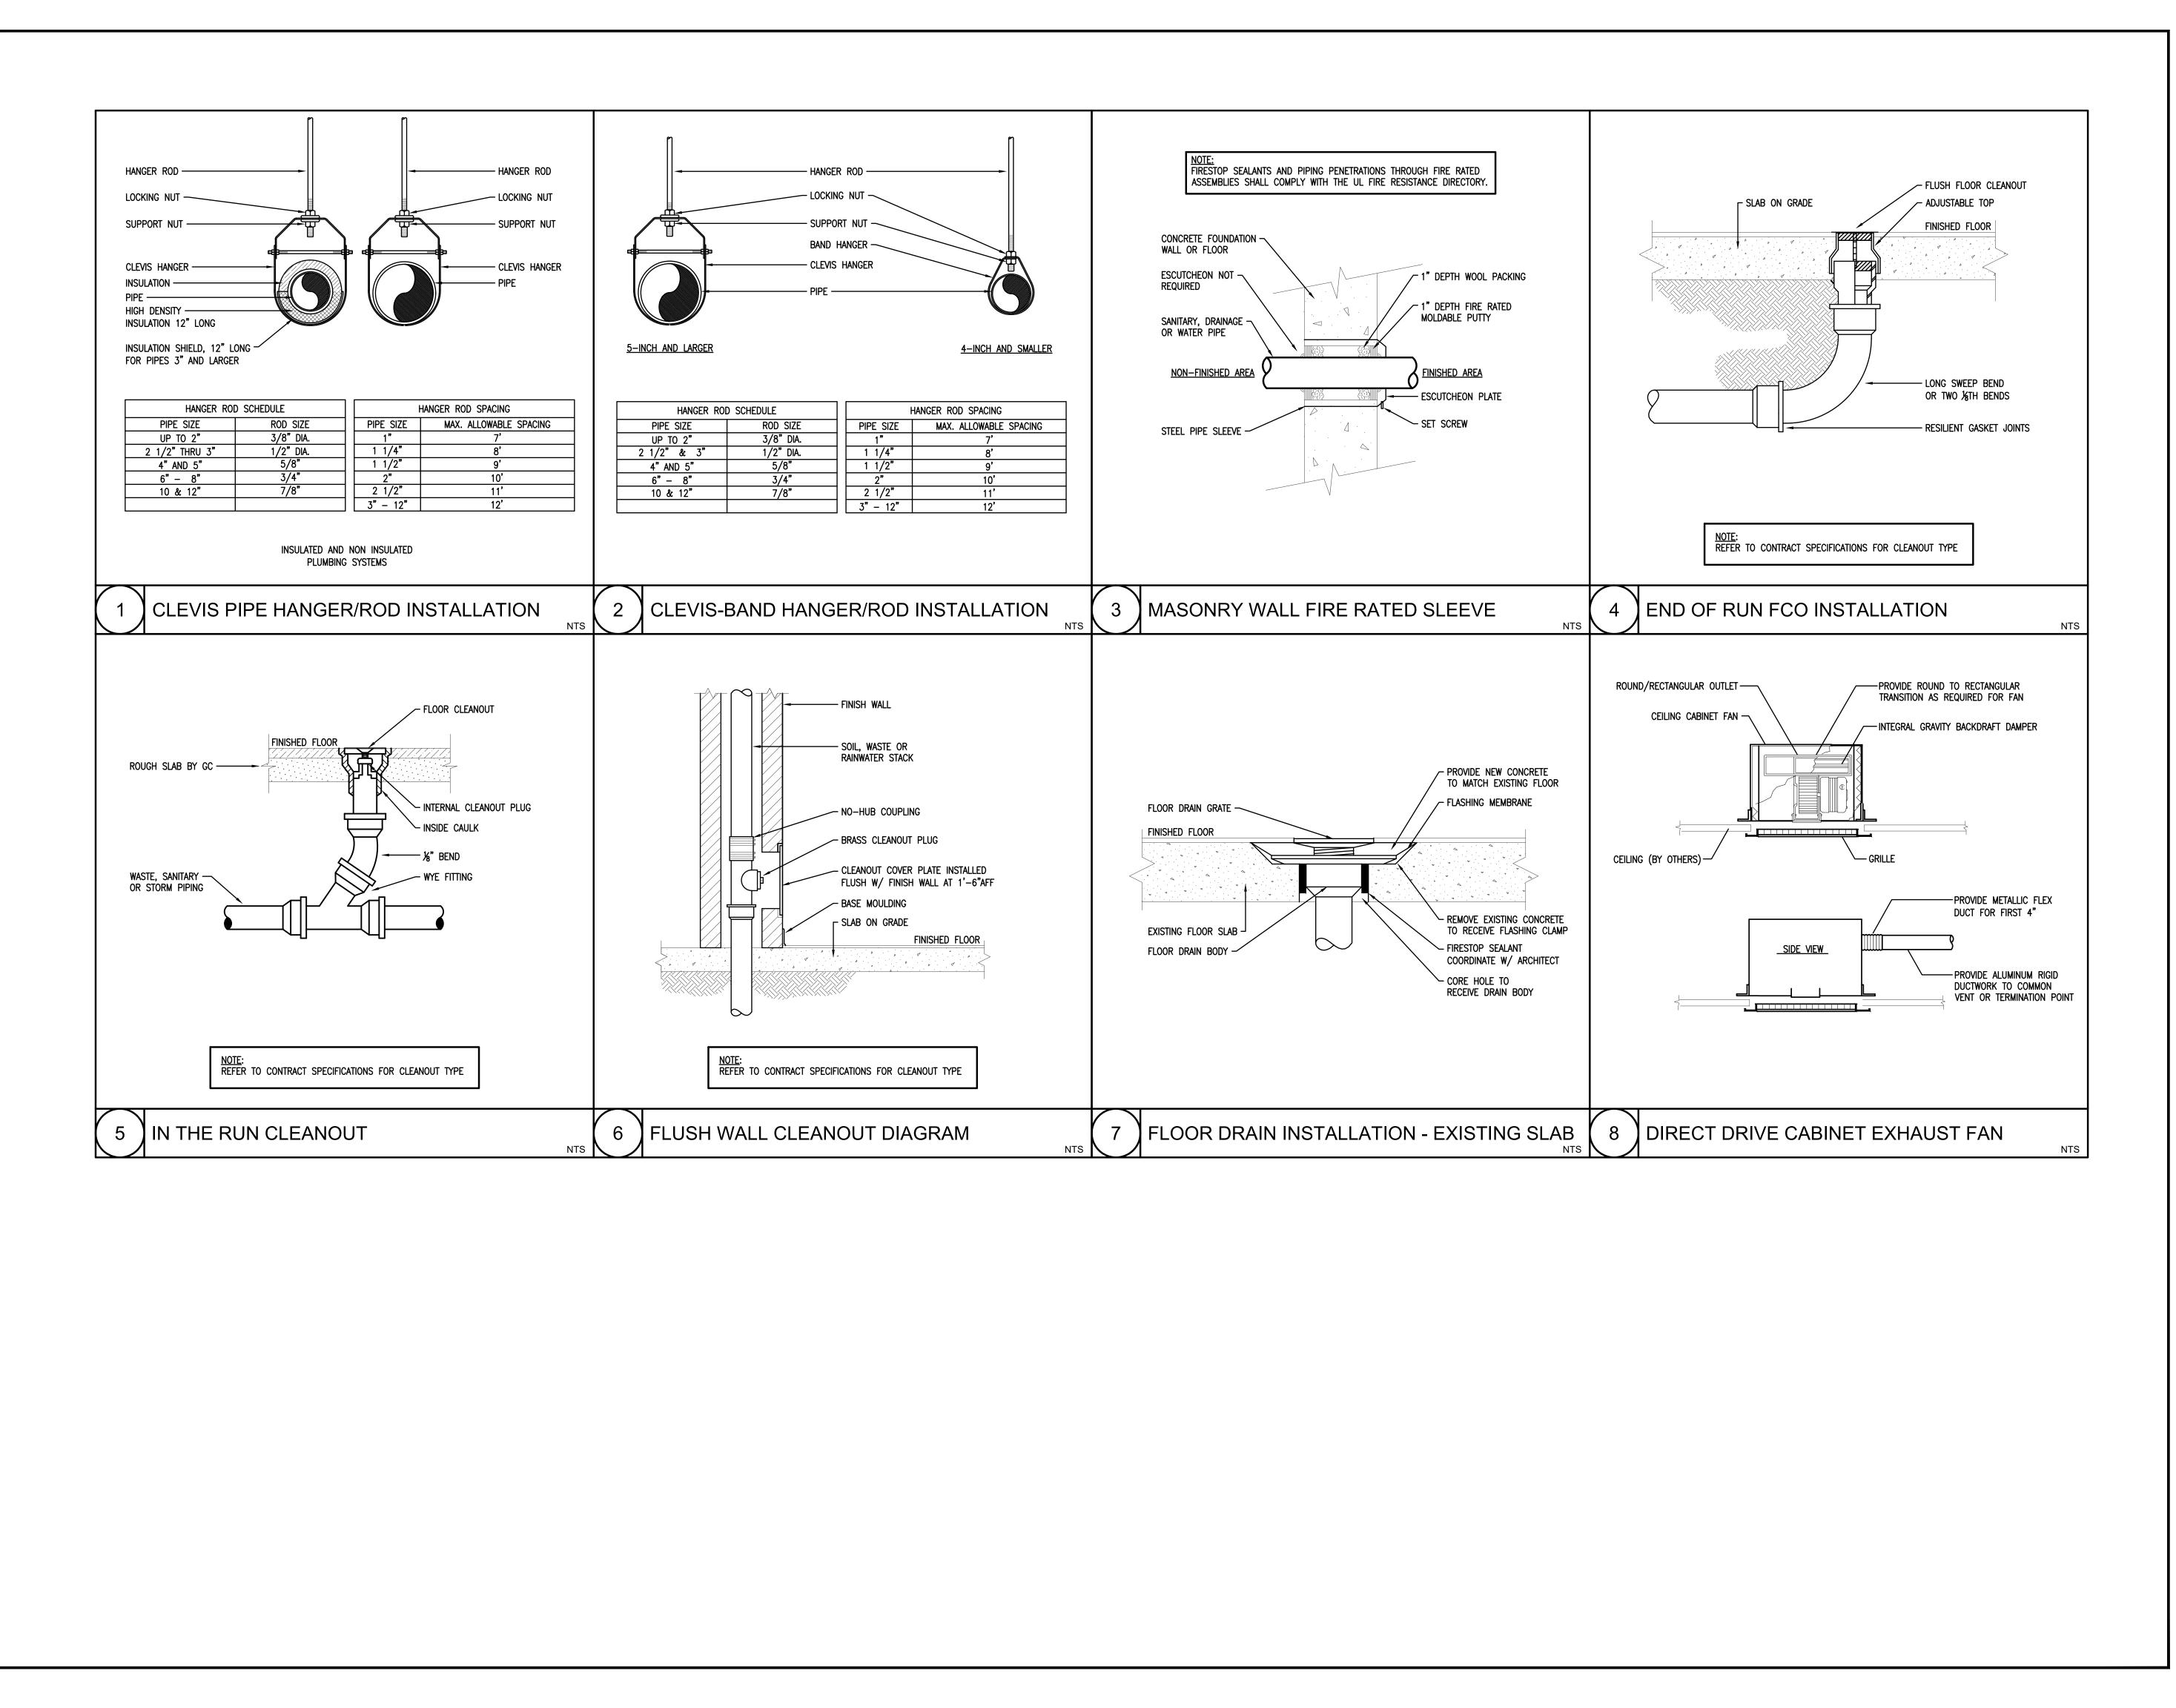




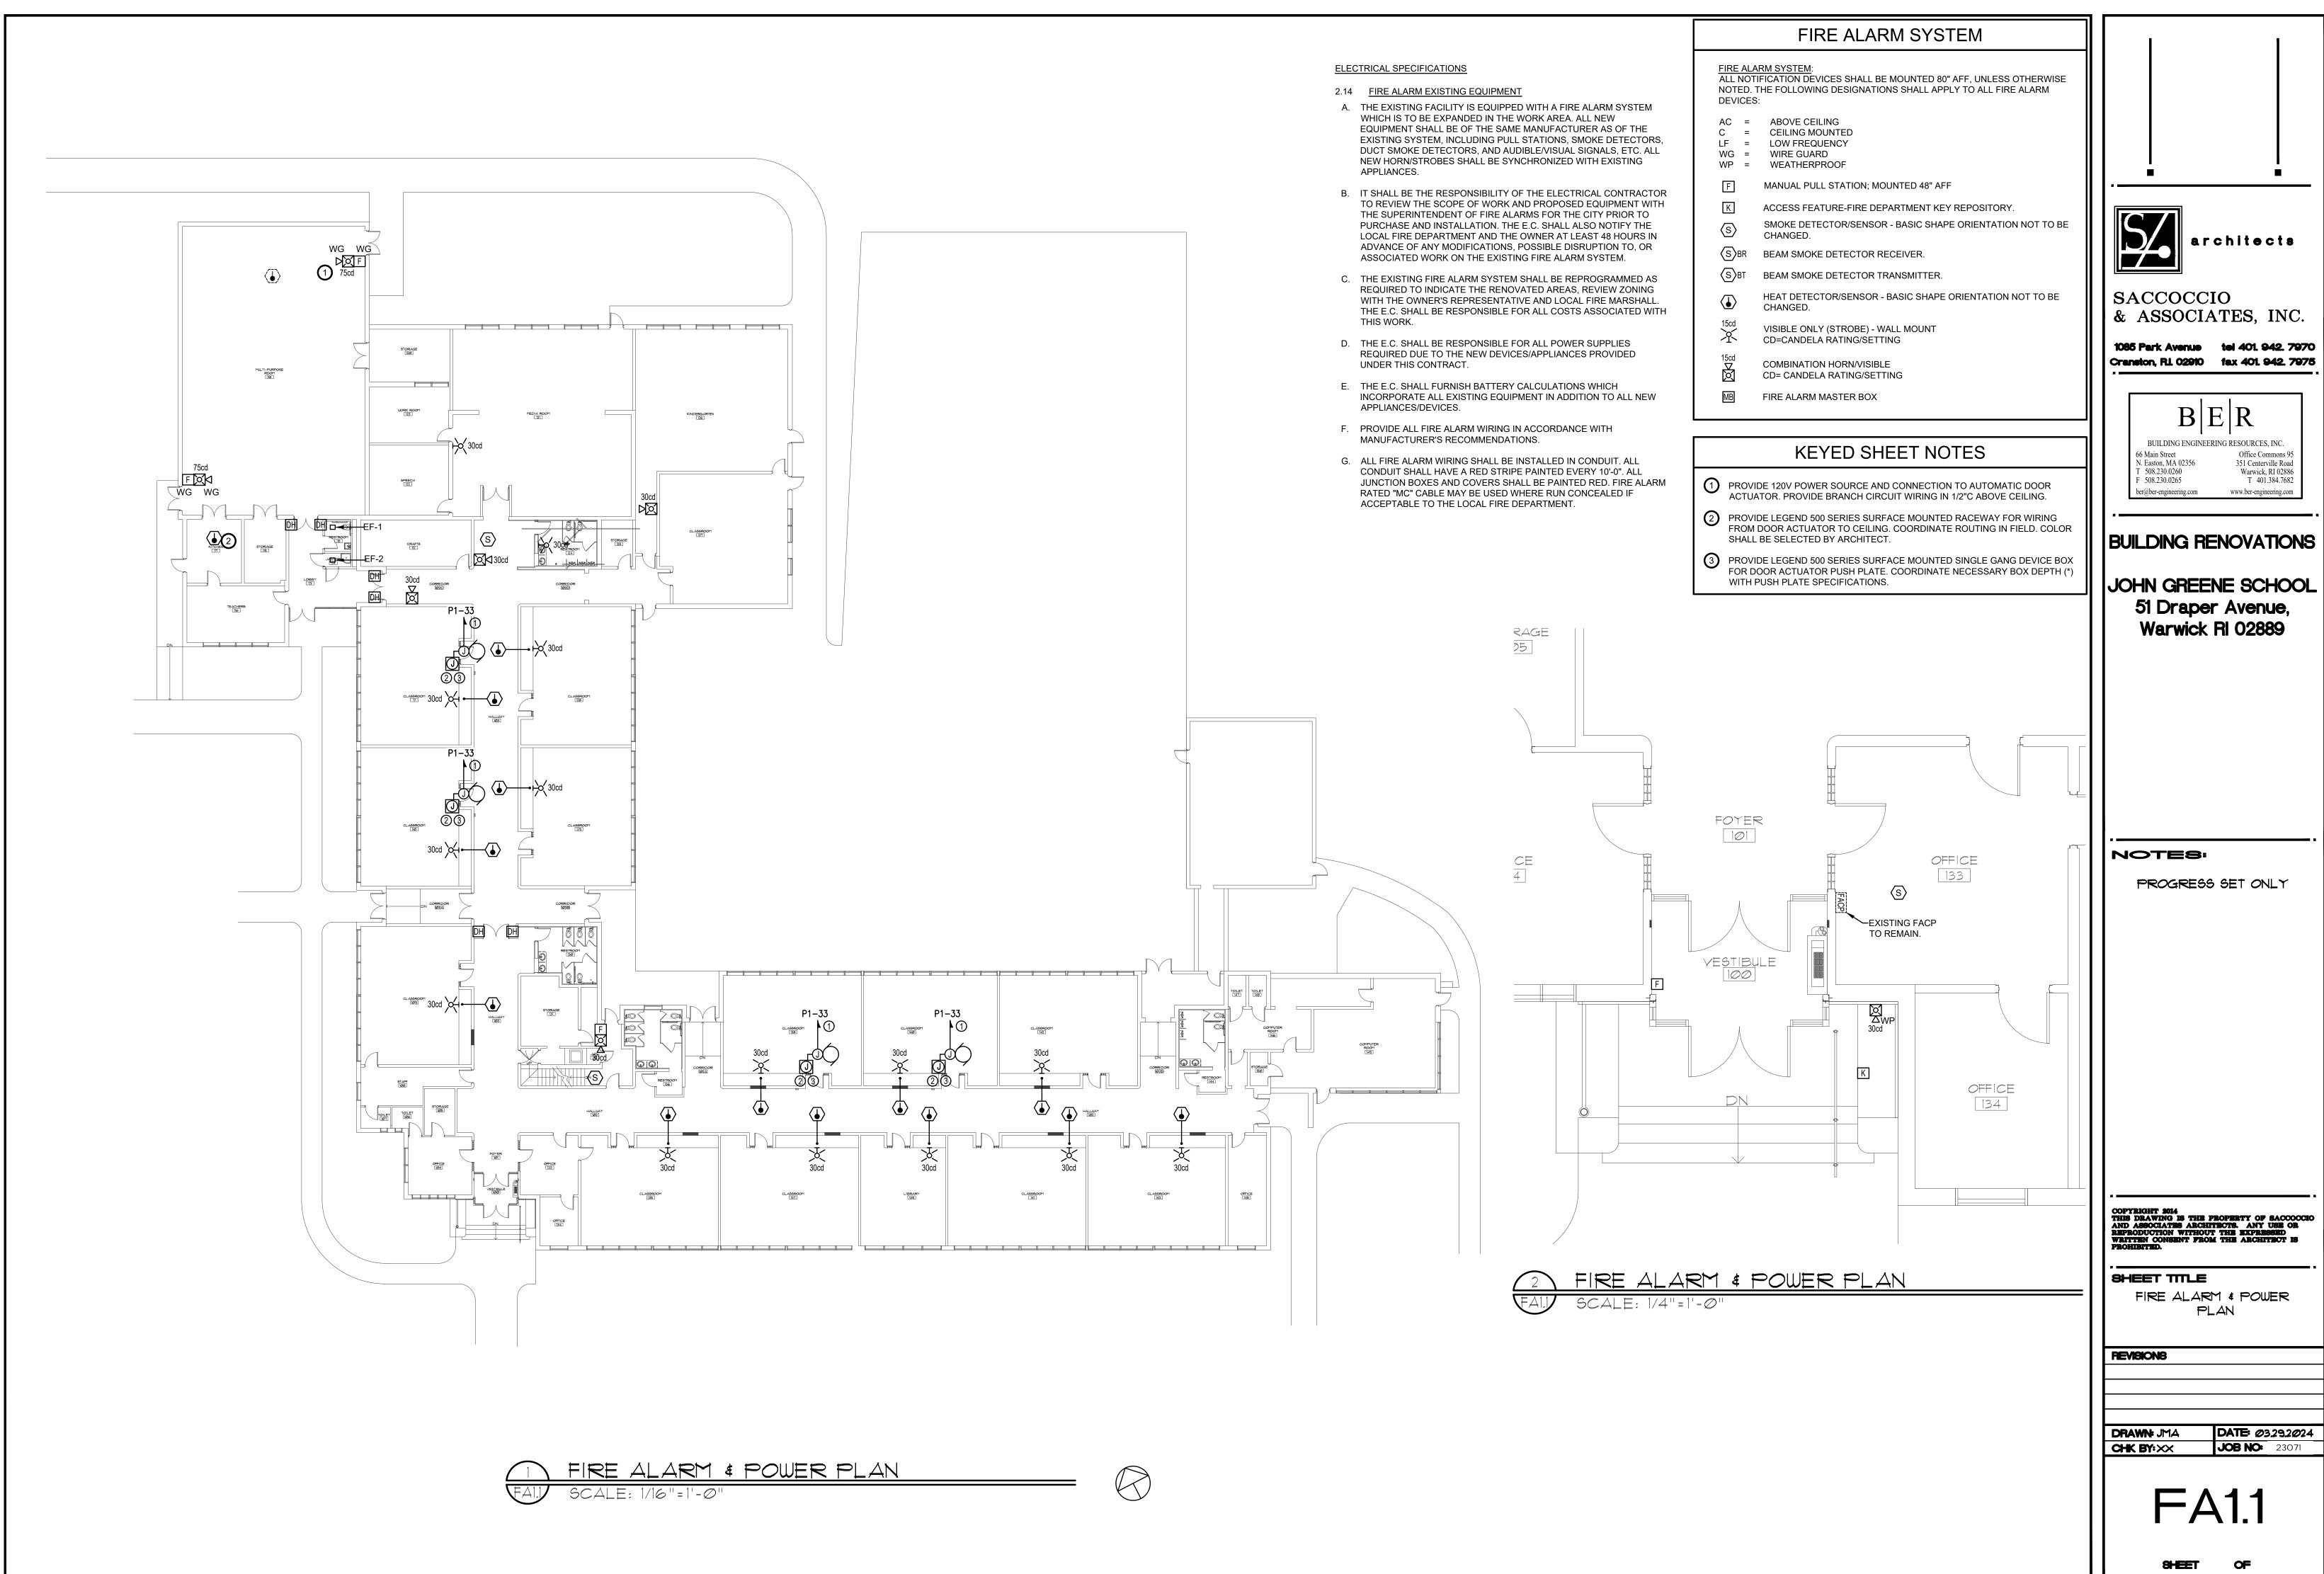








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P2.0
SHEET OF





ELECTRICAL POWER PLAN 



SCALE: 1/16"=1'-Ø"

	POWER DISTRIBUTION SYSTEM
1	<ul> <li>JUNCTION BOX, SIZED PER NEC</li> <li>MOTOR, "2" DENOTES HORSEPOWER</li> </ul>
	LIGHTING CONTROL DEVICES
	Sa SINGLE POLE TOGGLE SWITCH; SUBSCRIPT INDICATES LIGHTING FIXTURE CONTROL.
	KEYED SHEET NOTES
0	<b>KEYED SHEET NOTES</b> PROVIDE 120V POWER SOURCE AND CONNECTION TO AUTOMATIC DOOR ACTUATOR. PROVIDE BRANCH CIRCUIT WIRING IN 1/2"C ABOVE CEILING.
(1) (2)	PROVIDE 120V POWER SOURCE AND CONNECTION TO AUTOMATIC DOOR
	PROVIDE 120V POWER SOURCE AND CONNECTION TO AUTOMATIC DOOR ACTUATOR. PROVIDE BRANCH CIRCUIT WIRING IN 1/2"C ABOVE CEILING. PROVIDE LEGEND 500 SERIES SURFACE MOUNTED RACEWAY FOR WIRING FROM DOOR ACTUATOR TO CEILING. COORDINATE ROUTING IN FIELD. COLOR

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SHEET TITLE Electrical Power Plan
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