EXTERIOR DOOR UPGRADES at

Hoxsie Elementary School

55 GLENWOOD DRIVE, WARWICK, RI 02889



Robertson Elementary School

70 NAUSAKET ROAD, WARWICK, RI 02886

E.T. Wyman Elementary School

1 COLUMBIA AVENUE, WARWICK, RI 02888


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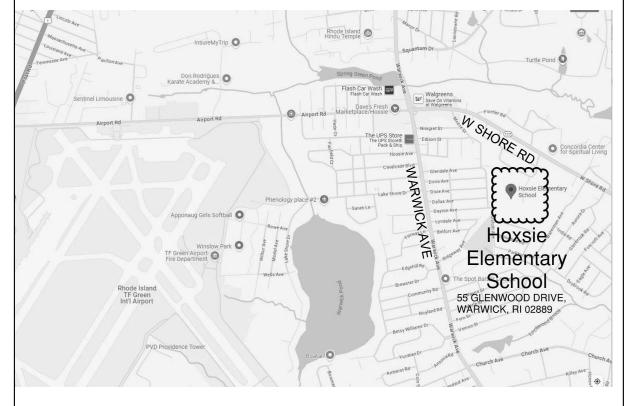


ISSUED FOR PERMIT AND CONSTRUCTION


WARWICK PUBLIC SCHOOL BID NUMBER: 25-0015

LOCUS PLAN



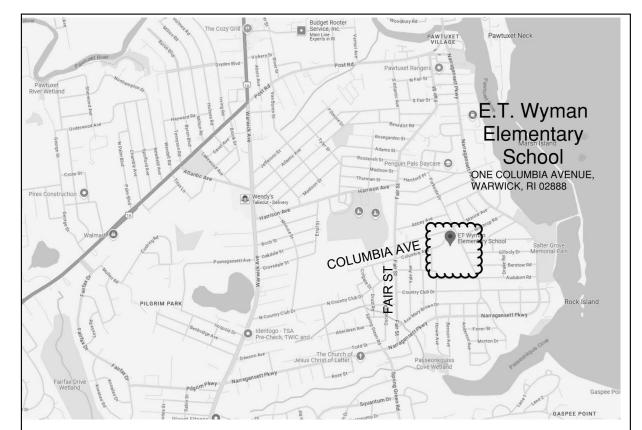



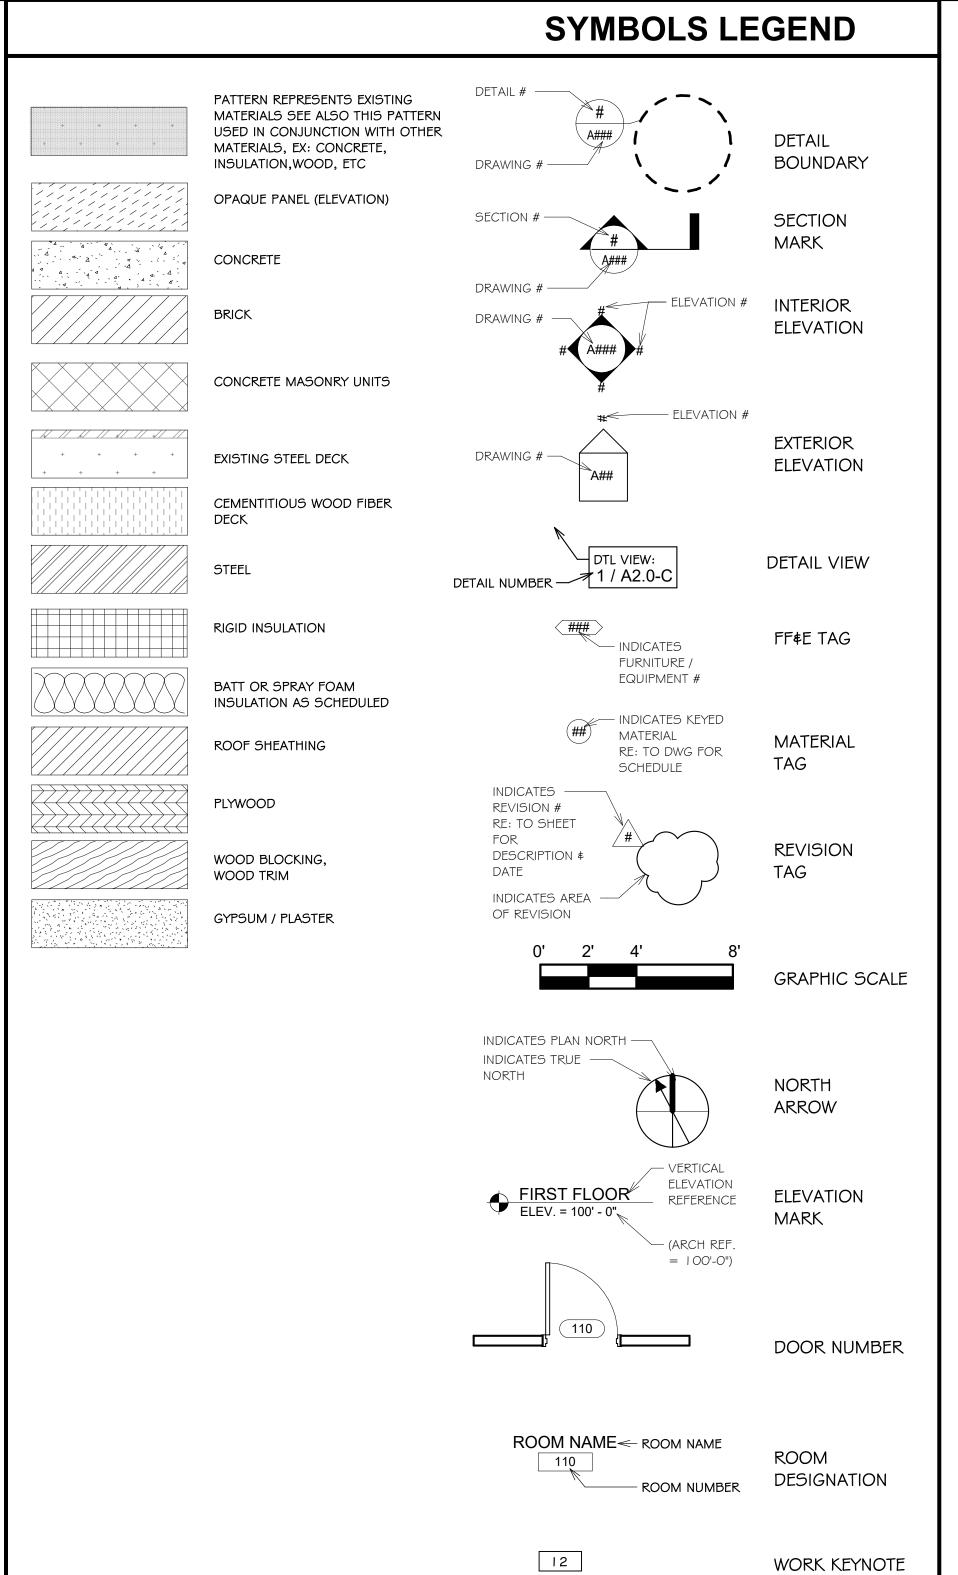

CODE INFORMATION

CODE LIST:

- RISBC-1 2021 RI BUILDING CODE WITH IBC-2018
- RISBC-8 2021 RI ENERGY CONSERVATION CODE WITH IECC-2018 • RHODE ISLAND 2021 FIRE CODE WITH NFPA-1 2018
- RHODE ISLAND 2021 LIFE SAFETY CODE WITH NFPA-101 2018

RHODE ISLAND BUILDING CODE

SECTION 305 - CLASSIFICATIONS OF OCCUPANCY (E) EDUCATION - EXISTING **BUILDING CONFIGURATION TO REMAIN**

Chapter 6 - Type of Construction:

EXISTING CONSTRUCTION TYPE UNCHANGED, THROUGH PENETRATIONS TO MATCH

FIRE RATING OF WALL AND CEILING AND FLOOR.

PROJECT RENOVATIONS FOLLOW NEW CONSTRUCTION REQUIREMENTS, EGRESS UNCHANGED.

Chapter 16 - Structural:

Chapter 10 - Means of Egress:

SBC-1 WIND SPEED TABLE, RISK CATEGORY 3, WARWICK 136/139 - XWB2 - WB1/WB1 FIGURE 1609(A) SCHOOL LOCATION IS INSIDE WIND-BORNE COASTAL REGION OFFSET.

RHODE ISLAND ENERGY CONSERVATION CODE

Building Envelope Requirements: Fenestration (table C402.1.4) Our Building

Typical Windows		
U-Factor	.38	.38 or less
SHGC	.40	.40 or less
Entrance Doors		
U-Factor	.77	.77 or less

FIRE CODE NFPA 101 2018

CHAPTER 15 - EXISTING EDUCATION

PROJECT RENOVATIONS FOLLOW NEW CONSTRUCTION REQUIREMENTS, EGRESS AND LIFE SAFETY UNCHANGED.

HORIZ = HORIZONTAL

HRDWR = HARDWARE

GLASS

ID = INSIDE DIAMETER

INSUL = INSULATION

LWT = LIGHTWEIGHT

MAS = MASONRY

MAT = MATERIAL

MAX = MAXIMUM

MIN = MINIMUM

MTD = MOUNTED

MTL = METAL

NO = NUMBER

OC = ON CENTER

OPNG = OPENING

OPP = OPPOSITE

OP = OPAQUE PANEL

OD = OUTSIDE DIAMETER

OS = OVERFLOW SCUPPER

OSDS = OVERFLOW SCUPPER

MECH = MECHANICAL

MISC = MISCELLANEOUS

MFG = MANUFACTURER

N/A = NOT APPLICABLE

NTS = NOT TO SCALE

NIC = NOT IN CONTRACT

MO = MASONRY OPENING

INT = INTERIOR

JAN = JANITOR

JT = JOINT

AIR CONDITIONING

LCC = LEAD COATED COPPER

HP = HIGH POINT

HR = HOUR

ABBREVIATION

- = NO WORK NEEDED ABV = ABOVEAC = AIR CONDITIONERAFF = ABOVE FINISH FLOOR ALUM = ALUMINUMALT = ALTERNATEBD = BOARDBLDG = BUILDINGBLKG = BLOCKINGBRK = BREAKBUR = BUILT-UP ROOF CBB = CEMENTITIOUS BACKER BOARD CJ = CONTROL JOINT CLR = CLEARCMU = CONCRETE MASONRY UNIT(S) CNTR = COUNTER CO = CLEAN OUT COL = COLUMNCONC = CONCRETE CONT. = CONTINUOUS CONST = CONSTRUCTION CORR = CORRIDOR DEMO = DEMOLISH/DEMOLITION DTL = DETAILDIA = DIAMETER DIM = DIMENSIONDOCS = DOCUMENTS DN = DOWNDR = DOORDS = DOWN SPOUT DWG = DRAWING

EIFS = EXTERIOR INSULATION FINISH SYSTEM EJ = EXPANSION JOINT ELEC = ELECTRIC/ELECTRICAL

EPDM = ETHYLENE PROPYLENE

DIENE TORPOLYMER EQ = EQUALEQP = EQUIPMENT ETR = EXISTING TO REMAIN EXTR = EXTERIOREXIST = EXISTINGFEOP = FORECED ENTRY RESISTANT

OPAQUE PANEL FERG = FORCED ENTRY RESISTANT GLASS FF = FINISH FLOOR FF = FACTORY FINISH FIN = FINISHFLG = FLASHING

FLR = FLOORFOC = FACE OF CONCRETE FOS = FACE OF STUD FR = FIRE RATEDFRM = FRAMEFT = FOOT/FEETGC = GENERAL CONTRACTOR

AND/OR CONTRACTOR GA = GAUGEGALV = GALVANIZEDGC = GENERAL CONTRACTOR GEN = GENERALGLU.LAM = GLUE LAMINATEDGWB = GYPSUM WALL BOARD

HM = HOLLOW METAL

HDG = HOT DIPPED GALVANIZED HMG = HOLLOW METAL GALVANIZED

AND DOWN SPOUT OTS = OPEN TO STRUCTURE PERP = PERPENDICULAR PLYWD = PLYWOODPP = PITCH POCKET PREP = PREPAREPT = PAINTPT = PRESSURE TREATED PTD = PAINTEDPVC = POLYVINYL CHLORIDE R#D = REMOVAL AND DISPOSAL R&P = REMOVE AND PRESERVE RS-DS = ROOF SCUPPER \$ DOWNSPOUT RAD = RADIUS

RD = ROOF DRAIN

REBAR = REINFORCEMENT BAR(S) REINF = REINFORCEMENT REQ'D = REQUIREDRF = ROOF

HRG = HURRICANE RESISTANT RMK = REMARKHVAC = HEATING/ VENTILATING/ RND = ROUNDRO = ROUGH OPENING RS = ROLLER SHADES SC-B = SCUPPER BOX SB = SPLASH BLOCK SF = SQUARE FOOT/FEET SECT = SECTION SIM = SIMILARSPEC = SPECIFICATIONS SQ = SQUARESS = STAINLESS STEEL

STL = STEEL STOR = STORAGE STRUC = STRUCTURAL

T&G = TONGUE & GROOVE

TEMP = TEMPEREDTERM = TERMINATIONTHK = THICKTOS = TOP OF STEEL TOW = TOP OF WALL TYP = TYPICAL UNO = UNLESS NOTED OTHERWISE VERT = VERTICAL VIF = VERIFY IN FIELD VP = VENT PIPEW/ = WITHWD = WOODWIN = WINDOW W/O = WITHOUTWP = WATERPROOF(ING)WR = WATER RESISTANT

WWM = WELDED WIRE MESH

DRAWING LIST

<u>GENERAL</u>

DRAWING LIST, CODE INFORMATION, SYMBOLS, ABBREVIATIONS

GI.I GENERAL NOTES, GENERAL DEMOLITION NOTES

HOXSIE ARCHITECTURAL

AD I.O-A FLOOR PLAN - DEMOLITION

FLOOR PLAN A1.0-A

A2.0-A DOOR & FRAME SCHEDULE, DOOR TYPES, FRAME TYPES

A2.1-A DOOR DETAILS

ROBERTSON ARCHITECTURAL

AD I .O-B FLOOR PLAN - DEMOLITION

A1.0-B FLOOR PLAN

DOOR & FRAME SCHEDULE, DOOR TYPES, FRAME TYPES

DOOR DETAILS

WYMAN ARCHITECTURAL

AD I.O-C FLOOR PLANS - DEMOLITION

FLOOR PLANS

DOOR & FRAME SCHEDULE, DOOR TYPES, FRAME TYPES, DETAILS

A2.1-C DOOR DETAILS

PROJECT DESCRIPTION:

RENOVATIONS TO EXISTING HOXSIE ELEMENTARY SCHOOL BUILDING, ROBERTSON ELEMENTARY SCHOOL BUILDING, E.T. WYMAN ELEMENTARY SCHOOL BUILDING INCLUDING:

I. REMOVE AND DISPOSE OF EXISTING STOREFRONT DOOR ENTRY SYSTEMS. PROVIDE NEW, HURRICANE RESISTANT INSULATED STOREFRONT DOOR AND FRAME

2. REMOVE AND DISPOSE OF EXISTING EXTERIOR HOLLOW METAL DOOR AND FRAME SYSTEMS. PROVIDE NEW HURRICANE RESISTANT EXTERIOR HOLLOW METAL DOOR AND FRAMES SYSTEMS.

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1085 Park Avenue

Cranston, Rhode Island 02910

Consultant

EXTERIOR DOOR **UPGRADES**

Hoxsie **Elementary School** 55 Glenwood Drive, Warwick, RI 02889

Robertson **Elementary School** 70 Nausaket Road, Warwick, RI 02886

E.T.Wyman **Elementary School** 1 Columbia Avenue, Warwick, RI 02888

Revision Schedule

Revision Number Revision Date

SHEET TITLE DRAWING LIST, CODE INFORMATION, SYMBOLS, **ABBREVIATIONS**

THIS DRAWING IS THE PROPERTY OF SACCOCCIO AND ASSOCIATES ARCHITECTS. ANY USE OR REPRODUCTION WITHOUT THE EXPRESSI WRITTEN CONSENT FROM THE ARCHITECT IS PROHIBITED. DRAWN BY: DA, KC JOB NUMBER:

CHECKED BY: SG DATE: 02/25/25

SHEET: I OF: 14

GENERAL NOTES: THE CONTRACTOR SHALL PROVIDE AND COMPLY WITH

- I. THE CONTRACTOR IS REQUIRED TO VISIT THE JOB SITE AND FAMILIARIZE HIMSELF COMPLETELY WITH ALL EXISTING CONDITIONS RELATIVE TO THE NEW WORK CALLED FOR ON THE DRAWINGS AND SPECIFICATIONS. NO COMPENSATION FOR EXTRA WORK ON BEHALF OF THE CONTRACTOR WILL BE CONSIDERED THAT WOULD HAVE BEEN DETERMINED BY VISUAL OBSERVATION PRIOR TO BIDDING.
- 2. ASBESTOS HAS BEEN IDENTIFIED IN THE ELEMENTARY BUILDINGS, REFER TO THE ASBESTOS REPORT IN THE SPECIFICATIONS SECTION 003 I 19. NOTIFY THE ARCHITECT IMMEDIATELY OF ANY ADDITIONAL ASBESTOS MATERIAL
- 3. UNDERSTAND THAT THE TERM "PROVIDE" AS LISTED ON THE ARCHITECTURAL DRAWINGS SHALL MEAN "FURNISH AND
- 4. UNDERSTAND THE TERM "MATCH EXISTING" AS LISTED ON THESE DRAWINGS SHALL MEAN THAT WORK TO BE PERFORMED MUST BE OF SIMILAR MATERIALS, CONSTRUCTION AND FINISHED TO THE LINES OF ADJACENT ELEMENTS IN ALL RESPECTS.
- 5. UNDERSTAND THAT THE TERM "TYPICAL" AND "TYP" AS NOTED ON THESE DRAWINGS SHALL MEAN ALL LIKE ITEMS REQUIRING THE SAME WORK ARE PART OF THE PROJECT, UNLESS NOTED OTHERWISE.
- 6. UNDERSTAND THAT THE TERM "REMOVE" AND "REMOVE AND DISPOSE" (R&D) AS NOTED ON THESE DRAWINGS SHALL BE DEFINED AS THE REMOVAL AND DISPOSAL OF THE NOTED ELEMENT AS WELL AS ALL ITS RELATIVE COMPONENTS, FASTENERS, ETC. THE TERM "REMOVE AND PRESERVE" (R&P) REFERS TO ITEMS REMOVED TO PERFORM NEW WORK AND TO BE REINSTALLED.
- 7. UNDERSTAND THAT THE DIMENSIONS AND QUANTITIES FOUND ON THESE DRAWINGS OF THE EXISTING BUILDING AND EXISTING EQUIPMENT SHOWN ARE FOR GENERAL REFERENCE. VERIFY DIMENSIONS & QUANTITIES & CONDITIONS IN THE
- 8. BE RESPONSIBLE FOR CUTTING, DRILLING, FILLING, PATCHING AND/OR REPAIRING OF EXISTING WALLS, FLOORS, CEILINGS, ROOFS, AND OTHER BUILDING ELEMENTS AS REQUIRED FOR THE INSTALLATION OF NEW WORK, IN THE EXISTING BUILDING. (VERIFY ALL CONDITIONS IN THE FIELD).
- 9. PATCH AND REPAIR WALLS, FLOORS, CEILINGS, ROOFS AND OTHER BUILDING AND SITE ELEMENTS IN AREAS AFFECTED BY DEMOLITION WORK FROM ALL TRADES. WORK TO BE PERFORMED MUST BE OF SIMILAR MATERIALS. CONSTRUCTION AND FINISHED TO THE LINES OF ADJACENT WORK. PAINT THE ENTIRE CEILING OR WALL IN A ROOM OR AREA, FROM PERPENDICULAR WALL TO PERPENDICULAR WALL. AT NEW ACOUSTICAL TILE CEILING SYSTEMS PAINT TO SIX INCHES ABOVE ACT CEILING SYSTEM. AT REMOVE STAINED AND DAMAGED VCT FLOORING, PATCH WITH MATCHING. COLORS SELECTED BY ARCHITECT.
- IO. COORDINATE MECHANICAL, PLUMBING, FIRE PROTECTION, ELECTRICAL, FIRE ALARM, CIVIL, AND ALL OTHER WORK INCLUDED IN THIS CONTRACT, WITH THE ARCHITECTURAL DRAWINGS PRIOR TO PROCEEDING WITH THE NEW WORK.
- II. GC IS RESPONSIBLE TO RECORD LOCATIONS OF EXISTING EQUIPMENT FASTENED TO THE EXISTING DOOR SYSTEMS. REMOVE AND PRESERVE AND REINSTALL IN THE NEW WORK INCLUDING ELECTRICAL, FIRE ALARM, SECURITY EQUIPMENT. COORDINATE SECURITY EQUIPMENT REMOVAL AND REINSTALL WITH SCHOOL PRIOR TO CONSTRUCTION.
- I 2. PROVIDE DUST PARTITIONS AS REQUIRED TO KEEP AREAS OUTSIDE OF SCOPE FREE OF DIRT AND DUST. THE GENERAL CONTRACTOR WILL BE RESPONSIBLE FOR CLEANING ANY AREAS LEFT UNPROTECTED.
- I 3. BE RESPONSIBLE TO CLEAN THE WORK AREA AT THE END OF EACH WORK DAY. ALL TRASH AND DEBRIS TO BE REMOVED FROM THE BUILDING.
- 14. REPLACE OR REPAIR ANY DISTURBED AREAS IN AND OUTSIDE THE WORK LIMITS AREA.
- 15. PROVIDE A BARRIER BETWEEN PRESSURE TREATED WOOD / FIRE TREATED WOOD AND METAL: PROVIDE SELF ADHERING 14 MIL POLYPROPYLENE FILM / SYNTHETIC BUTYL EQUAL TO BLUE SKIN BUTYL FLASH BY HENRY. ENSURE MEMBRANE IS COMPATIBLE WITH SEALANTS AND OTHER BUILDING PRODUCTS.
- I G. PROVIDE, AT EXTERIOR ENVELOPE, PRESSURE TREATED WOOD AND PRESSURE TREATED PLYWOOD COMPLYING WITH CODE AND RIDE REQUIREMENTS, PRESSURE TREATMENT WITH MICRONIZED COPPER AZOLE (MCA) OR EQUAL AS NOTED IN THE ICC-ES REPORT "ESR-1721" DATED MAY 2020 OR AFTER. WOOD TREATMENT SYSTEM TO BE COMPLIANT WITH BUILDING CODE AND RIDE REQUIREMENTS. SEPARATE TREATED WOOD FROM METAL WITH SELF ADHERING MEMBRANE COMPATIBLE WITH BUILDING MATERIALS AND SEALANTS EQUAL TO BLUE SKIN BUTYL FLASH. DO NOT USE PRESSURE TREATED WOOD, PT WD SHIMS, ETC, AT EXTERIOR DOOR FRAMES AND STOREFRONT SYSTEMS.
- 17. PROVIDE FIRE SEAL AROUND THRU PENETRATIONS AT FIRE RATED CONSTRUCTION, INCLUDING SMOKE BARRIER.
- I 8. PROVIDE AIR SEALING AT EXTERIOR ENVELOPE WORK: INCLUDING STOREFRONT SYSTEMS, DOOR SYSTEMS. PROVIDE SILICONE SEALANT EQUAL TO DOWSIL-795 BY DOW OR SPECTREM-2 BY TREMCO. SEAL AT THRU PENETRATIONS, HOLES, CRACKS, AND SEAMS BETWEEN SYSTEMS. PROVIDE INSULATION FILL OF LOW PRESSURE POLYURETHANE AEROSOL FOAM EQUAL TO DOW GREAT STUFF PRO WINDOW \$ DOOR AT DOOR FRAME SHIM SPACES. PROVIDE CONTINUOUS AIR SEALING. SEAL AGAINST WIND AND WATER PENETRATION.
- 19. DURING CONSTRUCTION COVER / SEAL OPEN DUCTS, PENETRATIONS, ETC. THAT WILL BE SUSCEPTIBLE TO DUST INFILTRATION. SUBMIT DOCUMENTATION TO THE ARCHITECT BEFORE CONSTRUCTION BEGINS.
- 20. DO NOT CHANGE THE BUILDING STRUCTURE. IF CONDITIONS DIFFER TO WHAT IS SHOWN ON DRAWINGS, NOTIFY ARCHITECT PRIOR TO COMMENCING WORK.
- 21. MATERIALS REQUIRING COLOR SELECTION COLORS SELECTED BY THE ARCHITECT: INCLUDING MASONRY, STOREFRONT SYSTEM, GLASS, OPAQUE PANELS, SEALANTS, VCT FLOORING, ETC., SUBMIT COLOR CHARTS AND PHYSICAL SAMPLES AND A DIGITAL COPY OF CHARTS / SAMPLES, PER SPECIFICATIONS.
- 22. GC RESPONSIBLE TO LAYOUT WORK PRIOR TO CONSTRUCTION. NOTIFY ARCHITECT OF ANY CONDITIONS DIFFERING FROM THE CONTRACT DOCUMENTS.
- 23. DEMOLITION AND NEW CONSTRUCTION TO COMPLY WITH ALL RHODE ISLAND DEPARTMENT OF EDUCATION (R.I.D.E.) REQUIREMENTS AND REPORTING REQUIREMENTS. SEE NORTHEAST COLLABORATIVE FOR HIGH PERFORMANCE SCHOOLS (NORTHEAST-CHPS) GUIDELINES AT R.I.D.E. WEB SITE.

MASONRY WALL PATCHING

- 24. PROVIDE AT DOOR ROUGH OPENING, A SOLID SUBSTRATE FOR DOOR FASTENING. REPAIR BROKEN MASONRY AND CONCRETE AT HEAD AND JAMB AND SILL, FILL HOLES AND CRACKS, REFORM LOOSE AND BROKEN MASONRY AND CONCRETE, PROVIDE MASONRY REPAIRS AND CEMENTITIOUS PATCHING SYSTEM FOR SMOOTH MONOLITHIC
- 25. PROVIDE INFILL CEMENT SYSTEM, WHERE NOTED, FORM PRIOR TO STOREFRONT AND DOOR INSTALL. EQUAL TO (A) SIKAQUICK-VOH CEMENT AND SIKADUR-32-HI-MOD PRIMER. REMOVE LOOSE MATERIALS AND DIRT. APPLY CEMENT WHILE PRIMER IS WET / TACKY. ADDITIONAL CEMENT REPAIR SYSTEMS (B) ARDEX TWP AND ARDEX EP 2000 (C) ABATRON ABOWELD 55-1 AND ABATRON PRIMKOTE 8006-1. PROVIDE REPAIR SYSTEM FROM ONE MANUFACTURER.
- 26. MASONRY WALL REPAIR BASIS OF DESIGN: REFER TO "TECHNICAL NOTE 46: MAINTENANCE OF BRICK MASONRY" \$ "TECHNICAL NOTE 7: WATER PENETRATION RESISTANCE - DESIGN AND DETAILING" BY BRICK INDUSTRY ASSOCIATION (WWW.GOBRICK.COM), AND REFER TO "TEK 08-0 I A: MAINTENANCE OF CONCRETE MASONRY WALLS" BY NATIONAL CONCRETE MASONRY ASSOCIATION (NCMA.ORG)
- 27. PREVENT DEBRIS FROM ENTERING CAVITY WALL. REMOVE MASONRY ABOVE AREA OF WORK SUFFICIENT TO COMPLETE WORK. TOOTH NEW MASONRY INTO EXISTING. PROVIDE "TYPE-N" WHITE MORTAR. APPLY MORTAR ALL EDGES OF MASONRY AND SLIDE REPLACEMENT UNIT (MATCHING EXISTING) INTO PLACE. TOOL JOINTS TO MATCH EXISTING. CLEAN SURFACE OF MASONRY WALL AT AREA OF REPAIR. AT THE E.T. WYMAN ELEMENTARY SCHOOL 1936 BUILDING USE HISTORIC TYPE-O MORTAR.
- 28. AREA OF MASONRY INFILL AND REPAIR PROVIDE MASONRY CLEANING: PROVIDE BUCKET AND BRUSH HAND CLEANING AT WALL WITH STIFF BRISTLE BRUSH, WATER, CLEANING MATERIAL. REPAIRS ABOVE ROOF SURFACE, PREVENT CLEANING MATERIALS AND WASH OFF FROM CONTACT WITH ROOF SYSTEM OR DAMAGING THE BUILDING. MASONRY CLEANING BASIS OF DESIGN: REFER TO "TECHNICAL NOTE 20: CLEANING BRICKWORK" BY BRICK INDUSTRY ASSOCIATION (WWW.GOBRICK.COM).
- 29. PRIOR TO COMMENCING DEMOLITION, INCLUDING MASONRY VENEER, PROVIDE TEMPORARY SHORING, BRACING, ADEQUATE TO KEEP BUILDING STATIC UNDER SUBJECTED LOADING AND SHALL REMAIN IN PLACE UNTIL NEW WORK INSTALLED

EXTERIOR DOOR REPLACEMENT

- 30. PROVIDE HURRICANE RESISTANT DOOR FRAME AND STOREFRONT FRAME ANCHORAGE TO EXISTING BUILDING: TO MEET BUILDING CODE AND MANUFACTURERS WARRANTY REQUIREMENTS. GENERAL CONTRACTOR TO PROVIDE SHOP DRAWINGS AND DATA SUBMITTAL PER SPECIFICATION 013300, WITH RHODE ISLAND LICENSED ENGINEER SEAL CERTIFYING ANCHOR SYSTEMS ARE HURRICANE RESISTANT, MEET BUILDING CODE AND MANUFACTURES REQUIREMENTS. SEE WIND LOADING DESIGN CRITERIA AT SPECIFICATIONS. INCLUDE IN ANCHORING SHOP DRAWINGS DETAILS OF STOREFRONT FASTENING TYPE AND SPACING AND EMBEDMENT FOR EACH CONDITION.
- 31. PROVIDE, AS BASIS OF DESIGN STOREFRONT: HURRICANE IMPACT RESISTANT, THERMALLY BROKEN: (ASTM-E 1996 LEVEL-D, LARGE MISSILE COMPLIANT) 2 1/2" X 5", THERMALLY BROKEN, SCREW SPLINE, FACTORY FINISHED, ALUMINUM STOREFRONT FRAMING WITH HURRICANE RESISTANT | 5/16" THICK INSULATED GLASS AND/OR OPAQUE PANELS. BASIS OF DESIGN: EFCO SERIES 526T BY EFCO CORP OR EQUAL. PROVIDE A SUBMITTAL OF DATA, DRAWINGS, CALCULATIONS, CERTIFIED AND SEALED BY A RHODE ISLAND LICENSED ENGINEER, STOREFRONT SYSTEM IS HURRICANE RESISTANT, RESISTANT TO LOCAL WEATHER PER 0843 | 3-1.05. PROVIDE EQUAL EXTERIOR ALUMINUM STOREFRONT SYSTEMS: (1)-KAWNEER 2 1/2" X 5" THERMALLY BROKEN MODEL-521T, (2)-YKK 2 1/2" X 5" THERMALLY BROKEN MODEL-YHS-50-TU, EQUAL ALUMINUM DOOR SYSTEMS WITH INTEGRAL PANIC BAR: (A) KAWNEER MODEL -500 HEAVY WALL WIDE STYLE, (B) YKK MODEL -50H HEAVY DUTY. PROVIDE WITH SYSTEM SUBMITTAL DIGITAL AND PHYSICAL COLOR CHARTS AND COLOR SAMPLES INCLUDING ALUM DOOR HARDWARE AND PULL HANDLE AND CONTINUOUSE HINGE. COLORS SELECTED BY ARCHITECT. ALL PARTS OF SYSTEM FROM SAME COMPANY.
- 32. PROVIDE AS BASIS OF DESIGN GLASS: (FERG: 5AAL-12 MIN OR ASTM-F1233 CLASS-1.4, HRG: ASTM E1886/ E 1996 OR TAS-20 1 / 203): TINTED GRAY EQUAL TO GUARDIAN CRYSTAL GRAY COLOR OR VITRO OPTIGRAY COLOR (SELECTED / APPROVED BY ARCHITECT), LOW-E (#2) EQUAL TO GUARDIAN SNG8 OR SOLARBAN 70 PROPERTIES, WITH VISIBLE LIGHT TRANSMITTANCE 0.43, U-VALUE 0.26, SOLAR HEAT GAIN COEFFICIENT 0.22. AT DOORS AND HM FRAMES, PROVIDE I" THICK GLASS UNITS, I 5/16" THK GLASS UNITS AT STOREFRONT, FORCED ENTRY RESISTANT GLASS (FERG) INTER LAYER EQUAL TO SCHOOL GUARD GLASS SG5 OR OLD CASTLE ARMORPROTECT PLUS 121000 TO 7'-0" ABOVE FINISHED FLOOR. ABOVE 7'-0"AFF PROVIDE HURRICANE RESISTANT GLASS (HRG) INTER LAYER EQUAL TO 0.060 PVB OR SGP. FERG AND HRG UNITS TO BE INSTALLED WITH STRUCTURAL SILICONE SEALANT EQUAL TO DOWSIL 995 PER GLASS MANUFACTURER REQUIREMENTS AND DETAILS AND MEET CODE.
- 33. PROVIDE AS BASIS OF DESIGN OPAQUE PANEL: FORCED ENTRY / HURRICANE RESISTANT OPAQUE PANELS (FEOP OR OP): PROVIDE I" THICK AT ALUMINUM DOORS AND H.M. DOORS & H.M. FRAMES, I 5/16" THICK AT STOREFRONT, INTERIOR/EXTERIOR FINISH LAYER: FACTORY PAINTED 0.032 ALUMINUM, INTERIOR/EXTERIOR SUBSTRATE LAYER: HIGH DENSITY HARD BOARD, HURRICANE RESISTANT LAYER, CORE: POLYISOCYANURATE. PROVIDE INSTALLATION EQUAL TO FERG GLASS INCLUDING STRUCTURAL SEALANT EQUAL TO DOWSIL 995 STRUCTURAL SEALANT. PANEL EQUAL TO MAPESHEILD BY MAPES CORP. COLORS SELECTED BY ARCHITECT. ALL OPAQUE PANELS IN DOORS AND DOOR FRAMES ARE FORCED ENTRY / HURRICANE RESISTANT (FEOP OR OP) UNLESS NOTED OTHERWISE.
- 34. PROVIDE MANUFACTURERS WARRANTED FACTORY APPLIED PAINT SYSTEM AT ALUMINUM STOREFRONT SYSTEMS: USE THE SAME MATCHING COLOR SYSTEM INCLUDING: ALUM STOREFRONT FRAMING SYSTEM, ALUM DOORS, ALUM SHEET METAL, ALUM PANNING AND ACCESSORIES, ETC. FACTORY FINISH INSULATED OPAQUE METAL PANELS COLOR TO MATCH. COLOR SELECTED BY ARCHITECT.
- 35. PROVIDE A SUBMITTAL OF DATA, DRAWINGS, CALCULATIONS, CERTIFIED AND SEALED BY A RHODE ISLAND LICENSED ENGINEER, STOREFRONT SYSTEM IS HURRICANE RESISTANT, RESISTANT TO LOCAL WEATHER, INCLUDE LOCATION AND TYPE FASTENERS REQUIRED FOR EACH SUBSTRATE, INCLUDE ENGINEERING OF ASSOCIATED NEW METAL STUD SYSTEM \$ ALUMINUM PANNING, INCLUDE NEW MATERIALS AND SYSTEMS INSIDE THE ROUGH OPENING SUPPORTING STOREFRONT SYSTEM, PER 084313-1.05.
- 36. PROVIDE AT EXISTING STEEL LINTELS, RUST RESISTANT PAINT SYSTEM PRIOR TO DOOR INSTALLATION. PROVIDE (I) COAT RUST INHIBITING ACRYLIC PRIMER EQUAL TO "PRO-INDUSTRIAL PRO-CRYL" NUMBER B66- I 300 AND (2) COATS RUST INHIBITING ACRYLIC FINISH EQUAL TO "PRO-INDUSTRIAL DTM ACRYLIC" NUMBER BG6-1 I 50 BY SHERWIN WILLIAMS, OR EQUAL, COLOR SELECTED BY ARCHITECT.
- 37. PROVIDE AT EXIST STRUCTURE / COLUMNS ADJACENT TO THE NEW WORK INTERIOR PAINT SYSTEM, AND WHERE NOTED IN CONTRACT DOCUMENTS.
- 38. PROVIDE SILICONE SEALANT SYSTEM EQUAL TO DOWSIL-795 BY DOW OR SPECTREM-2 BY TREMCO AT DOOR AND STOREFRONT SYSTEMS AND THEIR CONNECTIONS TO SURROUNDING MATERIALS. PROVIDE SEALANT & BACKER ROD SYSTEM, AS REQ'D, AND SEAL BOTTOM OF DOOR FRAMES AND STOREFRONT INCLUDING AT THE BOTTOM OF DOOR OPENINGS. PROVIDE SUBMITTAL AND COLOR SELECTOR. ENSURE SEALANTS AND BUILDING PRODUCTS ARE COMPATIBLE. COLOR SELECTED BY ARCHITECT.
- 39. PROVIDE FACTORY GALVANIZED EXTERIOR INSULATED DOORS AND FACTORY GALVANIZED FRAMES AND PROVIDE AN EXTERIOR PAINT SYSTEM. REPAIR AND PATCH GALVANIZING AFTER INSTALL.
- 40. PROVIDE, AT NEW AND EXISTING DOORS RECEIVING A NEW THRESHOLD, VINYL COMPOSITION TILE FLOORING MATCHING EXISTING, ONE FOOT (INCLUDING ONE FULL TILE) BY WIDTH OF NEW DOOR \$ FRAME, UNLESS NOTED OTHERWISE. VERIFY COLORS WITH ARCHITECT
- 41. EXISTING FLASHING ASSOCIATED WITH THE NEW WORK REPAIR AND PATCH, AS REQ'D, WITH LIKE MATERIALS. BEND BACK AT COMPLETION OF WORK.
- 42. VERIFY EXISTING CONDITIONS AND DIMENSIONS IN THE FIELD PRIOR TO SHOP DRAWINGS \$ FABRICATION. VERIFY IN FIELD ROUGH OPENING SIZE, SILL HEIGHT, EXISTING HEAD # JAMB # SILL CONFIGURATIONS, INTERIOR COLUMN AND WALL LOCATIONS AND ENSURE VERTICAL MULLIONS ARE IN ALIGNMENT WITH COLUMNS AND WALLS, UNLESS NOTED OTHERWISE. INCLUDE FIELD VERIFIED INFORMATION AND DIMENSIONS IN SHOP DRAWING SUBMISSION.
- 43. FASTENERS AND DISSIMILAR METALS: FASTENERS IN PRESSURE TREATED WOOD AND FIRE TREATED WOOD USED AT EXTERIOR ENVELOPE TO BE HOT DIPPED GALVANIZED OR STAINLESS STEEL. PRESSURE TREATED WOOD AND FIRE TREATED WOOD IN CONTACT WITH METAL TO BE COVERED BY A SELF ADHERING SEPARATING MEMBRANE. SEPARATE DISSIMILAR METALS AS REQUIRED TO PREVENT CORROSION. PROVIDE 14 MIL POLYPROPYLENE FILM/ SYNTHETIC BUTYL SELF ADHERING MEMBRANE (EQUAL TO HENRY BLUESKIN BUTYL FLASH). PROVIDE MATERIALS SUBMITTAL INCLUDED WITH DOOR SUBMITTAL. ENSURE ADHERED SEPARATING MEMBRANE MATERIALS AND SEALANTS AND OTHER RELATED MATERIALS ARE COMPATIBLE. DO NOT USE PRESSURE TREATED WOOD, PT WD SHIMS, ETC, AT EXTERIOR DOOR FRAMES AND STOREFRONT SYSTEMS

GENERAL DEMOLITION NOTES:

QUANTITIES & CONDITIONS IN THE FIELD.

THE CONTRACTOR SHALL PROVIDE AND COMPLY WITH THE FOLLOWING

- I. CONTRACTOR IS TO VERIFY ALL DIMENSIONS AND SITE CONDITIONS RELATIVE TO NEW WORK AND BE COMPLETELY FAMILIAR WITH EXISTING CONDITIONS RELATIVE TO THE WORK CALLED FOR ON THE DRAWINGS AND SPECIFICATIONS. NO COMPENSATION FOR EXTRA WORK ON BEHALF OF THE CONTRACTOR WILL BE CONSIDERED THAT WOULD HAVE BEEN DETERMINED BY VISUAL OBSERVATION PRIOR TO BIDDING.
- 2. AVOID DAMAGE TO SURROUNDING ARCHITECTURAL ELEMENTS AND SURFACES DURING THE DEMOLITION PHASE BY THE USE OF NECESSARY PROTECTIVE COVERINGS, PADDING, ETC. REPLACEMENT/REPAIR TO ANY ELEMENTS DAMAGED DURING DEMOLITION SHALL BE AT THE CONTRACTORS EXPENSE, AND ALL WORK SHALL BE PERFORMED TO THE SATISFACTION OF THE OWNER AND ARCHITECT.
- 3. PROVIDE DUST PARTITIONS, AS REQUIRED, DURING CONSTRUCTION, TO CONTROL DEBRIS REMOVAL, TO KEEP AREAS OUTSIDE OF THE WORK AREA FREE OF DIRT AND DUST. THE GENERAL CONTRACTOR WILL BE RESPONSIBLE FOR CLEANING ANY AREAS LEFT UNPROTECTED.
- 4. BE RESPONSIBLE TO CLEAN THE WORK AREA AT THE END OF EACH WORK DAY. TRASH AND DEBRIS TO BE REMOVED FROM THE BUILDING AND LEGALLY DISPOSED OF
- 5. CONFORM TO ALL FEDERAL, STATE, AND LOCAL REQUIREMENTS FOR THE SAFE AND LEGAL REMOVAL AND DISPOSAL OF MATERIALS.
- 6. UNDERSTAND THAT THE DIMENSIONS AND QUANTITIES ON THESE DRAWINGS OF THE EXISTING BUILDING AND EXISTING EQUIPMENT SHOWN ARE FOR GENERAL REFERENCE. VERIFY DIMENSIONS \$
- 7. REMOVE, ADJUST, MODIFY, CUT, ETC. EXISTING COMPONENTS AS REQUIRED TO INSTALL NEW, AND/OR RELOCATE EXISTING, FIRE ALARM, FIRE PROTECTION, POWER/SIGNAL, LIGHTING, ETC. AND TO PERFORM WORK. UNLESS NOTED OTHERWISE, VERIFY FINAL LOCATION IN FIELD.
- 8. GC IS RESPONSIBLE TO RECORD THE LOCATION OF EXISTING SYSTEMS FASTENED TO DOOR INCLUDING ELECTRICAL, FIRE ALARM, SECURITY, COORDINATE WITH OWNER PRIOR TO DEMOLITION. REINSTALL IN NEW WORK.
- 9. BE RESPONSIBLE FOR CUTTING, FILLING, PATCHING AND/ OR REPAIRING OF EXISTING WALLS, FLOORS AND CEILINGS AS REQUIRED FOR THE INSTALLATION OF NEW WORK IN THE EXISTING BUILDING.
- IO. THE GC IS RESPONSIBLE TO PATCH AND RE-FINISH ANY SURFACE WHERE EXISTING ITEMS OR DEVICES ARE REMOVED AS PART OF THE DEMOLITION WORK.
- II. COORDINATE MECHANICAL, ELECTRICAL, PLUMBING AND FIRE PROTECTION WORK WITH THE ARCHITECTURAL WORK PRIOR TO PROCEEDING WITH THE DEMOLITION WORK.
- 12. UNDERSTAND THAT THE TERM "REMOVE" AND "REMOVE AND DISPOSE" (R\$D) AS NOTED ON THESE DRAWINGS SHALL BE DEFINED AS THE REMOVAL AND DISPOSAL OF THE NOTED ELEMENT AS WELL AS ALL ITS RELATIVE COMPONENTS, FASTENERS, ETC. THE TERM "REMOVE AND PRESERVE" (R&P) REFERS TO ITEMS REMOVED TO PERFORM WORK AND TO BE REINSTALLED.
- 13. UNDERSTAND THAT DASHED LINES ON "DEMO" AND "DEMOLITION" DRAWINGS INDICATE ITEMS TO BE REMOVED AND DISPOSED, UNLESS NOTED OTHERWISE, TYP.
- 14. ASBESTOS: ASBESTOS HAS BEEN IDENTIFIED IN THE ELEMENTARY BUILDINGS, REFER TO THE ASBESTOS REPORT IN THE SPECIFICATIONS \$ SPEC SECTION 003 | 19. NOTIFY THE ARCHITECT IMMEDIATELY OF ANY ADDITIONAL ASBESTOS MATERIAL FOUND.
- 15. EXISTING FASTENERS SCHEDULED TO BE REMOVED, IN MASONRY AND CONCRETE, CUT FLUSH WITH THE SURFACE OR UNSCREW IN A MANNER TO PREVENT DAMAGE. DO NOT PULL OUT FASTENERS.
- 16. EXISTING EXTERIOR STEEL LINTELS IN AREAS OF WORK: REMOVE LOOSE PAINT \$ RUST BY SCRAPING, SANDING, AND WIRE BRUSH, PREP FOR NEW PAINT SYSTEM.
- 17. EXISTING STEEL STRUCTURE AND COLUMNS ADJACENT TO DOOR SYSTEMS, PREPARE FOR PAINT SYSTEM IN NEW WORK.
- 18. REMOVE AND DISPOSE EXISTING SEALANTS ADHERED TO THE MASONRY AT THE REMOVED DOOR SYSTEMS. DO NOT DAMAGE THE MASONRY.
- 19. PRIOR TO COMMENCING DEMOLITION, INCLUDING MASONRY, PROVIDE TEMPORARY SHORING, BRACING, AS REQUIRED, ADEQUATE TO KEEP BUILDING STATIC UNDER SUBJECTED LOADING AND SHALL REMAIN IN PLACE UNTIL NEW WORK INSTALLED.
- 20. REMOVE & DISPOSE DAMAGED MASONRY PREVENTING DOOR INSTALLATION, INCLUDING LOOSE & CRACKED # DAMAGED EXIST MASONRY, CUT OR CHISEL OUT DAMAGED MASONRY AND / OR MORTAR. PREP FOR NEW. REVIEW WITH ARCHITECT. REFER TO MASONRY WALL PATCHING AT GENERAL NOTES.
- 21. EXISTING FLASHING PREVENTING WORK PROGRESS BEND UP TO PERFORM WORK, BEND BACK IN NEW WORK.
- 22. REMOVE & DISPOSE EXISTING VINYL COMPOSITION TILE AND ADHESIVE AT DOORS RECEIVING A NEW THRESHOLD, PORTION OF A TILE AND ONE FULL TILE THE WIDTH OF THE DOOR AND FRAME, AS REQUIRED.
- 23. ALL DEMOLITION TO CONFORM TO THE REQUIREMENTS AND REPORTING REQUIREMENTS AS GOVERNED BY THE RHODE ISLAND DEPARTMENT OF EDUCATION (RIDE) AND THE LATEST VERSION OF NORTH-EAST CHPS
- 24. ALL EXISTING MATERIALS REMOVED SHALL BE RECYCLED TO THE GREATEST EXTENT POSSIBLE.

NOTES:

- . SEE DRAWING GI.O & GI.I FOR ADDITIONAL NOTES AND LEGENDS PERTAINING TO THE PROJECT.
- 2. SEE DWG 1 / A2.0-C FOR DOOR AND FRAME SCHEDULE & TYPES.
- 3. VERIFY EXISTING CONDITIONS IN FIELD. DO NOT DAMAGE OR CUT ANY STRUCTURAL ELEMENTS. IF CONDITIONS DIFFER TO WHAT IS SHOWN ON THESE DRAWINGS, NOTIFY ARCHITECT IMMEDIATELY PRIOR TO COMMENCING WORK.
- 4. COORDINATE REMOVAL & REINSTALL OF EXIST EQUIPMENT INCLUDING SECURITY, ELECTRICAL, AND FIRE ALARM. REVIEW SECURITY W/ OWNER PRIOR TO CONSTRUCTION.



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Consultant

EXTERIOR DOOR **UPGRADES**

Elementary Schoo 55 Glenwood Drive, Warwick, RI 02889

Robertson Elementary Schoo 70 Nausaket Road, Warwick, RI 02886

E.T.Wyman Elementary Schoo 1 Columbia Avenue, Warwick, RI 02888

Revision Schedule

Revision Date

Revision


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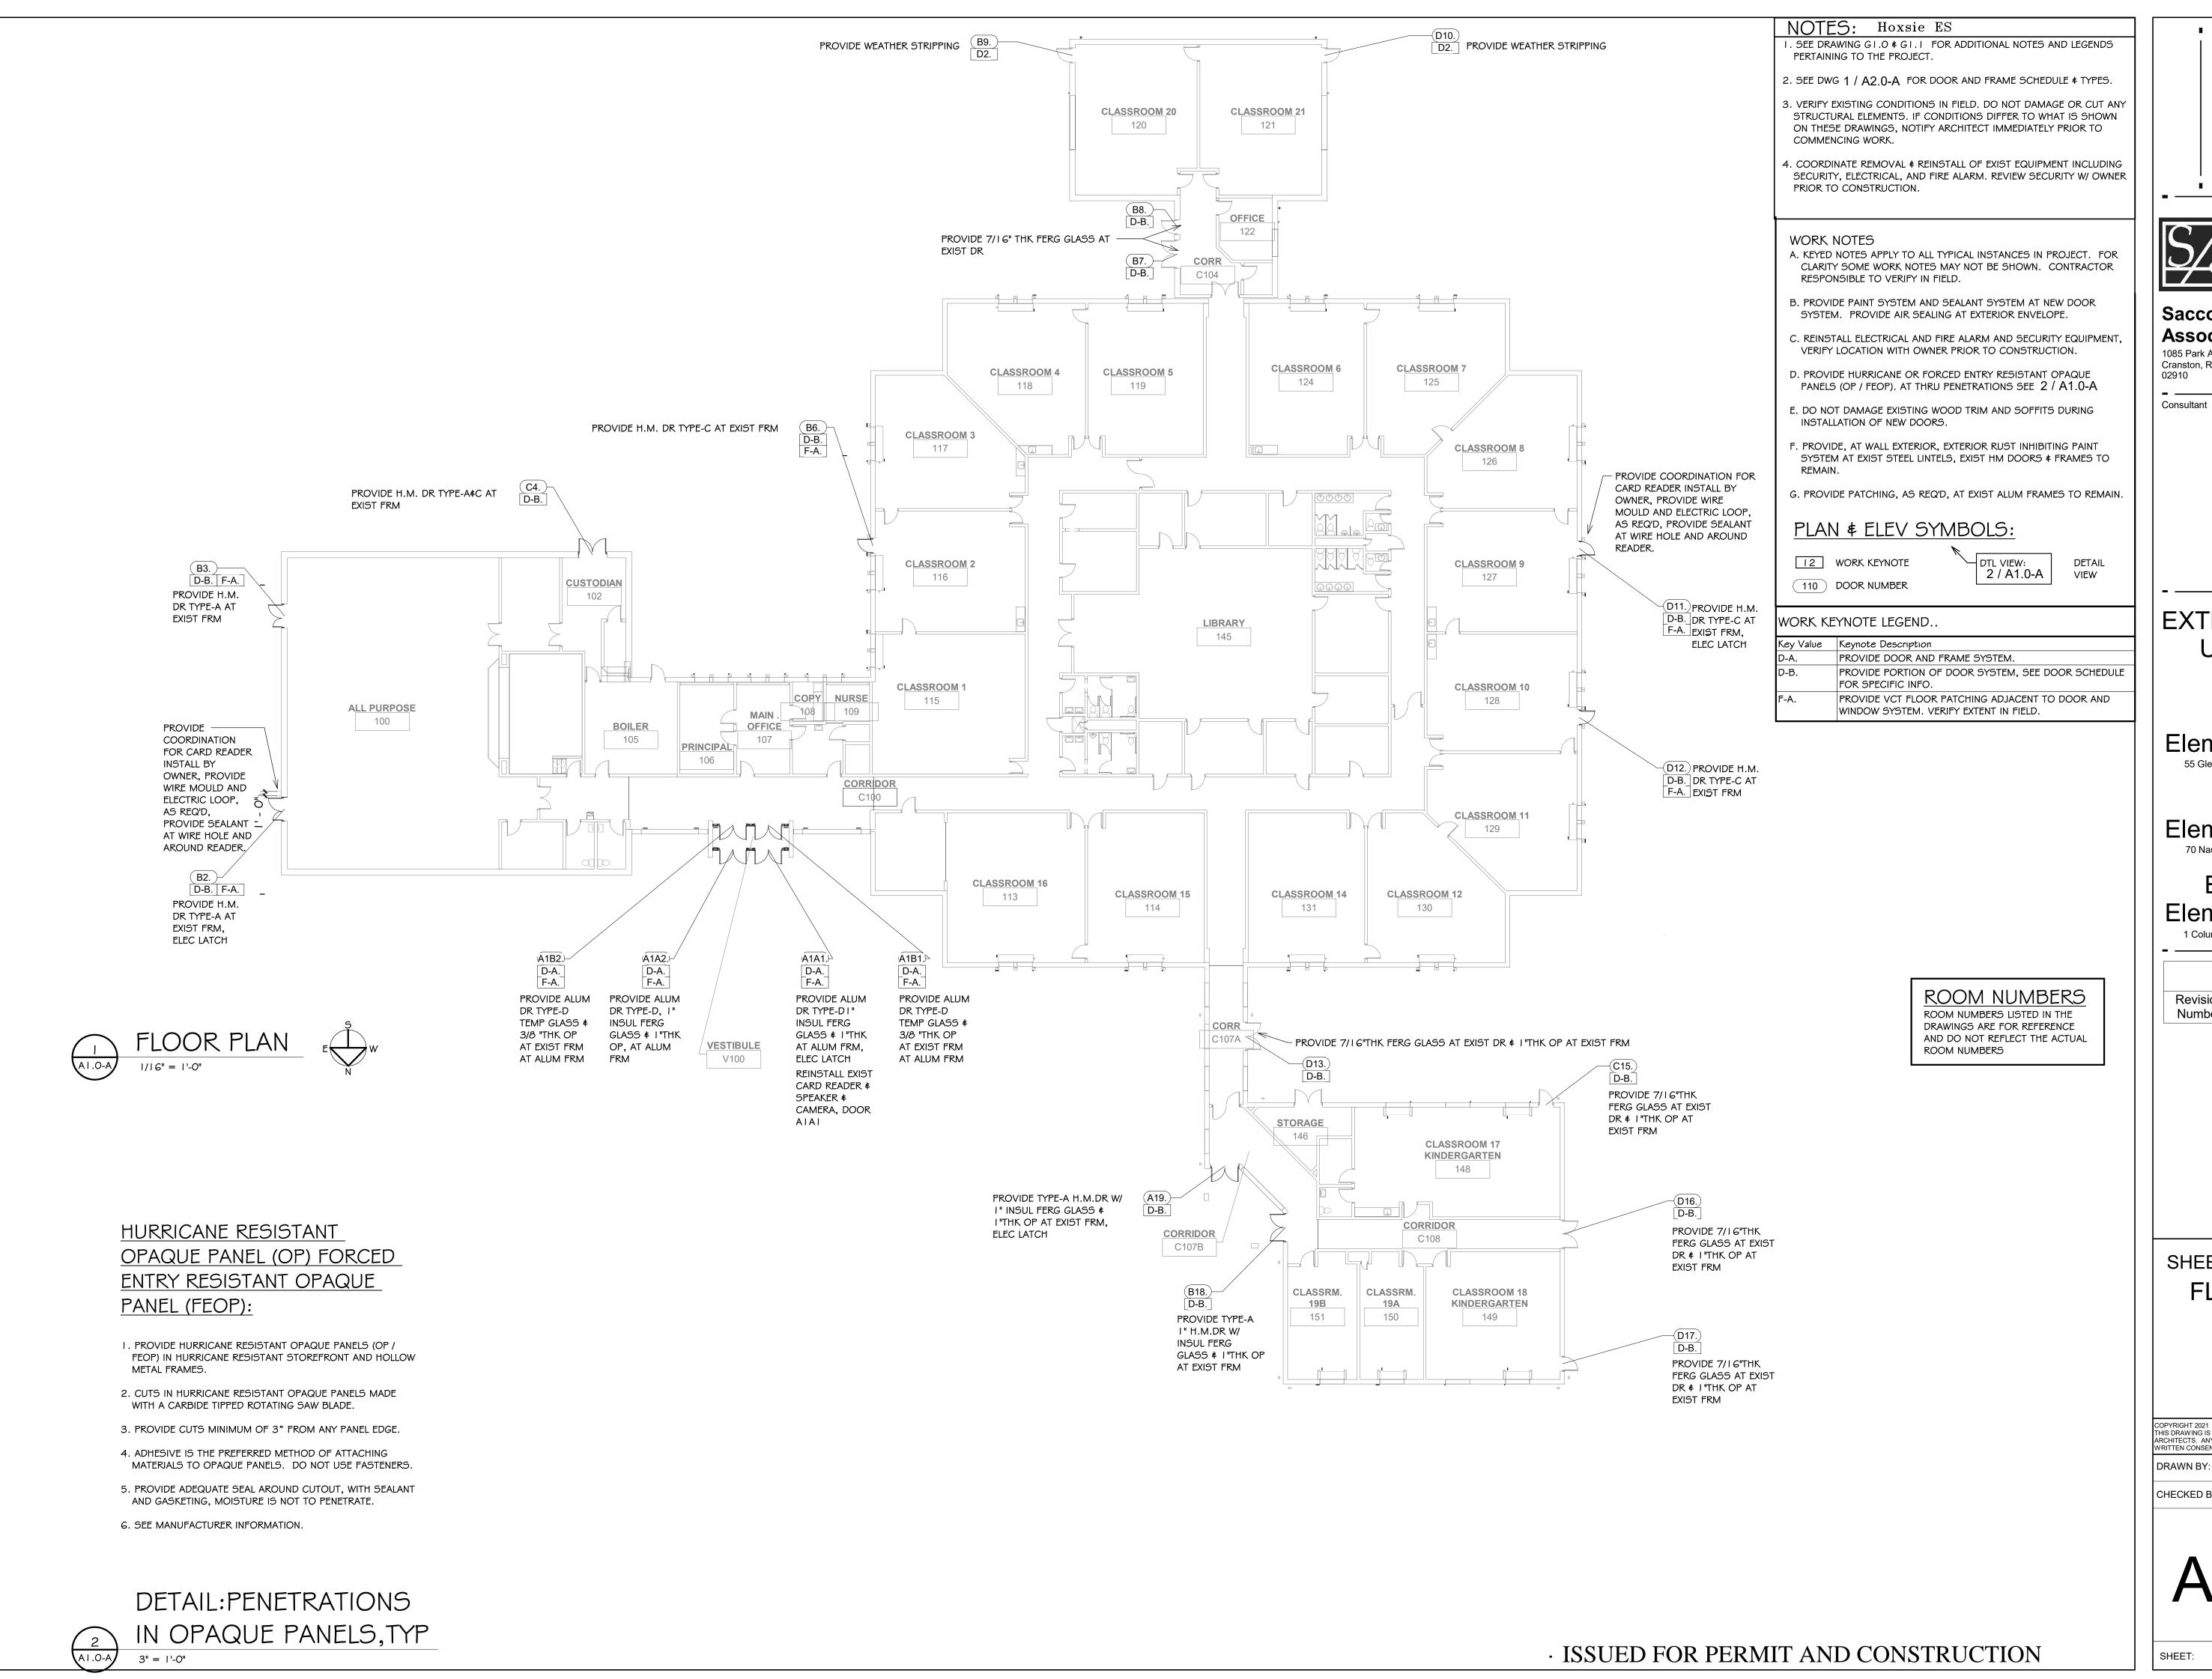
SHEET TITLE **GENERAL GENERAL DEMOLITION NOTES**

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SHEET: 2





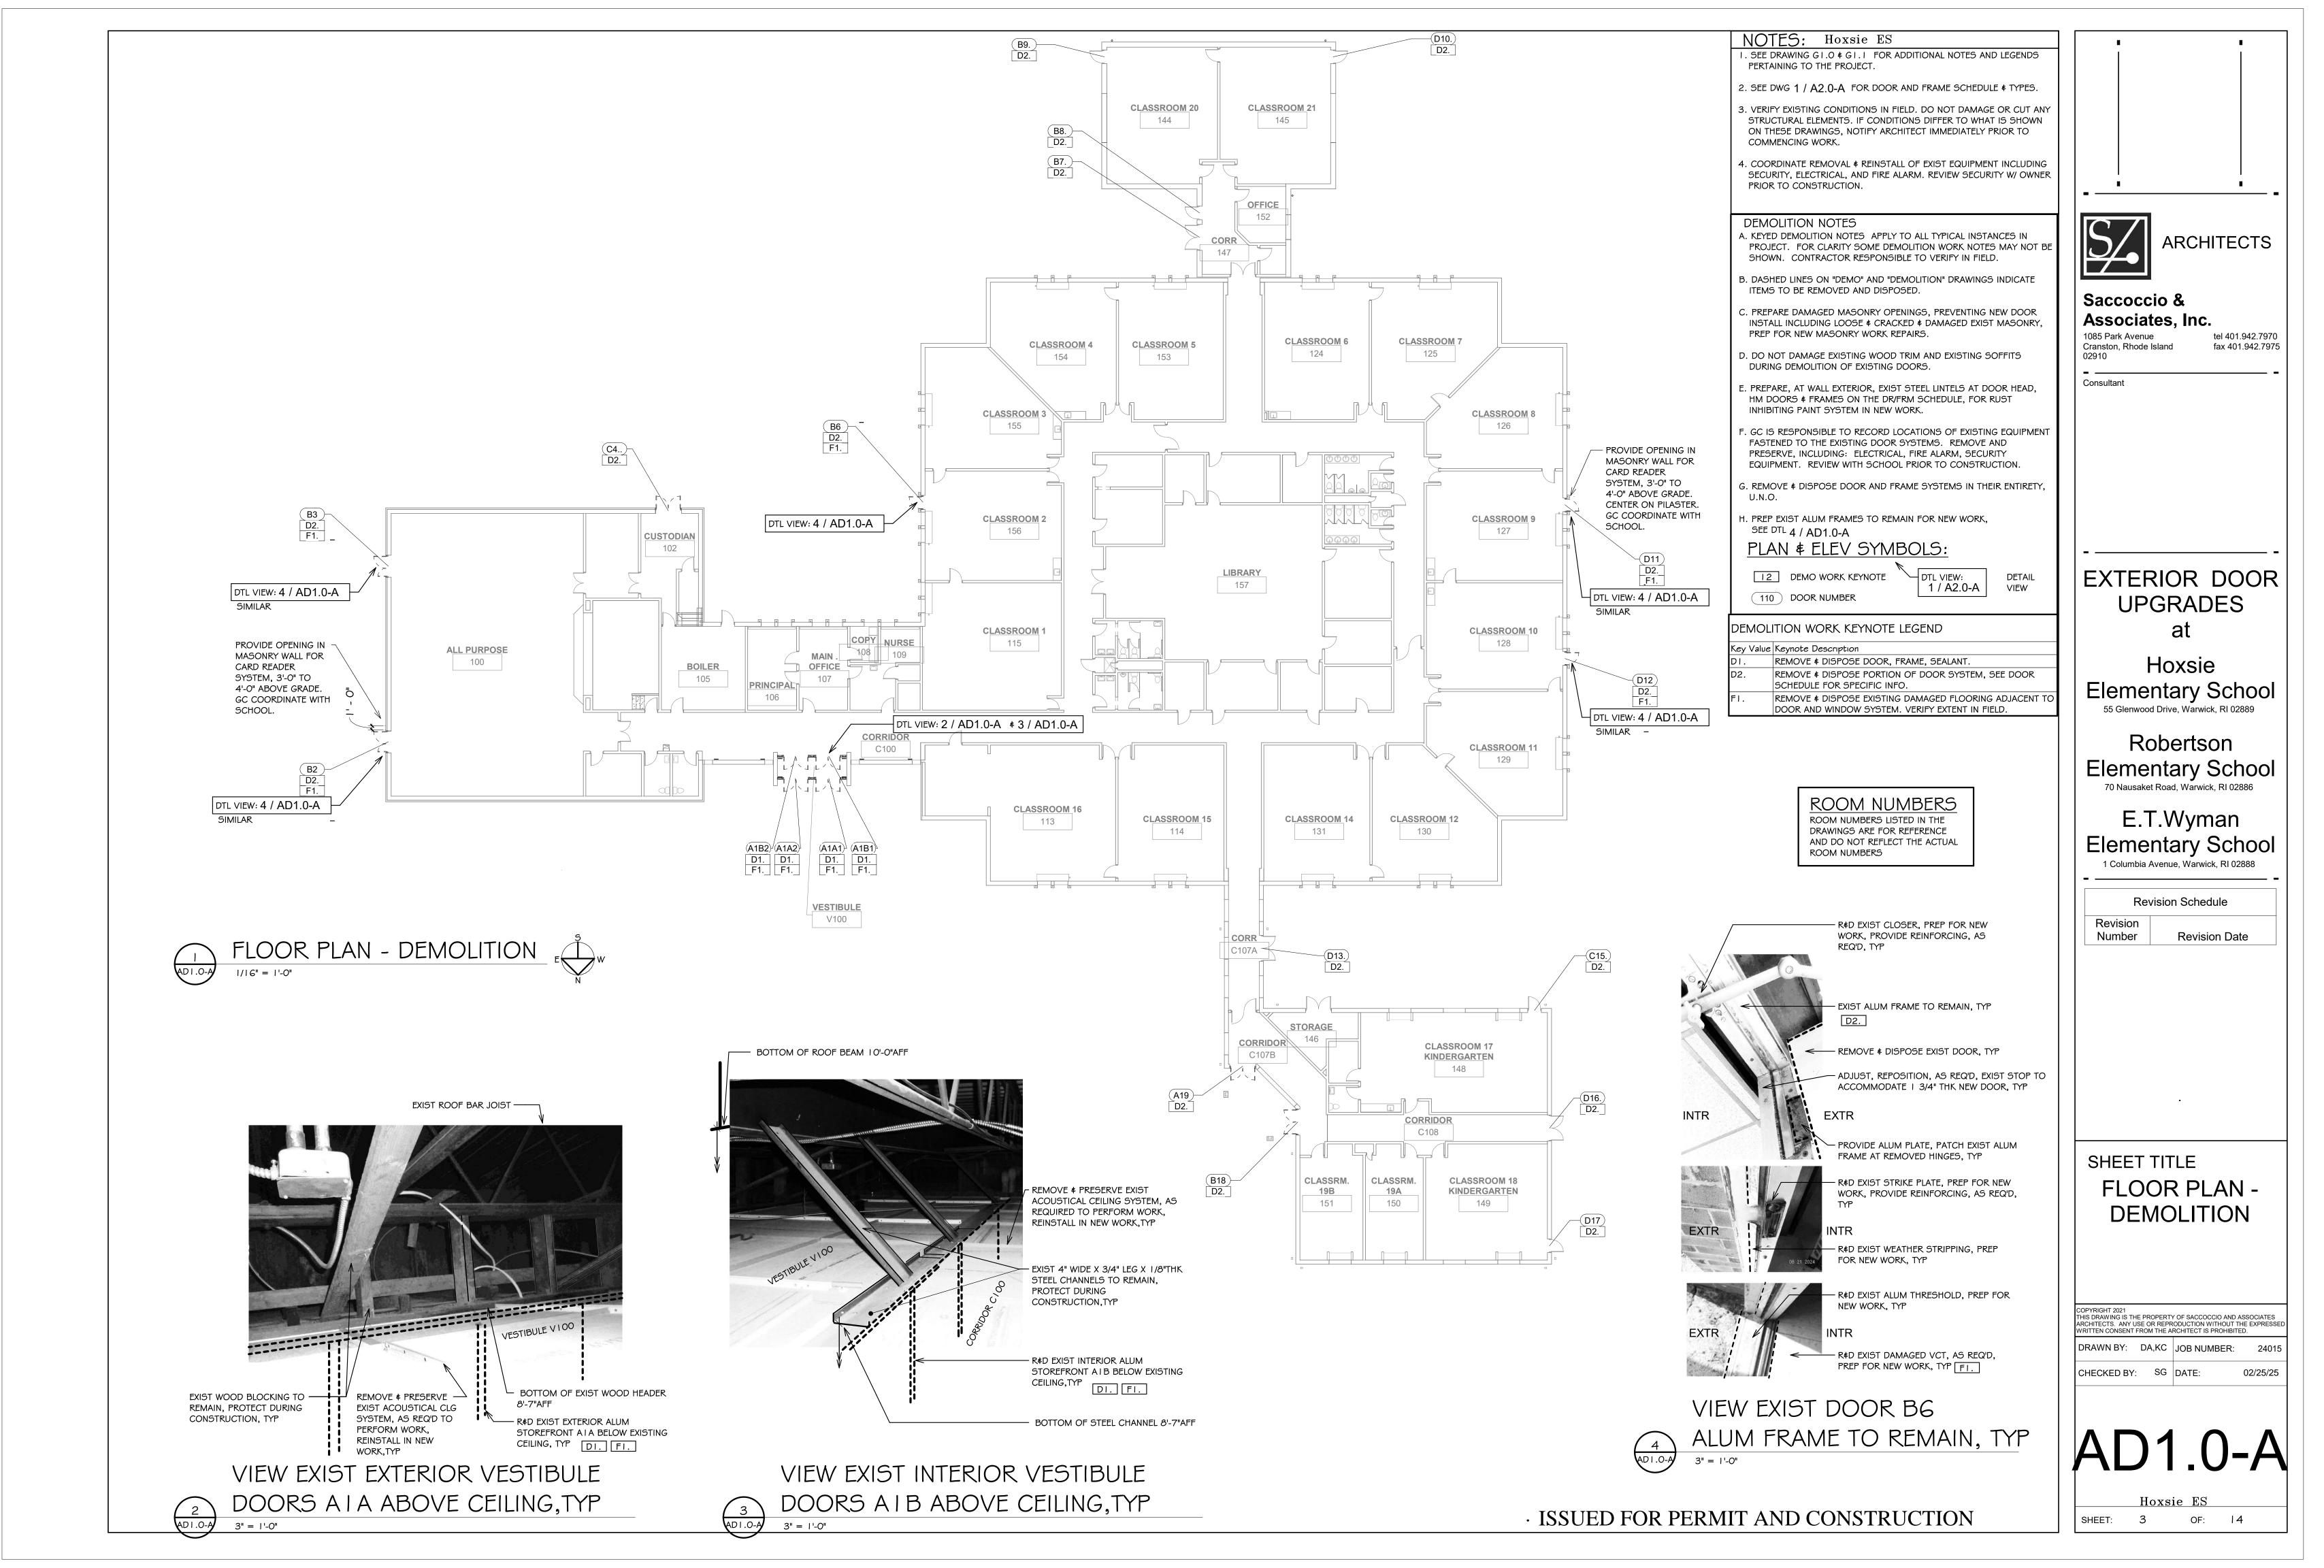

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EXTERIOR DOOR **UPGRADES**

Hoxsie **Elementary School** 55 Glenwood Drive, Warwick, RI 02889

Robertson **Elementary School** 70 Nausaket Road, Warwick, RI 02886

E.T.Wyman **Elementary School** 1 Columbia Avenue, Warwick, RI 02888

Revision Schedule

Revision Revision Date

SHEET TITLE FLOOR PLAN


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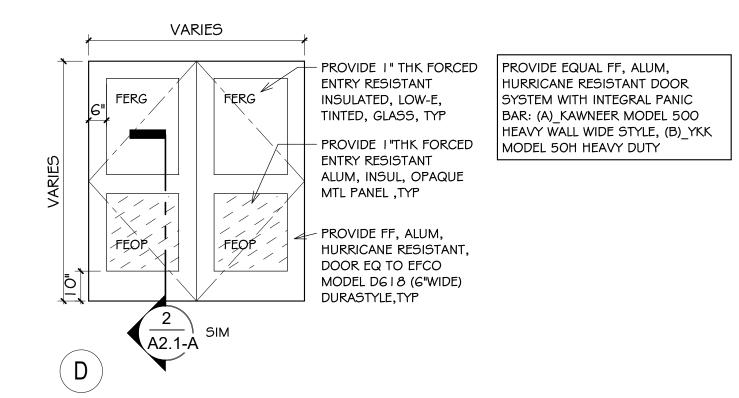
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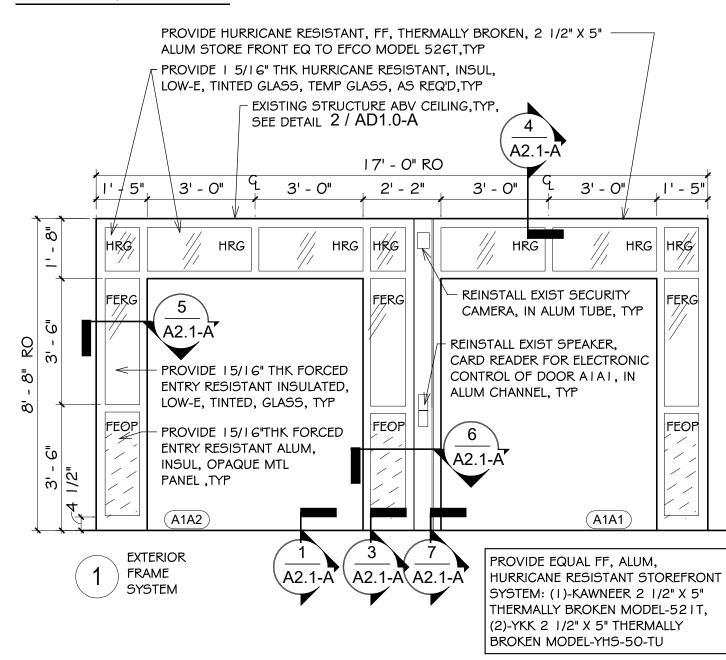
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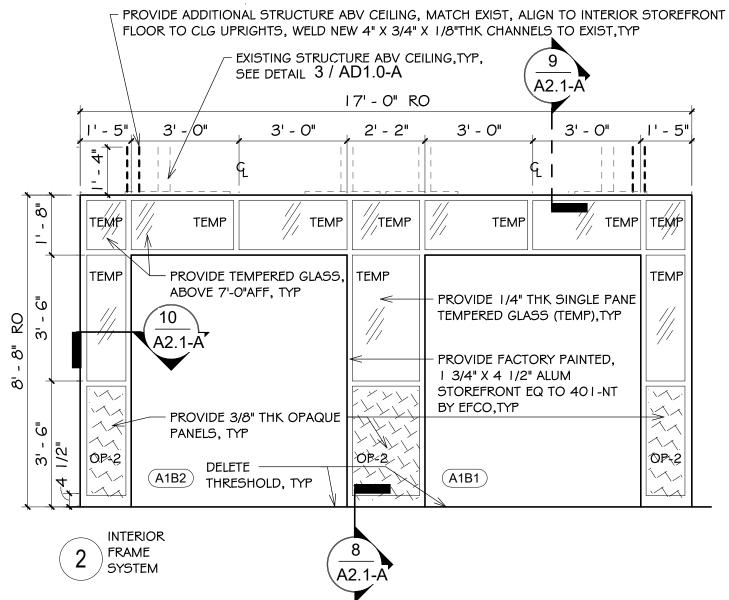
Hoxsie ES 4 OF: 14





DOOR TYPES



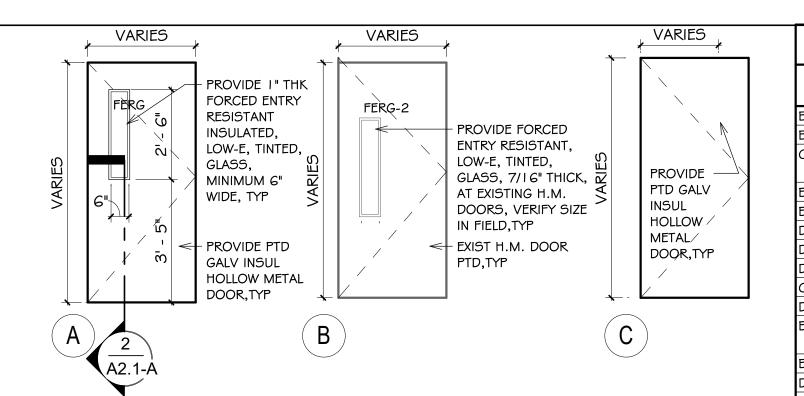

DOOR # FRAME TYPES

FRAME TYPES

3/8" = 1'-0"

A2.0-A


3 EXIST ALUM OR HM FRAME

EXTERIOR DOOR AND FRAME SCHEDULE

DR	RM						DR	DR	DR	DR	FRM			l	FRM					HRDWR	
NO	NO	ROOM NAME	WIDE	HIGH	TH	K	TYPE	MTL	FIN	GLASS	TYPE	FRAME SIZE	DEEP	MTL	FIN	GLASS	SILL DTL	JMB DTL	HD DTL	GRP	DOOR SCHDULE REMARKS
B2.	100	ALL PURPOSE	5' - 0"	7' - 0"	0' - 1 3	3/4"	Α	HMG	PTD	FERG	EXIST			ALUM	EXIST	N/A	N/A	N/A	N/A	3	2-UN-EQUAL PAIR, 3-ELEC LATCH, 5-NEW DR#HRDWR, 8-THRESHOLD, 9-PATCH FRM, 13-LEFT DR ACTIVE
ВЗ.	100	ALL PURPOSE	5' - 0"	7' - 0"	0' - 1 3	3/4"	Α	HMG	PTD	FERG	EXIST			ALUM	EXIST	N/A	N/A	N/A	N/A	1	2-UN-EQUAL PAIR, 5-NEW DR#HRDWR, 8-THRESHOLD, 9-PATCH FRM
C4.	102	CUSTODIAN	6' - 0"	7' - 0"	0' - 1 3	3/4"	A ¢ C	HMG	PTD	FERG	EXIST			ALUM	EXIST	N/A	N/A	N/A	N/A		I-EQ PAIR, 5-NEW DR#HRDWR, 8-THRESHOLD, 9-PATCH FRM, ACTIVE DOOR INCLUDES A
																				5	VISION LITE DOOR TYPE-A
B6.	116	CLASSROOM-2	3' - 0"	7' - 9"	0' - 1 3	3/4"	С	HMG	PTD	N/A	EXIST			ALUM	EXIST	N/A	N/A	N/A	N/A	4	5-NEW DR#HRDWR, 8-THRESHOLD, 9-PATCH FRM
В9.	120	CLASSROOM-20	3' - 0"	7' - 0"	0' - 1 3	3/4"	EXIST C	HMG	PTD	N/A	EXIST			HMG	PTD	N/A	N/A	N/A	N/A	N/A	4-WEATHER STRIPPING, 7-EXIST DR&FRM REMAIN
DIO.	121	CLASSROOM-21	3' - 0"	7' - 0"	0' - 1 3	3/4"	EXIST C	HMG	PTD	N/A	EXIST			HMG	PTD	N/A	N/A	N/A	N/A	N/A	4-WEATHER STRIPPING, 7-EXIST DR#FRM REMAIN
DII.	127	CLASSROOM-9	3' - 0"	7' - 9"	0' - 1 3	3/4"	С	HMG	PTD	N/A	EXIST			ALUM	EXIST	N/A	N/A	N/A	N/A	6	3-ELEC LATCH, 5-NEW DR#HRDWR, 8-THRESHOLD, 9-PATCH FRM
D12.	128	CLASSROOM-10	3' - 0"	7' - 9"	0' - 1 3	3/4"	С	HMG	PTD	N/A	EXIST			ALUM	EXIST	N/A	N/A	N/A	N/A	4	5-NEW DR#HRDWR, 8-THRESHOLD, 9-PATCH FRM
C15.	148	CLASSROOM-17	3' - 0"	7' - 0"	0' - 1 3	3/4"	EXIST B	HMG	PTD	FERG-2	EXIST 3			HMG	PTD	OP	N/A	N/A	N/A	N/A	4-WEATHER STRIPPING, 7-EXIST DR&FRM REMAIN, 10-FRM OP, 11-DR GLASS, ADJUST PANIC HARDWR
D17.	149	CLASSROOM-18	3' - 0"	7' - 0"	0' - 1 3	3/4"	EXIST B	HMG	PTD	FERG-2	EXIST 3			HMG	PTD	OP	N/A	N/A	N/A	N/A	4-WEATHER STRIPPING, 7-EXIST DR&FRM REMAIN, 10-FRM OP, 11-DR GLASS
B7.	C104	CORRIDOR	6' - 0"	7' - 0"	0' - 1 3	3/4"	EXIST A	HMG	PTD	FERG	EXIST			HMG	PTD	N/A	N/A	N/A	N/A		I-EQ PAIR, 4-WEATHER STRIP, 7-EXIST DR&FRM REMAIN, 8-THRESHOLD, I I-DR GLASS, EXIST ELEC LATCH
																				N/A	SYSTEM TO REMAIN
B8.	C104	CORRIDOR	3' - 0"	7' - 0"	0' - 1 3	3/4"	EXIST A	HMG	PTD	FERG	EXIST			HMG	PTD	N/A	N/A	N/A	N/A	N/A	4-WEATHER STRIP, 7-EXIST DR&FRM REMAIN, 8-THRESHOLD, I I-DR GLASS
D13.	CIO7A	CORRIDOR	6' - 0"	7' - 0"	0' - 1 3	3/4"	EXIST B	HMG	PTD	FERG-2	EXIST 3			HMG	PTD	OP	N/A	N/A	N/A	N/A	I-EQ PAIR, 4-WEATHER STRIPPING, 7-EXIST DR#FRM REMAIN, IO-FRM OP, II-DR GLASS
A19.	C107B	CORRIDOR	6' - 0"	7' - 0"	0' - 1 3	3/4"	Α	HMG	PTD	FERG	EXIST 3			ALUM	EXIST	OP	N/A	N/A	N/A		I-EQ PAIR, 3-ELEC LATCH, 5-NEW DR#HRDWR, 9-PATCH FRM, IO-FRM OP, EXIST THRESHOLD REMAIN,
																				7	I 4-RIGHT DR ACTIVE
B18.	C107B	CORRIDOR	6' - 0"	7' - 0"	0' - 1 3	3/4"	Α	HMG	PTD	FERG	EXIST 3			ALUM	EXIST	OP	N/A	N/A	N/A	2	I-EQ PAIR, 5-NEW DR#HRDWR, 9-PATCH FRM, IO-FRM OP, EXIST THRESHOLD REMAIN
D16.	C108	CORRIDOR	6' - 0"	7' - 0"	0' - 1 3	3/4"	EXIST B	HMG	PTD	FERG-2	EXIST 3			HMG	PTD	OP	N/A	N/A	N/A	N/A	I-EQ PAIR, 4-WEATHER STRIPPING, 7-EXIST DR#FRM REMAIN, IO-FRM OP, II-DR GLASS
AIAI.	V100	VESTIBULE	6' - 0"	7' - 0"	0' - 1 3	3/4"	D	ALUM	FF	FERG/OP	1	17'-0" X 8'-8"	5"	ALUM	FF	FERG/HRG/	OP REMARK-6	REMARK-6	REMARK-6	8	I-EQ PAIR, 3-ELEC LATCH, 6-SEE DR&FRM TYPES, I 2-LEFT DR ACTIVE
ATA2.	V100	VESTIBULE	6' - 0"	7' - 0"	0' - 1 3	3/4"	D	ALUM	FF	FERG/OP	1	17'-0" X 8'-8"	5"	ALUM	FF	FERG/HRG/	OP REMARK-6	REMARK-6	REMARK-6	8	I-EQ PAIR, G-SEE DR#FRM TYPES
AIBI.	V100	VESTIBULE	6' - 0"	7' - 0"	0' - 1 3	3/4"	D	ALUM	FF	OP-2/TEMP	2	17'-0" X 8'-8"	4 1/2"	ALUM	FF	OP-2/TEMI	P REMARK-6	REMARK-6	REMARK-6	N/A	I -EQ PAIR, G-SEE DR&FRM TYPES, DELETE THRESHOLD, DELETE WEATHER STRIPPING
AIB2.	V100	VESTIBULE	6' - 0"	7' - 0"	0' - 1 3	3/4"	D	ALUM	FF	OP-2/TEMP	2	17'-0" X 8'-8"	4 1/2"	ALUM	FF	OP-2/TEM	P REMARK-6	REMARK-6	REMARK-6	N/A	I-EQ PAIR, G-SEE DR&FRM TYPES, DELETE THRESHOLD, DELETE WEATHER STRIPPING

DOOR SCHEDULE GENERAL NOTES: PROVIDE AT EACH OPENING LISTED ON THE DOOR AND FRAME SCHEDULE:

- 1. SEE DRAWING G1.0 & G1.1 FOR ADDITIONAL NOTES AND LEGENDS PERTAINING TO THE PROJECT. SEE FRAME TYPES FOR DOOR/FRAME DETAILS AT 1 / A2.0-A
- 2. VERIFY EXISTING CONDITIONS AND DIMENSIONS IN THE FIELD PRIOR TO SHOP DRAWINGS & FABRICATION.
- 3. EXISTING DOORS ON THE DOOR/FRAME SCHEDULE, LEAVE DOOR IN PLACE UNLESS REQUIRED TO PERFORM WORK.
- 4. PROVIDE AT EXISTING STEEL LINTELS AND EXISTING H.M. DOORS \$ H.M. FRAMES LISTED ON THE DOOR/FRAME SCHEDULE, PREPARE AND PROVIDE A RUST RESISTANT PAINT SYSTEM PREPARATION TO INCLUDE LIGHT RUST REMOVAL WITH WIRE BRUSH AND SCRAPE. PROVIDE RUST INHIBITING PAINT SYSTEM INCLUDING (1) COAT RUST INHIBITING ACRYLIC PRIMER EQUAL TO "PRO-INDUSTRIAL PRO-CRYL" NUMBER BG6-1300 AND (2) COATS RUST INHIBITING ACRYLIC FINISH EQUAL TO "PRO-INDUSTRIAL DTM ACRYLIC" NUMBER BG6-1150, BY SHERWIN WILLIAMS, COLOR SELECTED BY ARCHITECT.
- 5. HOLLOW METAL DOORS AND HOLLOW METAL FRAMES, ON THE DOOR/FRAME SCHEDULE, TO BE GALVANIZED.
- 6. HOLLOW METAL DOORS, ON THE DOOR/FRAME SCHEDULE, TO BE INSULATED.
- 7. NEW AND EXISTING DOOR SYSTEMS ON THE DOOR/FRAME SCHEDULE, PROVIDE WEATHER STRIPPING, INSTALLED WITH STAINLESS STEEL SCREWS, SET IN BED OF SEALANT, INCLUDING DOOR BOTTOM RAIN DRIP W/ RUBBER GASKET EQUAL TO PEMKO 3452DPK. REMOVE \$ DISPOSE EXISTING WEATHER STRIPPING.
- 8. PROVIDE FORCED ENTRY AND / OR HURRICANE RESISTANT INSULATED OPAQUE METAL PANELS (FEOP / OP) I THICK AT ALUMINUM STOREFRONT DOORS, HM DOORS, HM FRAMES, I 5/16" THICK AT STOREFRONT FRAMING, EQUAL TO MAPESHIELD, BY MAPES, FACTORY FINISHED. INSTALL TO MEET CODE AND MEET MANUFACTURERS REQUIREMENTS. COLOR SELECTED BY ARCHITECT. REFER TO SIMILAR DETAIL AT 2 / A2.1-A
- 9. PROVIDE FORCED ENTRY RESISTANT GLASS (FERG) AND HURRICANE RESISTANT GLASS (HRG) PER DOOR / FRAME SCHEDULE AND DOOR / FRAME TYPES, I" THICK AT ALUMINUM STOREFRONT DOORS, HM DOORS, HM FRAMES, I 5/16" THICK AT STOREFRONT FRAMING, INSULATED, TEMPERED AS REQUIRED, MINIMUM WIDTH OF VISION LITES 6", GRAY TINT EQUAL TO GUARDIAN CRYSTAL GRAY COLOR OR VITRO OPTIGRAY COLOR, LOW-E (#2) EQUAL TO GUARDIAN 5N68 OR SOLARBAN 70 PROPERTIES, FERG INTER LAYER EQUAL TO SCHOOL GUARD GLASS SG5 OR OLD CASTLE ARMORPROTECT PLUS 121000, HRG INTER LAYER EQUAL TO 0.060 PVB OR SGP. COLORS SELECTED BY ARCHITECT. GLASS TO BE INSTALLED TO MEET CODE AND MANUFACTURERS REQUIREMENTS, SEE DETAIL 2 / A2.1-A
- 10. PROVIDE REPAIRS TO EXISTING FLASHING TO REMAIN. BEND UP EXIST FLASHING DURING DEMOLITION. IN NEW WORK PROVIDE PATCHING AND REPAIRS TO EXIST FLASHING WITH MATCHING MATERIALS, AS REQ'D, POP RIVET NEW TO OLD. BEND EXISTING FLASHING BACK DOWN AT END OF PROJECT.
- II. PROVIDE HURRICANE RESISTANT EXTERIOR STOREFRONT SYSTEM EQUAL TO 2 I/2" X 5" THERMALLY BROKEN MODEL 526T, DOOR SYSTEM MODEL D618 DURASTYLE BY EFCO. PROVIDE EQUAL EXTERIOR ALUMINUM STOREFRONT SYSTEMS: (1)-KAWNEER 2 1/2" X 5" THERMALLY BROKEN MODEL-521T, (2)-YKK 2 1/2" X 5" THERMALLY BROKEN MODEL-YHS-50-TU, EQUAL ALUMINUM DOOR SYSTEMS WITH INTEGRAL PANIC BAR: (A) KAWNEER MODEL -500 HEAVY WALL WIDE STYLE, (B) YKK MODEL -50H HEAVY DUTY. ALL PARTS OF SYSTEM FROM SAME COMPANY. COLOR SELECTED BY
- 12. REMOVE & DISPOSE EXIST VCT, AS REQ'D, TO INSTALL NEW WORK AND DAMAGED EXIST TILES ADJACENT TO DOOR, VERIFY IN FIELD. PROVIDE VINYL COMPOSITION TILE MATCHING EXISTING, INCLUDE PORTION OF A TILE AND ONE FULL TILE THE WIDTH OF THE DOOR OPENING.
- 13. PROVIDE ADA COMPLIANT THERMALLY BROKEN ALUM THRESHOLD AT NEW FRAMES AND WHERE NOTED ON THE DOOR/FRAME SCHEDULE, REMOVE \$ DISPOSE EXISTING ALUMINUM THRESHOLDS, ALUM RAMPS, CUT OR GRIND OR REMOVE EXISTING RUSTED STEEL ANGLES AT SILLS SUFFICIENT TO INSTALL NEW THRESHOLDS. SET IN BED OF SEALANT, PROVIDE SEALANT AT EXISTING TO REMAIN THRESHOLDS, PROVIDE AIR SEALING. SEE DETAIL 1 / A2 1-A
- 14. PROVIDE, AT HEAD, JAMB, SILL, SOLID SUBSTRATE FOR NEW DOOR SYSTEM FASTENING. FILL HOLES AND CRACKS AND RE-FORM WITH REPAIR CONCRETE INCLUDING (A) SIKAQUICK VOH AND SIKADUR-32 HI-MOD (B) ARDEX TWP AND ARDEX EP 2000 (C) ABATRON ABOWELD 55-1 AND ABATRON PRIMKOTE 8006-1. CONCRETE MASONRY WALL REPAIR BASIS OF DESIGN "TEK 08-01A: MAINTENANCE OF CONCRETE MASONRY WALLS" BY NATIONAL CONCRETE MASONRY ASSOCIATION (NCMA.ORG), BRICK MASONRY WALL REPAIR BASIS OF DESIGN "TECHNICAL NOTE 46: MAINTENANCE OF BRICK MASONRY" # "TECHNICAL NOTE 7: WATER PENETRATION RESISTANCE - DESIGN AND DETAILING" BY BRICK INDUSTRY ASSOCIATION (WWW.GOBRICK.COM).
- 15. PROVIDE AIR AND WATER SEALING AT EXTERIOR ENVELOPE, INSULATION FILL AT SHIM SPACES OF LOW PRESSURE FOAM EQ TO DOW GREAT STUFF PRO WINDOW # DOOR, SEALANT SYSTEM AT FRAME TO MASONRY AND THRESHOLD TO SILL, SILICONE SEALANT & BACKER ROD EQ TO DOWSIL-795 OR SPECTRUM-2. COLORS SELECTED BY ARCHITECT.
- 16. PROVIDE WIRE MOULD SYSTEM, AS REQUIRED, AT DOOR ELECTRIC LATCH LOCATIONS. PROVIDE ELECTRIC ARMORED LOOP BETWEEN FRAME AND DOOR, AS REQUIRED. MOUNT CARD READER 3'-O" TO 4'-O" ABOVE GRADE. SCHOOL TO PROVIDE AND INSTALL CARD READER AND FINAL ELECTRIC CONNECTIONS. GC COORDINATE WITH SCHOOL PRIOR TO CONSTRUCTION.
- 17. PROVIDE RI LICENSED ENGINEERING SUBMITTAL OF STOREFRONT SYSTEM, METAL STUD SYSTEM, AND REQUIRED ANCHORING SYSTEMS INCLUDING: A)_ENGINEERING OF STOREFRONT SYSTEM, METAL STUD SYSTEM, AND ANCHORING SYSTEMS, ARE HURRICANE RESISTANT AND MEET CODE, B) SPECIFY TYPE AND LOCATION OF ANCHORING PER SUBSTRATE, C) PROVIDE SUBMITTAL OF DATA, CALCULATIONS, DRAWINGS, DOCUMENTING SYSTEMS AND COMPONENTS INSIDE THE ROUGH OPENING ARE HURRICANE RESISTANT AND MEET CODE.
- 18. PROVIDE, AT EXIST ALUMINUM DOOR FRAMES TO REMAIN, REPAIRS INCLUDING ALUMINUM PLATE SCREWED IN AT REMOVED BUTT HINGES, REPOSITION EXISTING ALUM DOOR STOP, OR PROVIDE NEW, TO ACCOMMODATE NEW 1 3/4" THICK DOOR. REPOSITION NEW LATCH PLATES AS REQ'D. PROVIDE, AS REQ'D, REINFORCING. SEE DETAIL 4 / AD1.0-A
- 19. PROVIDE, AT EXTERIOR ENVELOPE, PRESSURE TREATED WOOD TREATED WITH MICRONIZED COPPER AZOLE (MCA) OR EQUAL AS NOTED IN THE ICC-ES REPORT "ESR-1721" LATEST VERSION. WOOD TREATMENT SYSTEM TO BE COMPLIANT WITH BUILDING CODE AND RIDE REQUIREMENTS. SEPARATE TREATED WOOD FROM METAL WITH SELF ADHERING MEMBRANE, EQUAL TO HENRY "BLUESKIN BUTYL FLASH" COMPATIBLE WITH PROJECT MATERIALS. DO NOT USE PT WOOD AT THE EXTERIOR ENVELOPE.
- 20. PROVIDE INTERIOR STOREFRONT FRAME SYSTEM TO BE EQUAL TO | 3/4" X 4 | 1/2" EQUAL TO 40 | (NT) BY EFCO. COLOR SELECTED BY ARCHITECT
- 21. PROVIDE 3/8" THICK OPAQUE PANEL (OP-2) AT VESTIBULE VIOO INTERIOR FRAME AIBI # AIB2 EQUAL TO "VENEER / GLAZE" PANEL BY MAPES WITH INTERIOR AND EXTERIOR .032" THICK FACTORY FINISH ALUMINUM SHEETS LAMINATED TO 3/16"THK MDF, COLOR SELECTED BY ARCHITECT.
- 22. PROVIDE GRAY TINTED FORCED ENTRY RESISTANT GLASS (FERG-2) AT EXISTING HM DOORS AND HM FRAMES EQUAL TO 7/16" THK LAMINATED GLASS BY SCHOOL GUARD GLASS NUMBER SGG-L7-SG5-GRAY2X.
- 23. ASBESTOS HAS BEEN IDENTIFIED IIN THE SCHOOL, REFER TO THE ASBESTOS REPORT IN THE SPECIFICATIONS SECTION 003 I 19. NOTIFY THE ARCHITECT IMMEDIATELY OF ANY ADDITIONAL ASBESTOS FOUND.

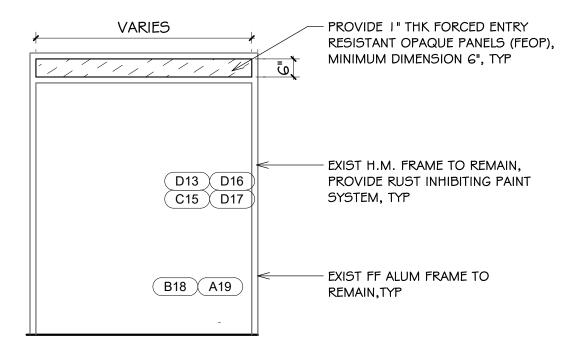

DOOR SCHEDULE REMARKS:

I. PROVIDE EQUAL PAIR OF DOORS.

2. PROVIDE UN-EQUAL PAIR OF DOORS. 3-0" DOOR TO BE THE ACTIVE DOOR.

- 3. PROVIDE ELECTRONIC LATCH SYSTEM. AS REQUIRED PROVIDE WIRE MOULD AND/OR ELEC ARMORED LOOP BETWEEN FRAME AND DOOR.
- 4. PROVIDE AT EXIST DOORS WEATHER STRIPPING WITH SURFACE APPLIED DOOR BOTTOM RAIN DRIP WITH RUBBER GASKET EQ TO PEMKO MODEL 3452-DPK.
- 5. PROVIDE DOOR AND HARDWARE AT EXISTING FRAME.
- 6. REFER TO DOOR AND FRAME TYPES FOR DETAILS AT 1 / A2.0-A
- 7. EXISTING DOOR AND FRAME TO REMAIN.
- 8. PROVIDE THRESHOLD, SEE DETAIL 1/A2.1-A
- 9. PROVIDE FRAME PATCHING AT EXIST ALUM FRAME, INFILL AT REMOVE EXISTING HINGES WITH ALUMIMUM PLATE, REPOSITION DOOR STOP, OR PROVIDE NEW, FOR NEW | 3/4" THK DOORS, LOCATE NEW LATCH PLATE, WEATHER SEAL, REINFORCE, AS REQ'D. SEE DTL 4 / AD1.0-A
- 10. PROVIDE REPLACEMENT AT EXIST HM FRAME AT TRANSOM LITE WITH 1" THK HURRICANE RESISTANT OPAQUE PANEL.
- II. PROVIDE REPLACEMENT AT EXIST HM DOOR VISION LITE WITH 7/I6" THK FERG-2 FORCED ENTRY RESISTANT GLASS AT EXISTING DOOR VISION LITE.
- 12. DOOR-ATAT PROVIDE ELECTRIC TWO POINT LATCH SYSTEM PANIC BAR, LEFT DOOR VIEWED FROM EXTERIOR. PROVIDE EXTERIOR PULL AT BOTH DOORS. PROVIDE OPENING FOR WIRING IN ALUM CHANNEL, AIR SEAL. PROVIDE WIRE MOULD, AS REQ'D, CONNECT TO EXISTING WIRING.
- 13. DOOR B2 PROVIDE ELECTRIC TWO POINT LATCH SYSTEM PANIC BAR, LEFT DOOR VIEWED FROM EXTERIOR. PROVIDE PULL AT EXTERIOR. PROVIDE WIRE MOULD AND OR ARMORED LOOP. AS REQ'D.
- 14. DOOR A 19 PROVIDE ELECTRIC TWO POINT LATCH SYSTEM PANIC BAR, RIGHT DOOR VIEWED FROM EXTERIOR. PROVIDE EXTERIOR PULL AT BOTH DOORS. PROVIDE WIRE MOULD AND OR ARMORED LOOP, AS REQ'D, CONNECT TO EXISTING WIRING

ABBREVIATION INSUL = INSULATION MIN = MINIMUMALUM = ALUMINUM MTL = METALCLR = CLEARN/A = NOT APPLICABLE DTL = DETAILNO = NUMBERDR = DOOROP = HURRICANE RESISTANT EX = EXISTINGEXIST = EXISTINGFEOP = FORCED ENTRY OPAQUE PANEL PTD = PAINTEDFERG = FORCED ENTRY RESISTANT GLASS REQ'D = REQUIREDFIN = FINISH RM = ROOMFF = FACTORY FINISH SIM = SIMILARFRM = FRAMESTL = STEEL

GALV = GALVANIZEDTHK = THICKGRP = GROUPTYP = TYPICALJMB = JAMBVIF = VERIFY IN FIELD HD = HEADHMG = HOLLOW METAL GALVANIZED HORIZ = HORIZONTAL HRDWR = HARDWARE HER = HURRICANE RESISTANT GLASS

NOTES: Hoxsie ES

OPAQUE PANEL

- . SEE DRAWING GI.O & GI.I FOR ADDITIONAL NOTES AND LEGENDS PERTAINING TO THE PROJECT.
- 2. SEE DWG 1 / A2.0-A FOR DOOR AND FRAME SCHEDULE \$ TYPES.
- 3. VERIFY EXISTING CONDITIONS IN FIELD. DO NOT DAMAGE OR CUT ANY STRUCTURAL ELEMENTS. IF CONDITIONS DIFFER TO WHAT IS SHOWN ON THESE DRAWINGS, NOTIFY ARCHITECT IMMEDIATELY PRIOR TO COMMENCING WORK.
- . COORDINATE REMOVAL & REINSTALL OF EXIST EQUIPMENT INCLUDING SECURITY, ELECTRICAL, AND FIRE ALARM. REVIEW SECURITY W/ OWNER PRIOR TO CONSTRUCTION.



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EXTERIOR DOOR **UPGRADES**

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Robertson **Elementary School** 70 Nausaket Road, Warwick, RI 02886

E.T.Wyman **Elementary School** 1 Columbia Avenue, Warwick, RI 02888

Revision Schedule


Revision Number Revision Date

SHEET TITLE **DOOR & FRAME** SCHEDULE, DOOR TYPES FRAME TYPES


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DRAWN BY: DA,KC JOB NUMBER: CHECKED BY: SG DATE: 02/25/25

Hoxsie ES 5 OF: 14

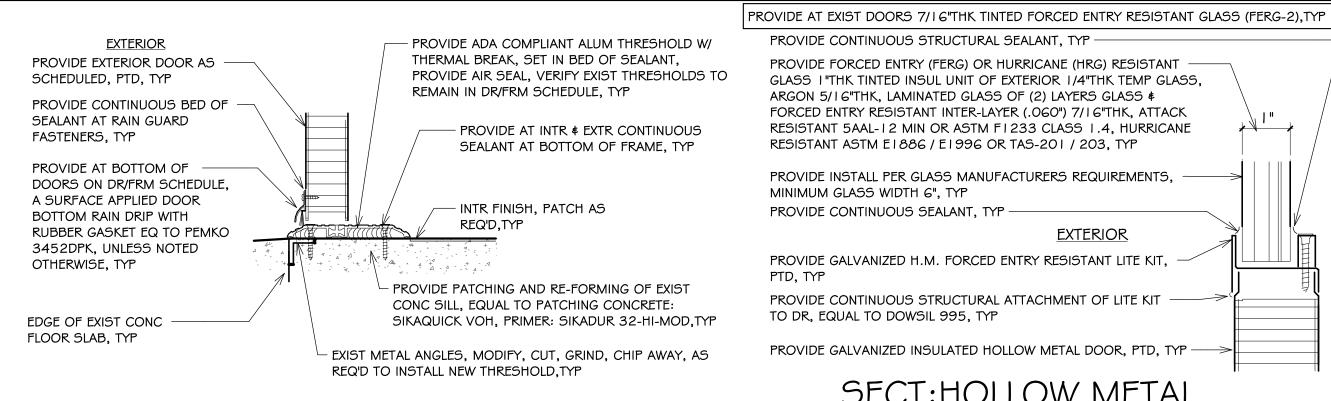

SECTION: DR THRESHOLDS, TYP

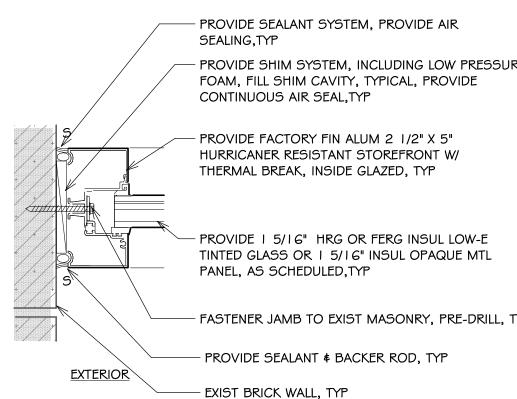

EFCO. PROVIDE EQUAL EXTERIOR ALUMINUM STOREFRONT SYSTEMS: (1)-KAWNEER 2 1/2" X 5" THERMALLY BROKEN MODEL-52 IT, (2)-YKK 2 1/2" X 5" THERMALLY BROKEN MODEL-YHS-50-TU, EQUAL ALUMINUM DOOR SYSTEMS WITH INTEGRAL PANIC BAR: (A) KAWNEER MODEL -500 HEAVY WALL WIDE STYLE, (B) YKK MODEL -50H HEAVY DUTY. ALL PARTS OF SYSTEM FROM SAME COMPANY. COLOR SELECTED BY ARCHITECT.

PROVIDE HURRICANE RESISTANT EXTERIOR


X 5" THERMALLY BROKEN MODEL 526T BY

STOREFRONT FRAME SYSTEMS EQUAL TO 2 1/2

 $\begin{pmatrix} 2 \\ A2.1-A \end{pmatrix}$

PROVIDE A SUBMITTAL OF DATA, DRAWINGS, CALCULATIONS, CERTIFIED AND SEALED BY A RHODE ISLAND LICENSED ENGINEER, STOREFRONT SYSTEM IS HURRICANE RESISTANT, RESISTANT TO LOCAL WEATHER, INCLUDE LOCATION AND TYPE FASTENERS REQUIRED FOR EACH SUBSTRATE, INCLUDE ENGINEERING OF ASSOCIATED NEW METAL STUD SYSTEM & ALUMINUM PANNING INCLUDING NEW MATERIALS AND SYSTEMS INSIDE THE ROUGH OPENING SUPPORTING STOREFRONT SYSTEM, PER 084313-1.05.

PROVIDE | 5/16" INSUL LOW-E TINTED GLASS OR | 5/16" INSUL OPAQUE MTL **EXTERIOR** PANEL, AS SCHEDULED, TYP PROVIDE FACTORY FIN ALUM 2 1/2" X 5" HURRICANER RESISTANT STOREFRONT W/ THERMAL BREAK, OUTSIDE GLAZED, TYP PROVIDE CONT AIR SEAL AT SUB-SILL, INTR FINISH, PATCH AS ENSURE WEEPS ARE CLEAR OF REQ'D,TYP DEBRIS, TYP PROVIDE PATCHING OF EXIST CONG SILL, EDGE OF EXIST CONC FLOOR EQUAL TO PATCHING CONCRETE: SIKAQUIČK SLAB, TYP

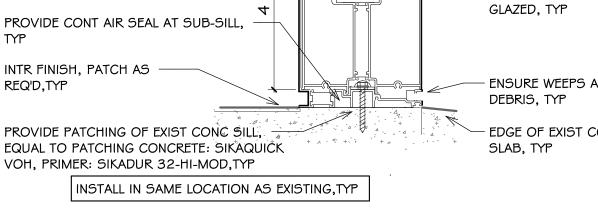

SECT: FRAME-A I A SILL, TYP

- PROVIDE REMOVABLE 3/4" THK INSUL OPAQUE METAL PANEL W/ .032 THK

- PROVIDE LOW PRESSURE FOAM I" THK AT EXTR WALL OF CHANNEL, AROUND

BOXES & CONDUIT FOR POWER & FOR DATA, FILL SHIM CAVITY, EQ TO "DOW

ANCHORS, TYP

PROVIDE 14GA 3 5/8" X 1 5/8" MTL STUD

(EQ TO 3625162-68-P) \$ TRACK W/ HEAD

DIETRICK EASY-CLIP #T683-12GA, DO NOT

USE P.T. BLKG AT EXTERIOR TO SUPPORT

\$ SILL ANCHOR CLIP EQUAL TO CLARK-

STOREFRONT SYSTEM, PRE-DRILL

ALUM & CEMENT BD SUBSTRATE, EQ TO MAPES-R, COLOR SELECTED BY

GREAT STUFF PRO WINDOW & DOOR", PROVIDE AIR SEAL, TYP

· PROVIDE COORDINATION OF CARD READER \$ SPEAKER SYSTEM.

MOUNTED 3'-0" TO 4'-0" AFF, & CAMERA, BY OWNER, PROVIDE

SEALANT SYSTEM AT PERIMETER, TYP

- PROVIDE SEALANT & BACKER ROD, TYP


ARCHITECT, TYP

\A2.1-A


 $\begin{pmatrix} 3 \\ A2.1-A \end{pmatrix}$


1'-3".


PROVIDE A SUBMITTAL OF DATA, DRAWINGS, CALCULATIONS, CERTIFIED AND SEALED BY A RHODE ISLAND LICENSED ENGINEER, STOREFRONT SYSTEM IS HURRICANE RESISTANT, RESISTANT TO LOCAL WEATHER, INCLUDE LOCATION AND TYPE FASTENERS REQUIRED FOR EACH SUBSTRATE, INCLUDE ENGINEERING OF ASSOCIATED NEW METAL STUD SYSTEM & ALUMINUM PANNING SUPPORTING STOREFRONT SYSTEM, PER 084313-1.05.

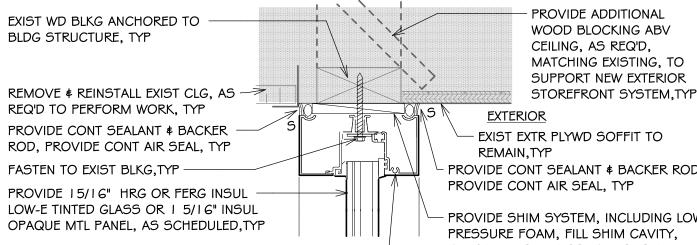

- EXIST EXTR PLYWD SOFFIT TO PROVIDE CONT SEALANT & BACKER ROD, PROVIDE SHIM SYSTEM, INCLUDING LOW PRESSURE FOAM, FILL SHIM CAVITY, TYPICAL, PROVIDE CONTINUOUS AIR PROVIDE FACTORY FIN ALUM 2 1/2" X 5" HURRICANER SEAL, TYP RESISTANT STOREFRONT W/ THERMAL BREAK, INSIDE GLAZED, TYP

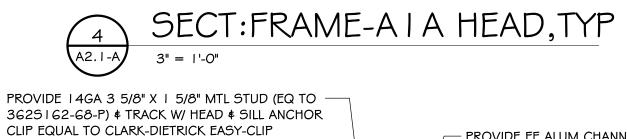

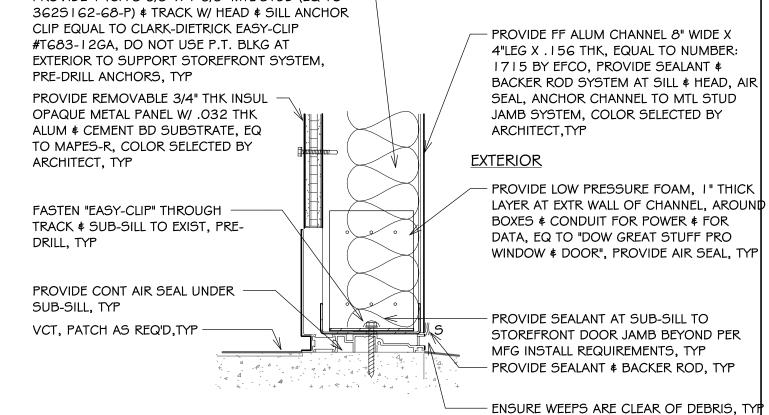

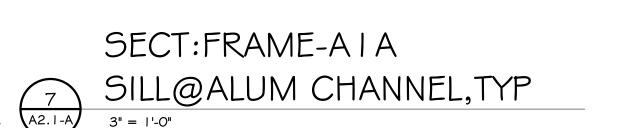

SECT:FRAME-AIA JAMB@ALUM TUBE,TYP

PROVIDE SHIM SYSTEM, INCLUDING LOW PRESSURE

HURRICANER RESISTANT STOREFRONT W/ THERMAL

PROVIDE SEALANT SYSTEM, PROVIDE AIR SEALING, TYP -

JAMB SYSTEM, COLOR SELECTED BY ARCHITECT, TYP

NUMBER: 1715 BY EFCO, PROVIDE SEALANT & BACKER ROD

PROVIDE FF ALUM CHANNEL 8" WIDE X 4"LEG X . I 56 THK, EQUAL TO -

SYSTEM AT SILL \$ HEAD, AIR SEAL, ANCHOR CHANNEL TO MTL STUD

FOAM, FILL SHIM CAVITY, TYPICAL, PROVIDE

PROVIDE FACTORY FIN ALUM 2 1/2" X 5" —

CONTINUOUS AIR SEAL, TYP

BREAK, INSIDE GLAZED, TYP

PROVIDE | 5/16" THK INSUL


MAPESHIELD, TYP


OPAQUE MTL PANEL, EQUAL TO


EXTERIOR

SECT:HOLLOW METAL

DOOR LITE TRIM, TYP

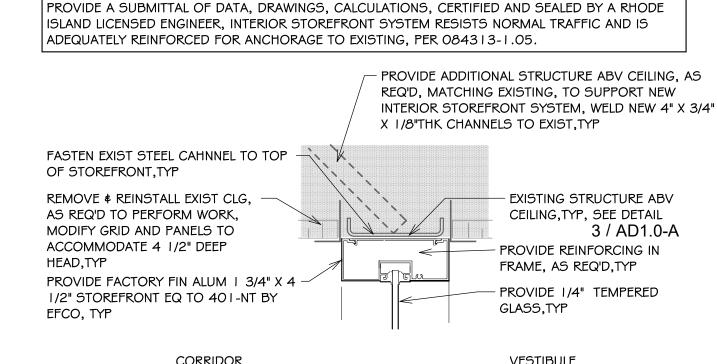

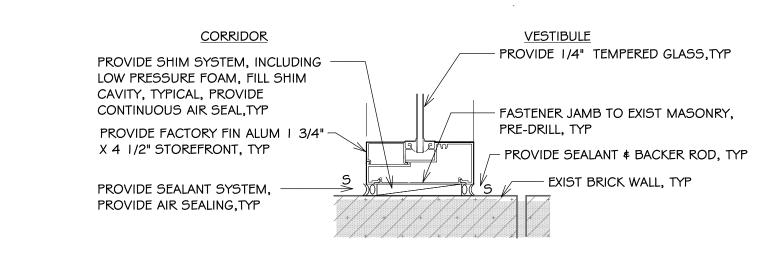

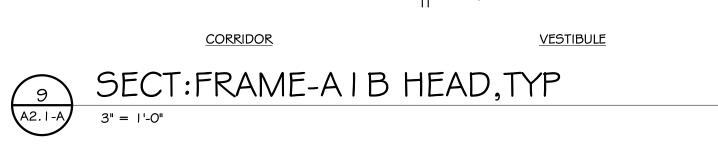



EXTERIOR DOOR **UPGRADES**

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02910

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Rev	vision Schedule
Revision Number	Revision Date

SHEET TITLE DOOR DETAILS

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DRAWN BY: Author JOB NUMBER: CHECKED BYChecker DATE: 02/25/25

Hoxsie ES SHEET: 6 OF: 14

NOTES: Hoxsie ES I. SEE DRAWING GI.O & GI.I FOR ADDITIONAL NOTES AND LEGENDS PERTAINING TO THE PROJECT.

2. SEE DWG 1 / A2.0-A FOR DOOR AND FRAME SCHEDULE & TYPES.


3. VERIFY EXISTING CONDITIONS IN FIELD. DO NOT DAMAGE OR CUT ANY STRUCTURAL ELEMENTS. IF CONDITIONS DIFFER TO WHAT IS SHOWN ON THESE DRAWINGS, NOTIFY ARCHITECT IMMEDIATELY PRIOR TO COMMENCING WORK.

F. COORDINATE REMOVAL ≰ REINSTALL OF EXIST EQUIPMENT INCLUDING SECURITY, ELECTRICAL, AND FIRE ALARM. REVIEW SECURITY W/ OWNER PRIOR TO CONSTRUCTION.


· ISSUED FOR PERMIT AND CONSTRUCTION


A2.1-A PROVIDE SHIM SYSTEM, INCLUDING LOW PRESSURE FASTENER JAMB TO EXIST MASONRY, PRE-DRILL, TYP

SECT: FRAME-AIA JAMB, TYP

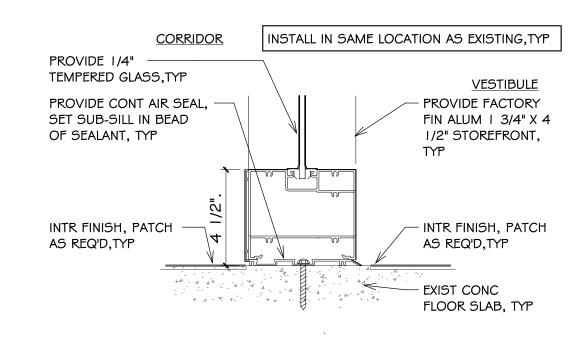



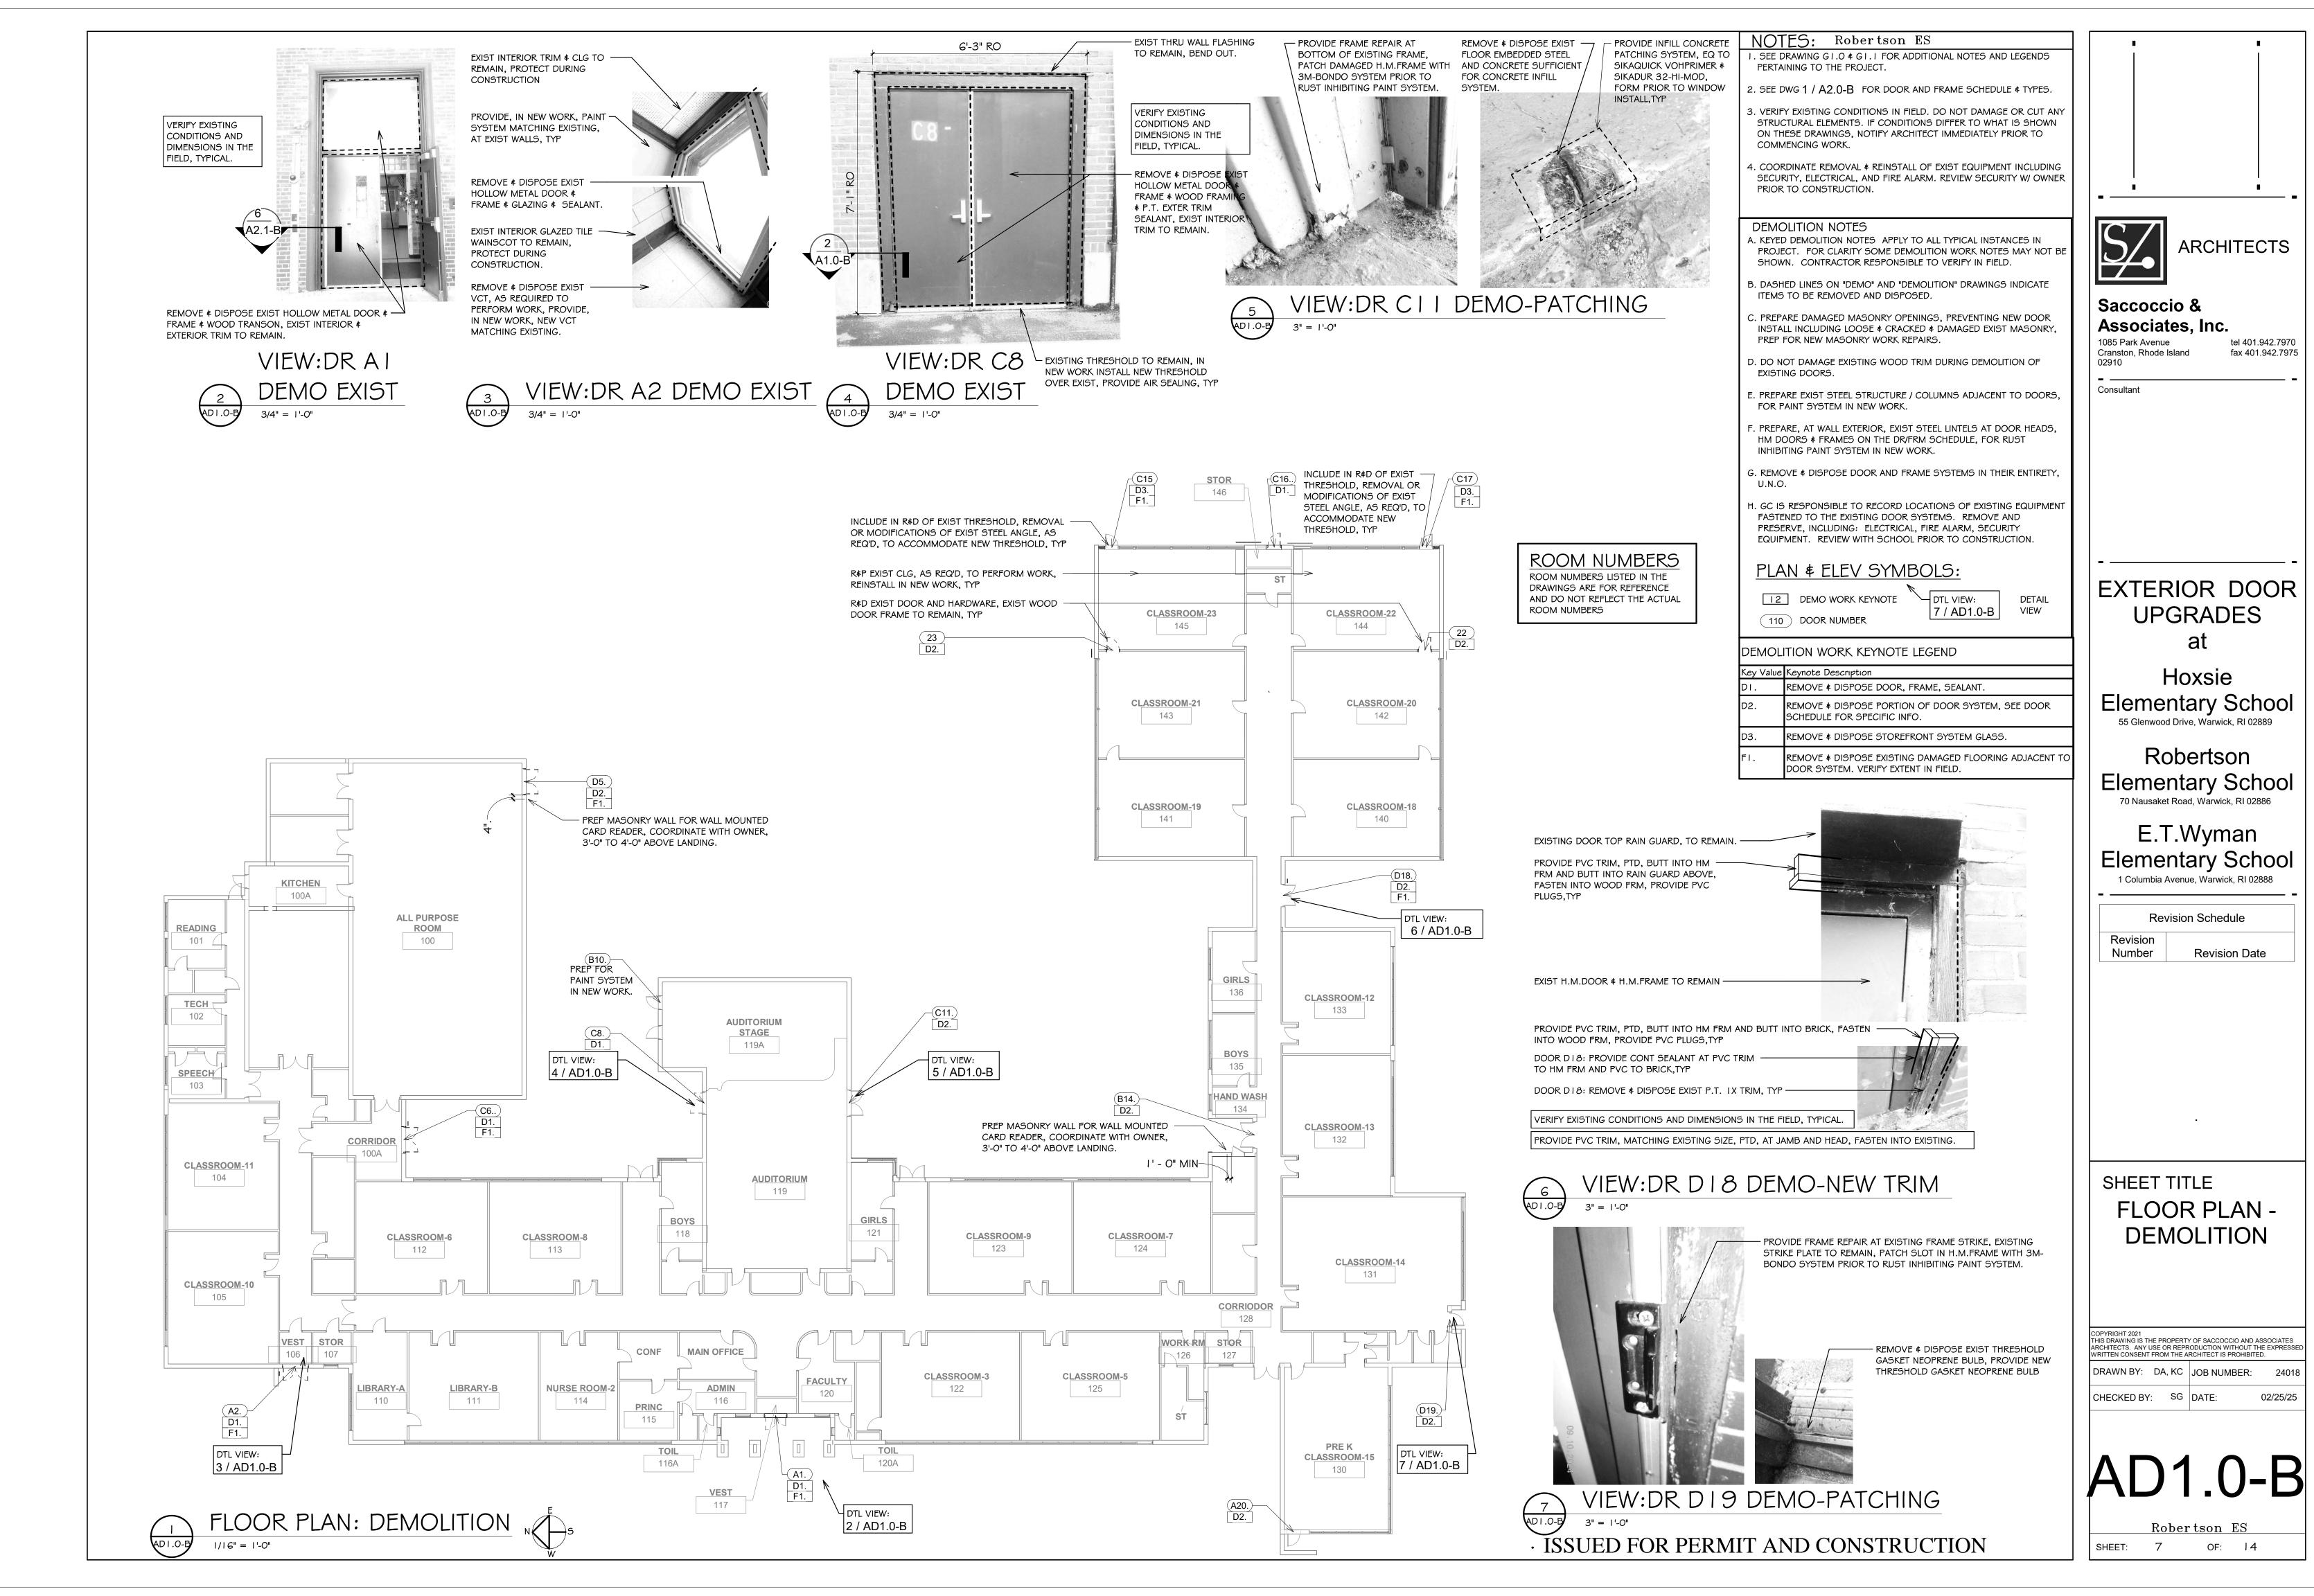

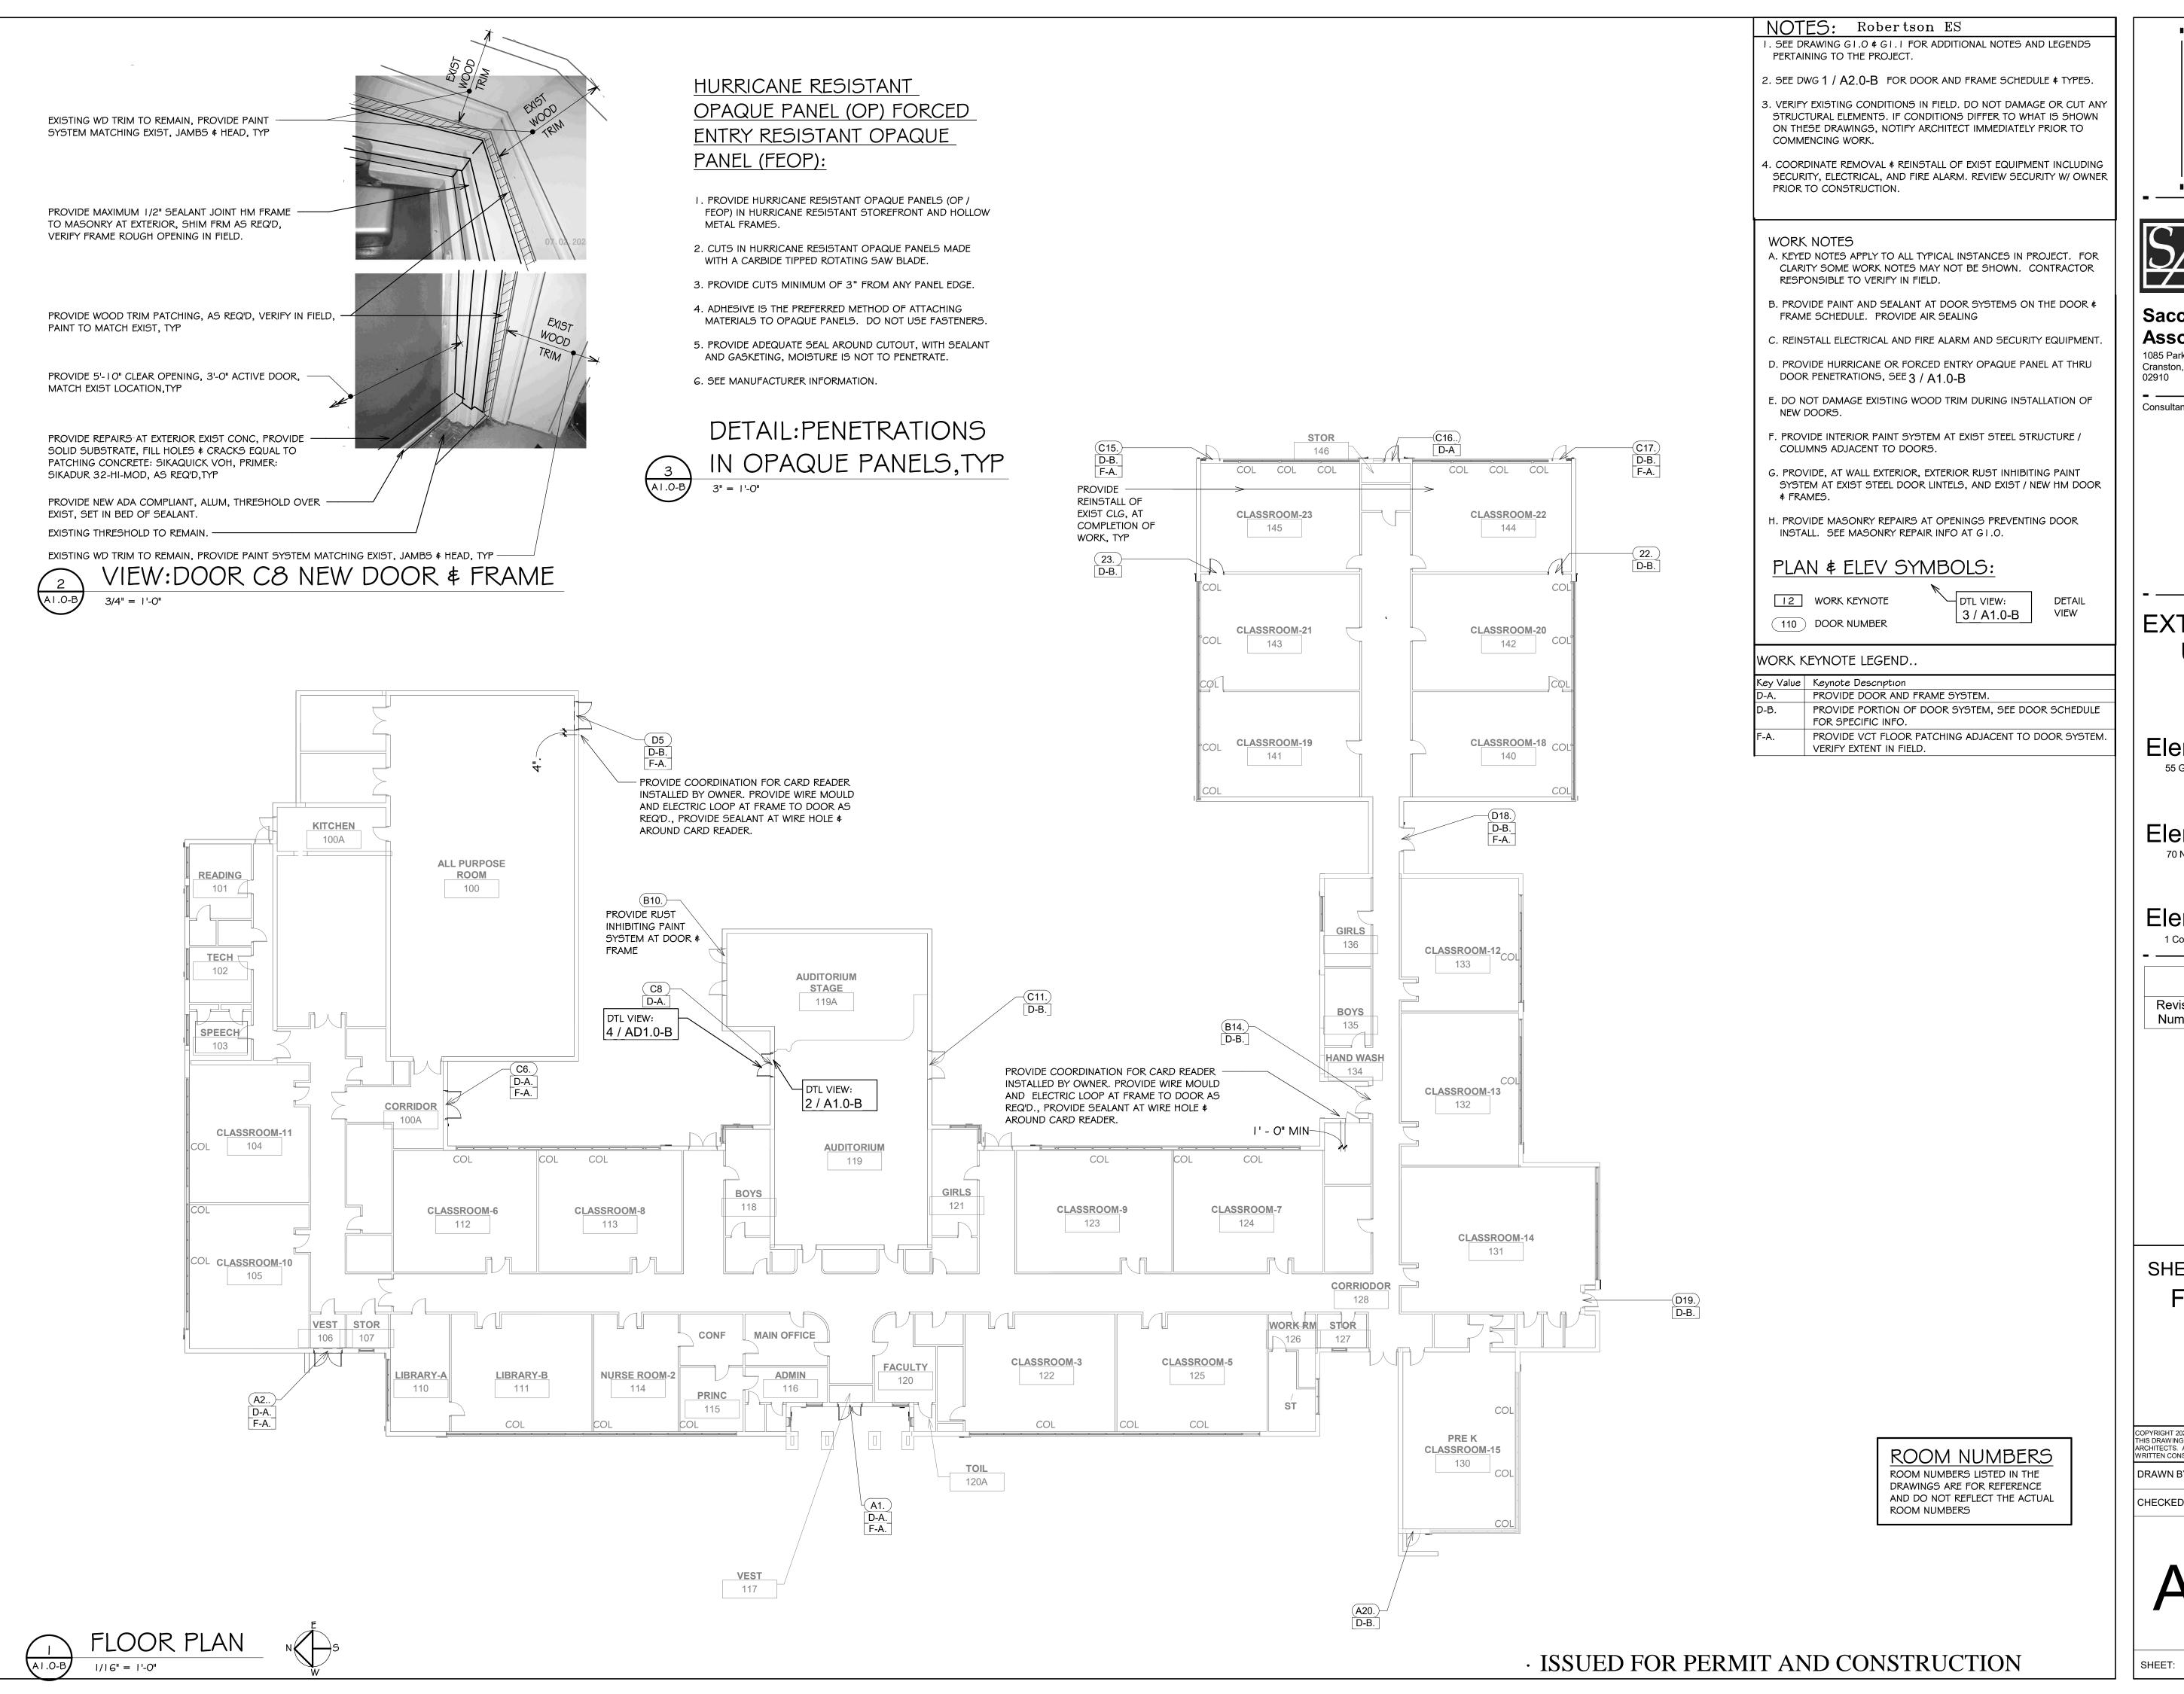

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Revision Schedule

Revision Date

SHEET TITLE FLOOR PLAN


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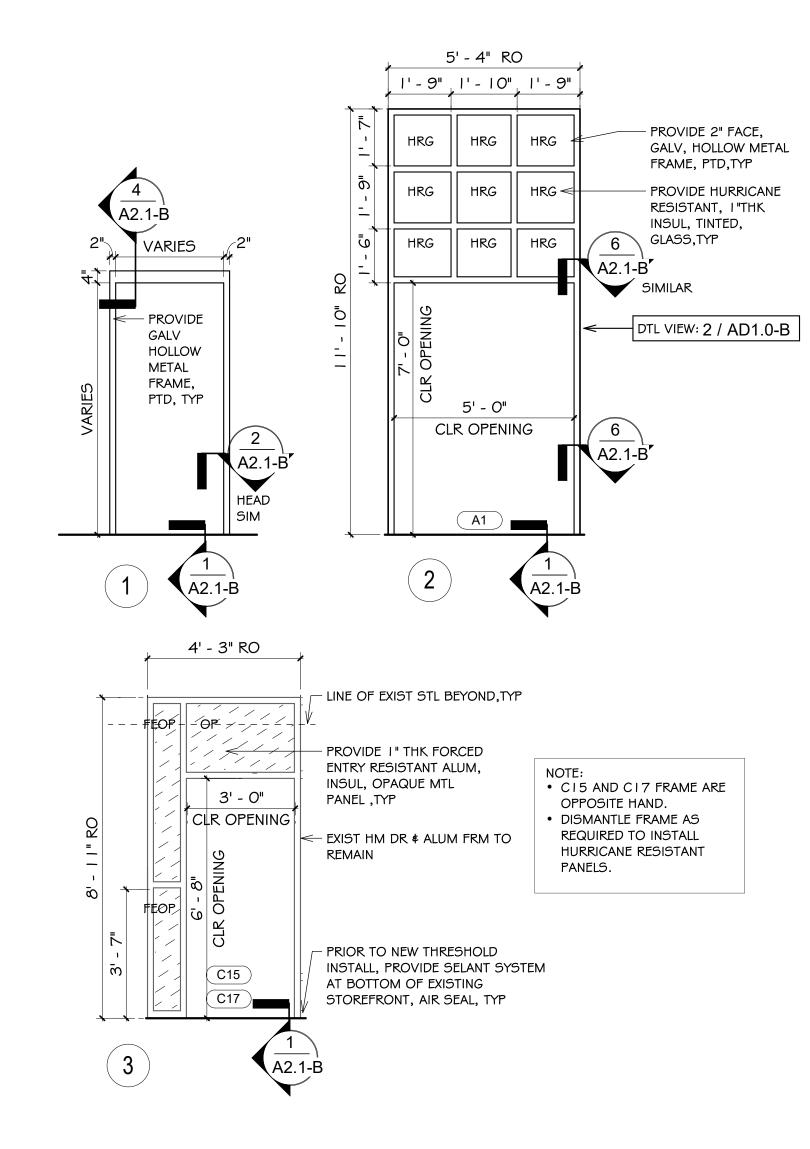
A1.0-B


Robertson ES

8 OF: 14



DOOR TYPES

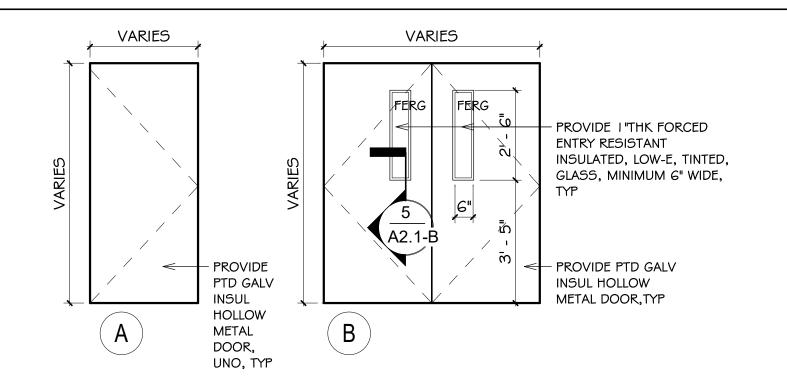

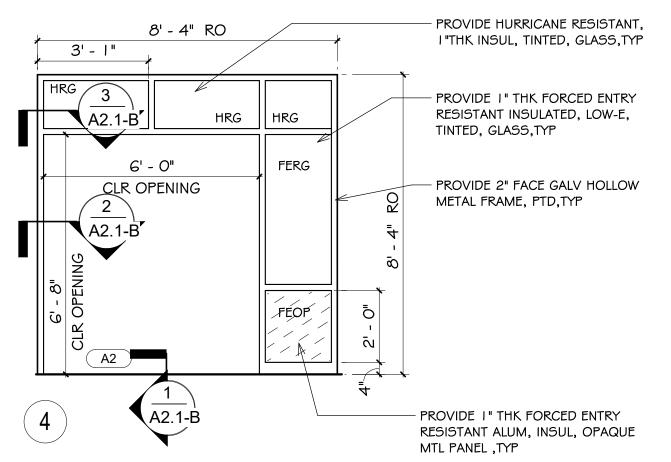

FRAME TYPES

DOOR AND FRAME TYPES

3/8" = 1'-0"

EXTERIOR DOOR AND FRAME SCHEDULE DR RM DR DR DR DR FRM FRM | FRM | FRM | GRP NO NO ROOM NAME TYPE MTL FIN GLASS TYPE SIZE/M.O DEEP | MTL | FIN | GLASS SILL DTL HD DTL WIDE HIGH JMB DTL DOOR SCHEDULE REMARKS HMG PTD FERG EXIST |7' - 0" |0' - | 3/4" |B 1 / A2.1-B N/A I-EQ PAIR, 3-ELEC LATCH, 5-DR # HRDWR, 6-PATCH FRAME, 8-RAIN GUARD, IO-THRESHOLD, HMG PTD NA 6'-4"W X 7'-4"H 100A CORRIDOR 6'-4"W X 7'-4"H REMARK-9 REMARK-9 REMARK-9 I-EQ PAIR, 8-RAIN GUARD, 9-SEE DR&FRM TYPES 5 3/4" | HMG | PTD | N/A REMARK-9 A2. 106 VESTIBULE REMARK-9 REMARK-9 I-EQ PAIR, 9-SEE DR&FRM TYPES 5 3/4" | HMG | PTD | FERG/HRG/OP |HMG |PTD |FERG REMARK-9 REMARK-9 REMARK-9 117 VESTIBULE 5'-4"W X | | |- | O"H | 5 3/4" | HMG | PTD | FERG/HRG/OP 2-UNEQUAL PAIR, 3-ELEC LATCH, 9-SEE DR&FRM TYPES C8. | 1 19 | AUDITORIUM 2-UNEQUAL PAIR, 8-RAIN GUARD, 9-SEE DR#FRM TYPES, SEE DETAIL 4 / AD1.0-B # 2 / A1.0-B |HMG |PTD | N/A REMARK-9 REMARK-9 REMARK-9 HMG PTD N/A N/A N/A CII. 119 AUDITORIUM 7-EXIST DR&FRM, 8-RAIN GUARD, 12-FRAME REPAIR N/A N/A N/A B14. 128 | CORRIDOR 7-EXIST DR&FRM, 13-ELEC LATCH-LOOP N/A 1 / A2.1-B DI8. 128 | CORRIDOR 4-WEATHER STRIPPING, 7-EXIST DR#FRM, IO-THRESHOLD, I5-DEMO WD TRIM-PVC TRIM N/A N/A | CLASSROOM | 4 | 3' - 0" | 7' - 0" | 0' - | 3/4" | EXIST | HMG | N/A | N/A 4-WEATHER STRIPPING, 16-PATCH FRAME ALUM | N/A | FEOP/OP REMARK-9 REMARK-9 REMARK-9 C17. 144 | CLASSROOM 22 | 3' - 0" | 7' - 0" | 0' - 1 3/4" | EXIST | 7-EXIST DR&FRM, 9-SEE DR&FRM TYPES, 10-THRESHOLD, 14-FEOP/OP ALUM N/A FEOP/OF REMARK-9 REMARK-9 C15. 145 | CLASSROOM 23 | 3' - 0" | 7' - 0" | 0' - 1 3/4" | EXIST | REMARK-9 7-EXIST DR#FRM, 9-SEE DR#FRM TYPES, 10-THRESHOLD, 14-FEOP/OP |A20.|130 |PRE-K CLASSRM 15|3' - 0" |7' - 0" |0' - 1 3/4" |EXIST |HMG | N/A | N/A HMG N/A N/A 4-WEATHER STRIPPING, 7-EXIST DR&FRM N/A N/A N/A |3' - 0" |6' - 8" |0' - | 3/4" |A | HMG |PTD | N/A REMARK-9 REMARK-9 REMARK-9 8-RAIN GUARD, 9-SEE DR&FRM TYPES |WD |PTD |N/A 5-DR&HRDWR, 17-HARDWARE

WD PTD NA

DOOR SCHEDULE GENERAL NOTES: PROVIDE AT EACH OPENING LISTED ON THE DOOR AND FRAME SCHEDULE:

I. SEE DRAWING GI.O & GI.2 FOR ADDITIONAL NOTES AND LEGENDS PERTAINING TO THE PROJECT. SEE FRAME TYPES FOR DOOR/FRAME DETAILS AT 1 / A2 0-B

SC-WD PTD N/A EXIST

- 2. VERIFY EXISTING CONDITIONS AND DIMENSIONS IN THE FIELD PRIOR TO SHOP DRAWINGS & FABRICATION.
- 3. EXISTING DOORS ON THE DOOR/FRAME SCHEDULE, LEAVE DOOR IN PLACE UNLESS REQUIRED TO PERFORM WORK.
- 4. PROVIDE AT EXISTING STEEL LINTELS AND EXISTING H.M. DOORS \$ H.M. FRAMES LISTED ON THE DOOR/FRAME SCHEDULE, INCLUDING EXISTING TO REMAIN DOOR TOP RAIN GUARDS, PREPARE AND PROVIDE A RUST RESISTANT PAINT SYSTEM. PREPARATION TO INCLUDE LIGHT RUST REMOVAL WITH WIRE BRUSH AND SCRAPE. PROVIDE RUST INHIBITING PAINT SYSTEM INCLUDING (I) COAT RUST INHIBITING ACRYLIC PRIMER EQUAL TO "PRO-INDUSTRIAL PRO-CRYL" NUMBER BG6-I 300 AND (2) COATS RUST INHIBITING ACRYLIC FINISH EQUAL TO "PRO-INDUSTRIAL DTM ACRYLIC" NUMBER BG6-I 150, BY SHERWIN WILLIAMS, COLOR SELECTED BY ARCHITECT.
- 5. HOLLOW METAL DOORS AND HOLLOW METAL FRAMES, ON THE DOOR/FRAME SCHEDULE, TO BE GALVANIZED.
- 6. HOLLOW METAL DOORS, ON THE DOOR/FRAME SCHEDULE, TO BE INSULATED

23 | 145 | CLASSROOM 23 | 2'-8" | 6' - 5" | 0' - 1 3/4" | A

- 7. NEW AND EXISTING DOOR SYSTEMS ON THE DOOR/FRAME SCHEDULE, PROVIDE WEATHER STRIPPING, INSTALLED WITH STAINLESS STEEL SCREWS, SET IN BED OF SEALANT, INCLUDING DOOR BOTTOM RAIN DRIP W/ RUBBER GASKET EQUAL TO PEMKO 3452DPK. REMOVE \$ DISPOSE EXISTING WEATHER STRIPPING.
- 8. PROVIDE FORCED ENTRY AND / OR HURRICANE RESISTANT INSULATED OPAQUE METAL PANELS (FEOP / OP) I THICK AT HM FRAMES, EXIST STOREFRONT, EQUAL TO MAPESHIELD, BY MAPES.

 5 / A2 1
- 9. PROVIDE FORCED ENTRY RESISTANT GLASS (FERG) AND HURRICANE RESISTANT GLASS (HRG) PER DOOR / FRAME SCHEDULE AND DOOR / FRAME TYPES, I" THICK AT HM DOORS, HM FRAMES, EXIST STOREFRONT, INSULATED, TEMPERED AS REQUIRED, MINIMUM WIDTH OF VISION LITES 6", GRAY TINT EQUAL TO GUARDIAN CRYSTAL GRAY COLOR OR VITRO OPTIGRAY COLOR, LOW-E (#2) EQUAL TO GUARDIAN SNG8 OR SOLARBAN 70 PROPERTIES, FERG INTER LAYER EQUAL TO SCHOOL GUARD GLASS SG5 OR OLD CASTLE ARMORPROTECT PLUS 121000, HRG INTER LAYER EQUAL TO 0.060 PVB OR SGP. COLORS SELECTED BY ARCHITECT. GLASS TO BE INSTALLED TO MEET CODE AND MANUFACTURERS REQUIREMENTS, SEE DETAIL 5 / A2.1-B
- I O. PROVIDE REPAIRS TO EXISTING FLASHING TO REMAIN. BEND UP EXIST FLASHING DURING DEMOLITION. IN NEW WORK PROVIDE PATCHING AND REPAIRS TO EXIST FLASHING WITH MATCHING MATERIALS, AS REQ'D, POP RIVET NEW TO OLD. BEND EXISTING FLASHING BACK DOWN AT END OF PROJECT.
- I I. REMOVE \$ DISPOSE EXIST VCT, AS REQ'D, TO INSTALL NEW WORK AND DAMAGED EXIST TILES ADJACENT TO DOOR, VERIFY IN FIELD. PROVIDE VINYL COMPOSITION TILE MATCHING EXISTING, INCLUDE PORTION OF A TILE AND ONE FULL TILE THE WIDTH OF THE DOOR OPENING.
- 12. PROVIDE ADA COMPLIANT, THERMALLY BROKEN, ALUM THRESHOLD AT NEW FRAMES AND WHERE NOTED ON THE DOOR/FRAME SCHEDULE, REMOVE & DISPOSE EXISTING ALUMINUM THRESHOLDS, ALUM RAMPS, CUT OR GRIND OR REMOVE EXISTING RUSTED STEEL ANGLES AT SILLS SUFFICIENT TO INSTALL NEW THRESHOLDS. SET IN BED OF SEALANT, PROVIDE SEALANT AT EXISTING TO REMAIN THRESHOLDS, PROVIDE AIR SEALING. SEE DETAIL 1 / A2 1-R
- 13. PROVIDE, AT HEAD, JAMB, SILL, SOLID SUBSTRATE FOR NEW DOOR SYSTEM FASTENING. FILL HOLES AND CRACKS AND RE-FORM WITH REPAIR CONCRETE INCLUDING (A) SIKAQUICK VOH AND SIKADUR-32 HI-MOD (B) ARDEX TWP AND ARDEX EP 2000 (C) ABATRON ABOWELD 55-1 AND ABATRON PRIMKOTE 8006-1. CONCRETE MASONRY WALL REPAIR BASIS OF DESIGN "TEK 08-01A: MAINTENANCE OF CONCRETE MASONRY WALLS" BY NATIONAL CONCRETE MASONRY ASSOCIATION (NCMA.ORG), BRICK MASONRY WALL REPAIR BASIS OF DESIGN "TECHNICAL NOTE 46: MAINTENANCE OF BRICK MASONRY" & "TECHNICAL NOTE 7: WATER PENETRATION RESISTANCE DESIGN AND DETAILING" BY BRICK INDUSTRY ASSOCIATION (WWW.GOBRICK.COM).
- 14. PROVIDE AIR AND WATER SEALING AT EXTERIOR ENVELOPE, INSULATION FILL AT SHIM SPACES OF LOW PRESSURE FOAM EQ TO DOW GREAT STUFF PRO WINDOW \$ DOOR, SEALANT SYSTEM AT FRAME TO MASONRY AND THRESHOLD TO SILL, SILICONE SEALANT \$ BACKER ROD EQ TO DOWSIL-795 OR SPECTRUM-2. COLORS SELECTED BY ARCHITECT.
- 15. PROVIDE WIRE MOULD SYSTEM, AS REQUIRED, AT DOOR ELECTRIC LATCH LOCATIONS. PROVIDE ELECTRIC ARMORED LOOP BETWEEN FRAME AND DOOR, AS REQUIRED. MOUNT CARD READER 3'-0" TO 4'-0" ABOVE GRADE. SCHOOL TO PROVIDE AND INSTALL CARD READER AND FINAL ELECTRIC CONNECTIONS. GC COORDINATE WITH SCHOOL PRIOR TO CONSTRUCTION.
- I 6. PROVIDE, AT EXIST HM FRAMES TO REMAIN, REPAIRS INCLUDING GALV PLATE INFILL SCREWED IN AT REMOVED BUTT HINGES, PROVIDE 3M-BONDO SYSTEM OVER PATCH PLATE PRIOR TO RUST INHIBITING PAINT SYSTEM. LOOSE FRAMES RE-FASTEN, REMOVE & PRESERVE EXIST FRAME, FILL HOLES & CRACKS, REFORM MASONRY, AS REQ'D, REINSTALL EXIST FRAME. PROVIDE, AS REQ'D, FRAME REINFORCING.
- 17. PROVIDE, AT EXTERIOR ENVELOPE, PRESSURE TREATED WOOD TREATED WITH MICRONIZED COPPER AZOLE (MCA) OR EQUAL AS NOTED IN THE ICC-ES REPORT "ESR-1721" LATEST VERSION. WOOD TREATMENT SYSTEM TO BE COMPLIANT WITH BUILDING CODE AND RIDE REQUIREMENTS. SEPARATE TREATED WOOD FROM METAL WITH SELF ADHERING MEMBRANE, EQUAL TO HENRY "BLUESKIN BUTYL FLASH" COMPATIBLE WITH PROJECT MATERIALS. DO NOT USE PRESSURE TREATED WOOD AT EXTERIOR AND EXTERIOR DOOR FRAMES.
- 18. ASBESTOS HAS BEEN IDENTIFIED IIN THE SCHOOL, REFER TO THE ASBESTOS REPORT IN THE SPECIFICATIONS SECTION 003119. NOTIFY THE ARCHITECT IMMEDIATELY OF ANY ADDITIONAL ASBESTOS FOUND.

DOOR SCHEDULE REMARKS:

- I. PROVIDE EQUAL PAIR OF DOORS.
- 2. PROVIDE UN-EQUAL PAIR OF DOORS. 3-0" DOOR TO BE THE ACTIVE DOOR.
- 3. PROVIDE ELECTRONIC LATCH SYSTEM. PROVIDE WIRING THRU THE FRAME OR SURFACE MOUNTED IN WIRE MOULD, AS REQUIRED, AND PROVIDE ARMORED DOOR LOOP, AS REQ'D.
- 4. PROVIDE WEATHER STRIPPING AT EXIST DOORS AND SURFACE APPLIED DOOR BOTTOM RAIN DRIP W/ RUBBER GASKET EQ TO PEMKO 3452-DPK.
- 5. PROVIDE DOOR AND HARDWARE AT EXISTING FRAME

5-DR&HRDWR, 17-HARDWARE

- 6. PROVIDE FRAME PATCHING, INFILL AT REMOVED EXIST BUTT HINGES WITH SCREWED IN GLAV STL PLATES, PROVIDE 3M-BONDO SYSTEM OVER PATCH PRIOR TO RUST INHIBITING PAINT SYSTEM.
- 7. EXISTING DOOR AND FRAME TO REMAIN
- 8. PROVIDE DOOR TOP RAIN GUARD. PROVIDE SEALANT, SET IN BED OF SEALANT. SEE DTL 4 / A2.1-B
- 9. REFER TO THE DOOR AND FRAME TYPES FOR DETAILS AT 1 / A2.0-B
- 10. PROVIDE THRESHOLD, SEE DETAIL 1 / A2.1-B
- II. DOOR AI: PROVIDE ELECTRIC TWO POINT LATCHING PANIC BAR, LEFT DOOR ACTIVE AS VIEWED FROM EXTERIOR. CONNECT TO EXIST WIRING. PROVIDE PULL AT EXTERIOR LEFT DOOR. PROVIDE WIRE MOULD, AS REQUIRED.
- 12. DOOR CIT: PROVIDE REPAIR AT BOTTOM OF EXISTING FRAME, PATCH DAMAGED H.M.FRAME WITH 3M-BONDO SYSTEM PRIOR TO RUST INHIBITING PAINT SYSTEM. REMOVE \$ DISPOSE EXIST FLOOR EMBEDDED STEEL, PATCH CONCRETE, SEE DETAIL 5 / AD1.0-B
- 13. PROVIDE AT DOOR B14 ELECTRIC LATCHING PANIC BAR, AT RIGHT DOOR AS VIEWED FROM EXTERIOR, PROVIDE WIRING HOLE IN MASONRY WALL TO RIGHT OF DOOR. PROVIDE PULL AT EXTERIOR. CARD READER MOUNTED 3'-O" TO 4'-O" ABOVE LANDING. PROVIDE WIRE MOULD AND FRAME TO DOOR ELECTRIC ARMORED LOOP, AS REQUIRED.
- 14. PROVIDE AT DOOR C15 & C17 I" THICK INSULATED, FACTORY FINISH, FORCED ENTRY AND HURICANE RESISTANT OPAQUE METAL PANELS (FEOP/OP) IN EXISTING STOREFRONT FRAME. DISMANTLE FRAME, AS REQUREID, TO REMOVE & DISPOSE EXIST GLASS AND INSTALL NEW PANELS. END NIPPER BOLT CUTTERS MAY BE ERQUIRED.
- 15. PROVIDE AT DOOR DIB RED EXISTING EXTERIOR SURFACE MOUNTED HANDLES AND BONDO HOLES, RED EXIST JAMB & HEAD IX P.T. TRIM, PROVIDE PVC TRIM, PAINTED, MATCHING EXISTING REMOVED PT WOOD TRIM. SEE DTL
- I G. PROVIDE AT DOOR DIP REPAIR AT EXISTING FRAME NEAR LATCH, PATCH DAMAGED H.M.FRAME WITH 3M-BONDO SYSTEM PRIOR TO RUST INHIBITING PAINT SYSTEM. REMOVE & DISPOSE EXIST THRESHOLD GASKET NEOPRENE BULB, PROVIDE NEW THRESHOLD GASKET NEOPRENE BULB, SEE DETAIL
- I 7. PROVIDE AT INTERIOR DOORS 22 AND 23: I 3/4" THICK SOLID CORE WOOD DOORS IN CLASSROOMS 22 \$ 23 AND MODIFICATIONS OF EXISTING WOOD FRAME, AS REQUIRED, AT NEW HINGES AND STRIKE PLATE. PROVIDE BUTT HINGES.

ABBREVIATION

ALUM = ALUMINUM

CLR = CLEAR

DTL = DETAIL

DR = DOOR

EX = EXISTING

EXIST = EXISTING

FEOP = FORCED ENTRY OPAQUE PANEL

FERG = FORCED ENTRY RESISTANT GLASS

FIN = FINISH

FF = FACTORY FINISH

FRM = FRAME

GALV = GALVANIZED

GRP = GROUP

JMB = JAMB

HD = HEAD

HMG = HOLLOW METAL GALVANIZED

HORIZ = HORIZONTAL

HRDWR = HARDWARE

HRG = HURRICANE RESISTANT GLASS

INSUL = INSULATION
MIN = MINIMUM
MTL = METAL
N/A = NOT APPLICABLE
NO = NUMBER
OP = HURRICANE RESISTANT

OPAQUE PANEL

VIF = VERIFY IN FIELD

PTD = PAINTED

REQ'D = REQUIRED

RM = ROOM

SC-WD = SOLID CORE WOOD DOOR

SIM = SIMILAR

STL = STEEL

THK = THICK

TYP = TYPICAL

NOTES: Robertson ES

- I. SEE DRAWING GI.O & GI.I FOR ADDITIONAL NOTES AND LEGENDS
 PERTAINING TO THE PROJECT.
- 2. SEE DWG 1 / A2.0-B FOR DOOR AND FRAME SCHEDULE \$ TYPES.
- 3. VERIFY EXISTING CONDITIONS IN FIELD. DO NOT DAMAGE OR CUT ANY STRUCTURAL ELEMENTS. IF CONDITIONS DIFFER TO WHAT IS SHOWN ON THESE DRAWINGS, NOTIFY ARCHITECT IMMEDIATELY PRIOR TO COMMENCING WORK.
- 4. COORDINATE REMOVAL & REINSTALL OF EXIST EQUIPMENT INCLUDING SECURITY, ELECTRICAL, AND FIRE ALARM. REVIEW SECURITY W/ OWNER PRIOR TO CONSTRUCTION.

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1 Columbia Avenue, Warwick, RI 02888

Revision Schedule

Revision Date

Number

SHEET TITLE
DOOR & FRAME
SCHEDULE,

SCHEDULE, DOOR TYPES, FRAME TYPES


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CHECKED BY: SG DATE: 02/25/25

NY |

A2.0-B

Robertson ES
SHEET: 9 OF: 14

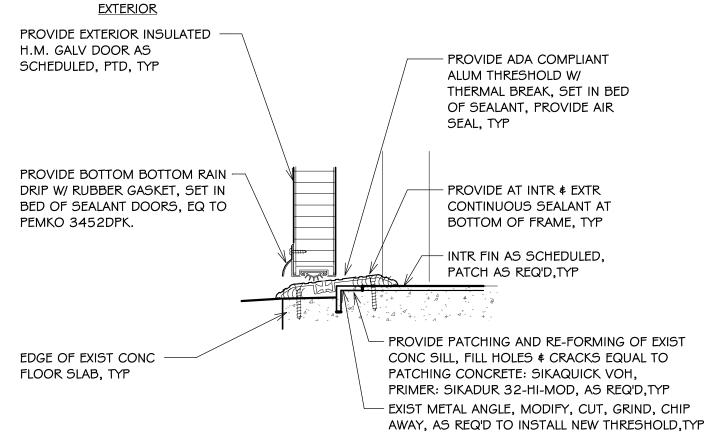

REPAIR EXIST EXTERIOR MASONRY WALLS, AS REQ'D, TYP PROVIDE SEALANT & BACKER ROD, AS REQ'D, TYP - VERIFY IN FIELD, MATCH EXIST, TYP. PROVIDE GALVANIZED INSULATED HOLLOW METAL DOOR,PTD,TYP — — []] PROVIDE EXISTING WALL CONCEALED ANCHOR, PRE-DRILL. ANCHORS WELDED TO FRAME, TYP. PROVIDE GLAV HOLLOW FRAME, AS SCHEDULED, PTD, INSTALL FRAME IN SAME LOCATION AS EXISTING, TYP PROVIDE SEALANT & BACKER ROD, AS REQ'D, TYP

EXIST EXTERIOR MASONRY WALLS


SYSTEM,TYP

EXIST WOOD TRIM & BLOCKING TO REMAIN, DO

NOT SCRAP OR SAND TO WOOD SURFACE,

ACCOMMODATE ADHESION OF NEW PAINT

PROVIDE PREP TO EXISTING PAINT TO

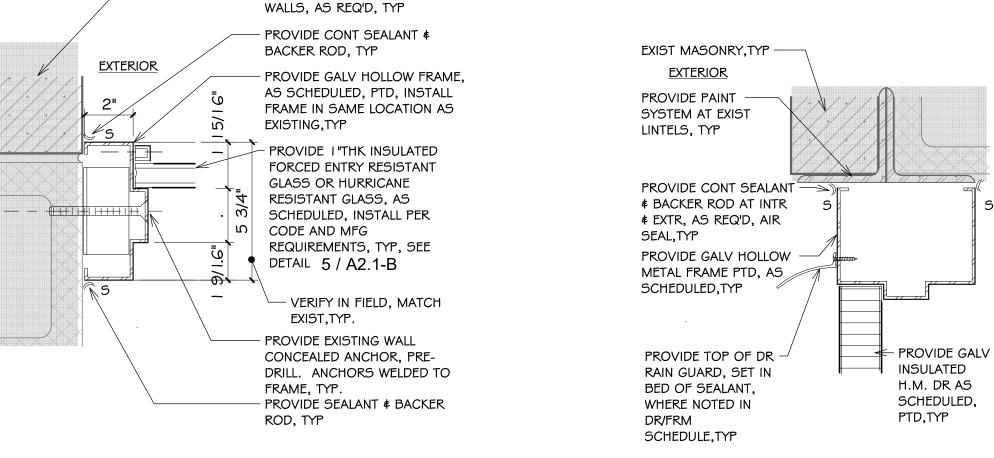












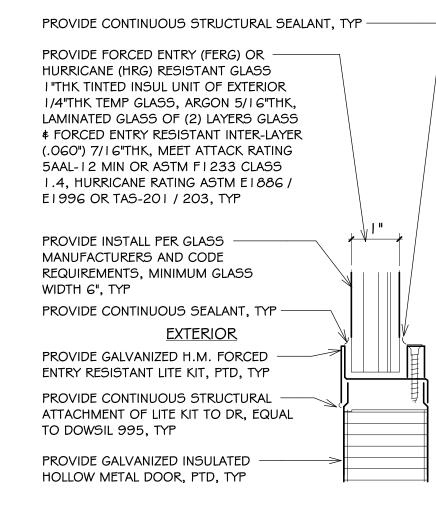

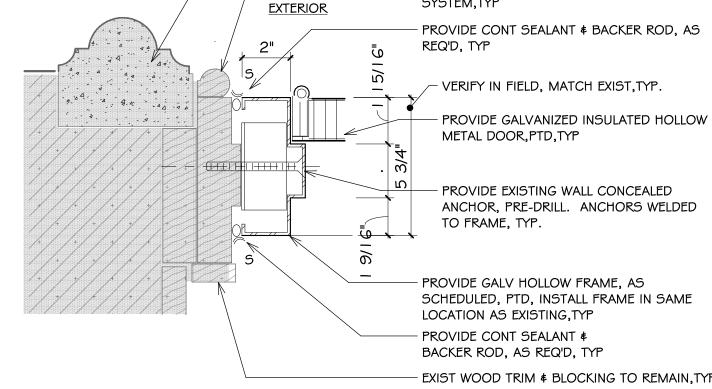

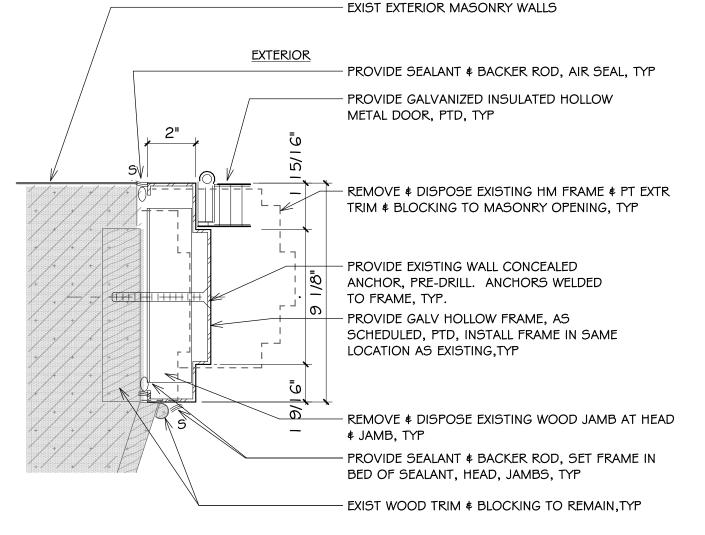


REPAIR EXIST MASONRY



SECT:H.M. DR LITE TRIM, TYP

S'' = 1'-0"

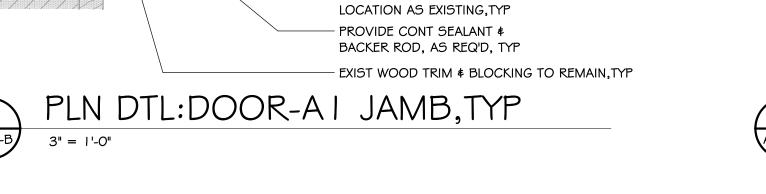



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Robertson

Elementary School

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E.T.Wyman

Elementary School 1 Columbia Avenue, Warwick, RI 02888

Revision Schedule

Revision Date

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CHECKED BY: SG DATE: 2. SEE DWG 1 / A2.0-B FOR DOOR AND FRAME SCHEDULE \$ TYPES.

A2.1-B

Robertson ES 10 of: 14

STRUCTURAL ELEMENTS. IF CONDITIONS DIFFER TO WHAT IS SHOWN ON THESE DRAWINGS, NOTIFY ARCHITECT IMMEDIATELY PRIOR TO COMMENCING WORK. 4. COORDINATE REMOVAL & REINSTALL OF EXIST EQUIPMENT INCLUDING SECURITY, ELECTRICAL, AND FIRE ALARM. REVIEW SECURITY W/ OWNER

3. VERIFY EXISTING CONDITIONS IN FIELD. DO NOT DAMAGE OR CUT ANY


I. SEE DRAWING GI.O & GI.I FOR ADDITIONAL NOTES AND LEGENDS

· ISSUED FOR PERMIT AND CONSTRUCTION


PRIOR TO CONSTRUCTION.

NOTES: Robertson ES

PERTAINING TO THE PROJECT.

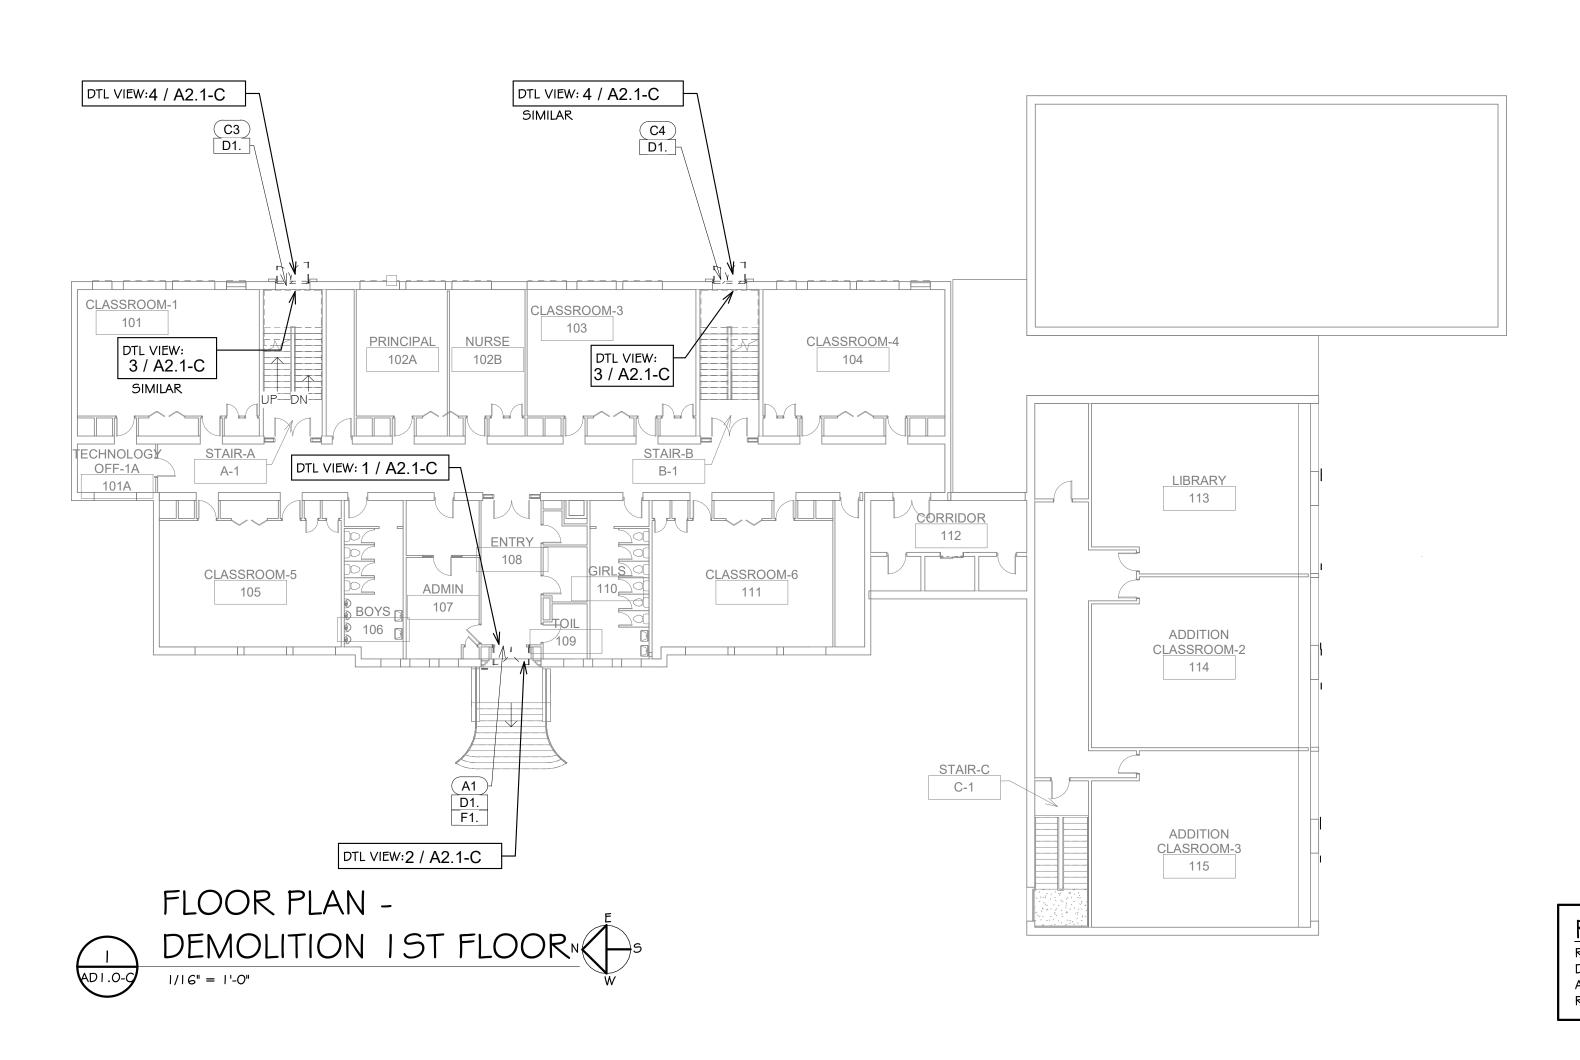

ROOM NUMBERS ROOM NUMBERS LISTED IN THE DRAWINGS ARE FOR REFERENCE AND DO NOT REFLECT THE ACTUAL ROOM NUMBERS

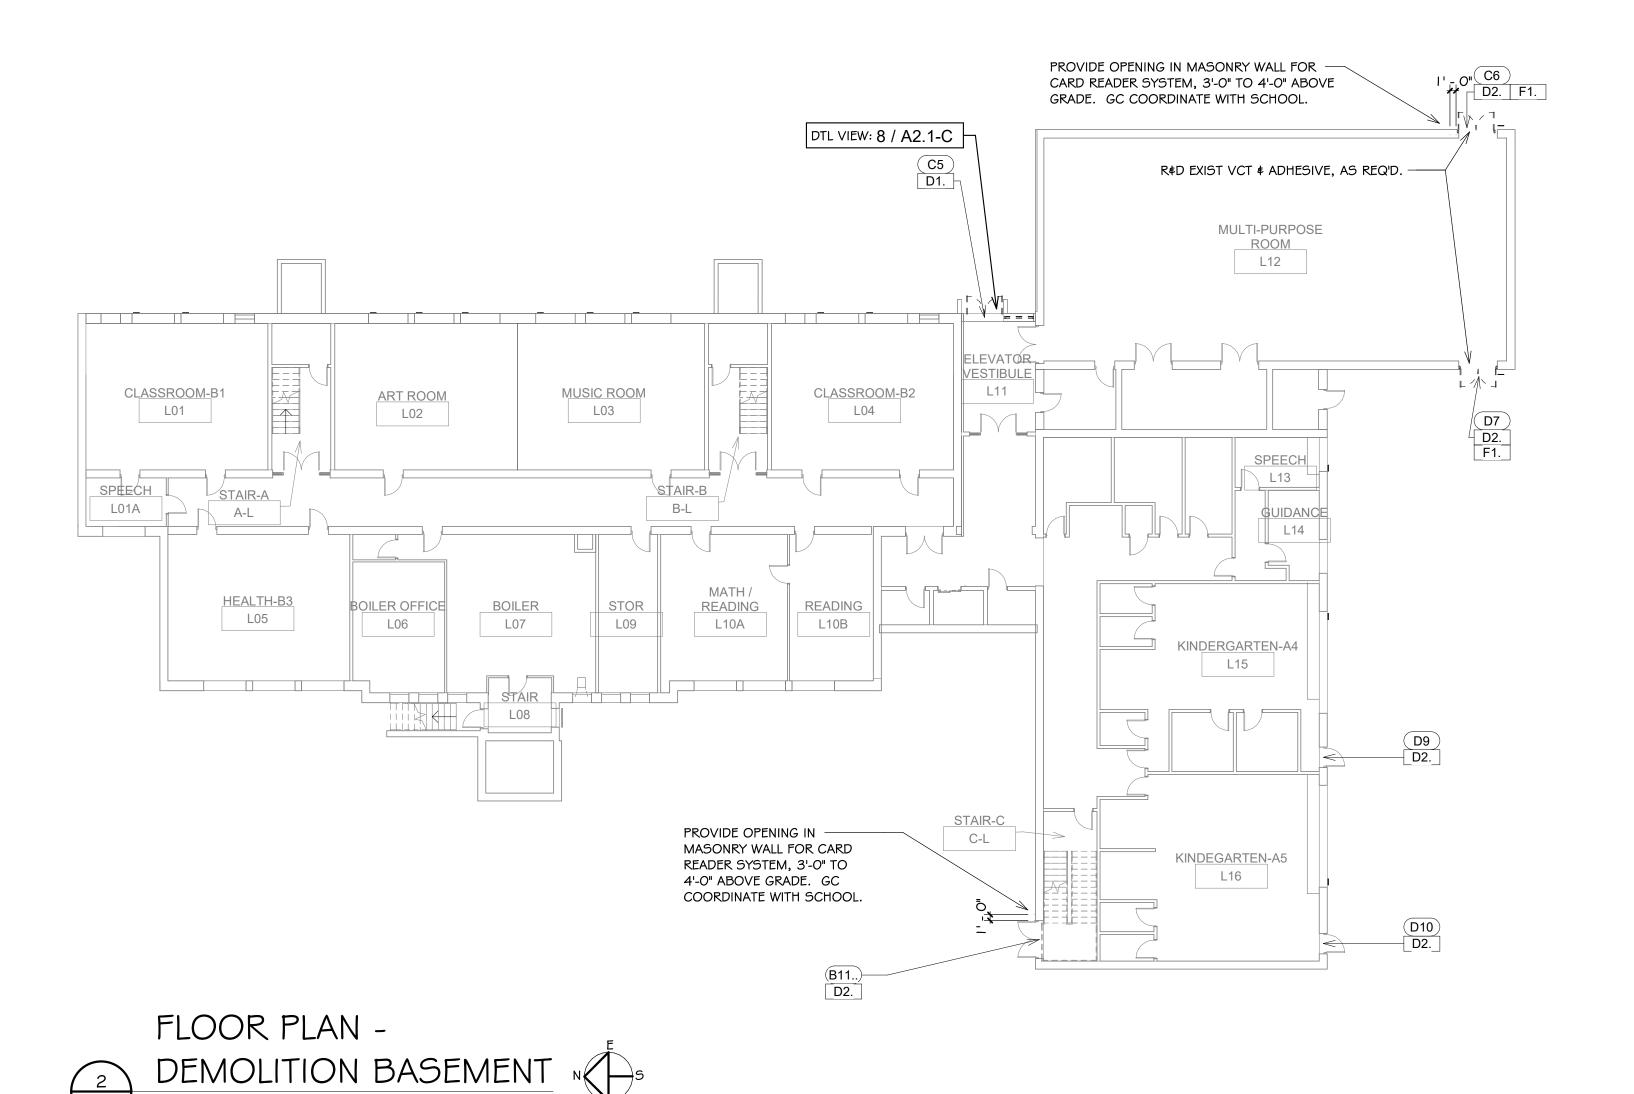

NOTES: Wyman ES

1. SEE DRAWING G1.0 \$ G1.1 FOR ADDITIONAL NOTES AND LEGENDS PERTAINING TO THE PROJECT.

2. SEE DWG 1 / A2.0-C FOR DOOR AND FRAME SCHEDULE \$ TYPES.

- 3. VERIFY EXISTING CONDITIONS IN FIELD. DO NOT DAMAGE OR CUT ANY STRUCTURAL ELEMENTS. IF CONDITIONS DIFFER TO WHAT IS SHOWN ON THESE DRAWINGS, NOTIFY ARCHITECT IMMEDIATELY PRIOR TO COMMENCING WORK.
- 4. COORDINATE REMOVAL & REINSTALL OF EXIST EQUIPMENT INCLUDING SECURITY, ELECTRICAL, AND FIRE ALARM. REVIEW SECURITY W/ OWNER PRIOR TO CONSTRUCTION.

DEMOLITION NOTES

A. KEYED DEMOLITION NOTES APPLY TO ALL TYPICAL INSTANCES IN PROJECT. FOR CLARITY SOME DEMOLITION WORK NOTES MAY NOT BE SHOWN. CONTRACTOR RESPONSIBLE TO VERIFY IN FIELD.

B. DASHED LINES ON "DEMO" AND "DEMOLITION" DRAWINGS INDICATE ITEMS TO BE REMOVED AND DISPOSED, UNLESS NOTED OTHERWISE,

C. PREPARE DAMAGED MASONRY OPENINGS, PREVENTING NEW DOOR INSTALL INCLUDING LOOSE & CRACKED & DAMAGED MASONRY, PREP FOR NEW MASONRY WORK REPAIRS.

D. DO NOT DAMAGE EXIST WOOD TRIM AT DOORS.

E. PREPARE EXISTING STEEL DOOR LINTELS FOR PAINT SYSTEM IN NEW

F. REMOVE & DISPOSE EXISTING DOOR & FRAME SYSTEMS IN THEIR ENTIRETY, UNO.

G. GC IS RESPONSIBLE TO RECORD LOCATIONS OF EXISTING EQUIPMENT FASTENED TO THE EXISTING WINDOW AND DOOR SYSTEMS. REMOVE AND PRESERVE, INCLUDING: ELECTRICAL, FIRE ALARM, SECURITY EQUIPMENT.

PLAN & ELEV SYMBOLS:

12 DEMO WORK KEYNOTE ☐ DTL VIEW: 1 / A2.0-C 110 DOOR NUMBER

DOOR SYSTEM. VERIFY EXTENT IN FIELD.

VIEW

DETAIL

WORK KEYNOTE LEGEND DEMOLITION

KEY	KEYNOTE DESCRIPTION
VALUE	
DI.	REMOVE \$ DISPOSE DOOR, FRAME, SEALANT.
D2.	REMOVE & DISPOSE PORTION OF DOOR SYSTEM, SEE DOOR
	SCHEDULE FOR SPECIFIC INFO.
FI.	REMOVE & DISPOSE EXISTING DAMAGED FLOORING ADJACENT TO



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Robertson **Elementary School** 70 Nausaket Road, Warwick, RI 02886

E.T.Wyman **Elementary School** 1 Columbia Avenue, Warwick, RI 02888

Revision Schedule

Revision Date

Revision


SHEET TITLE FLOOR PLANS -**DEMOLITION**

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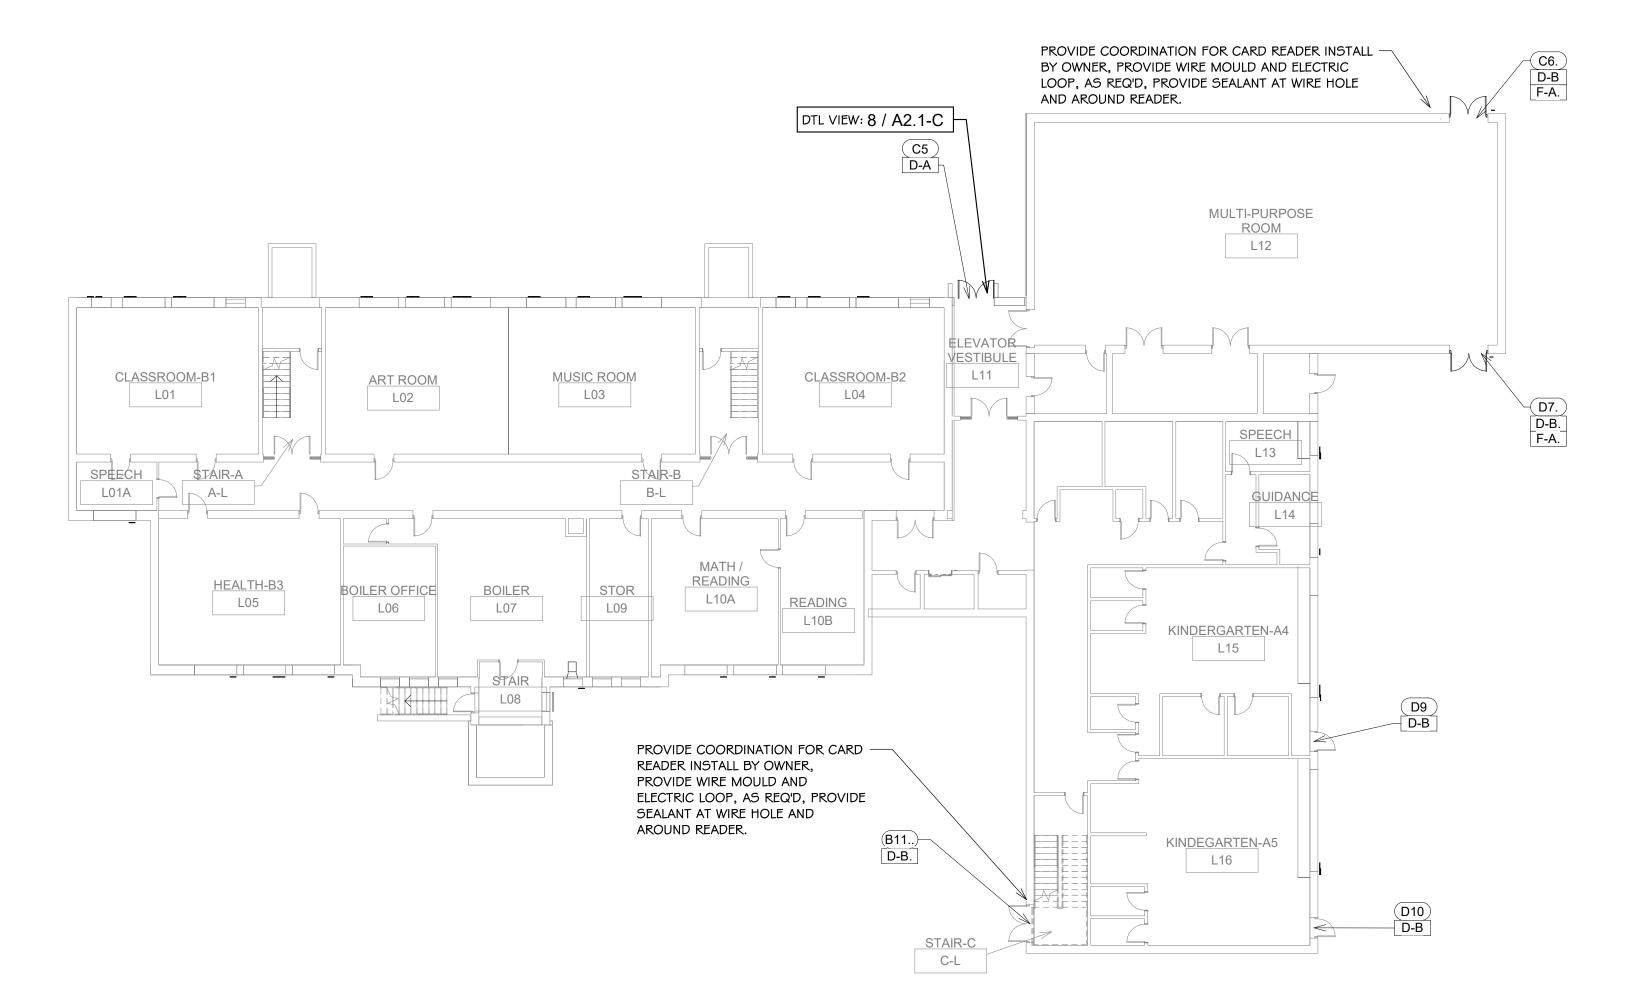
AD1.0-C

Wyman ES OF: 14 SHEET: | |



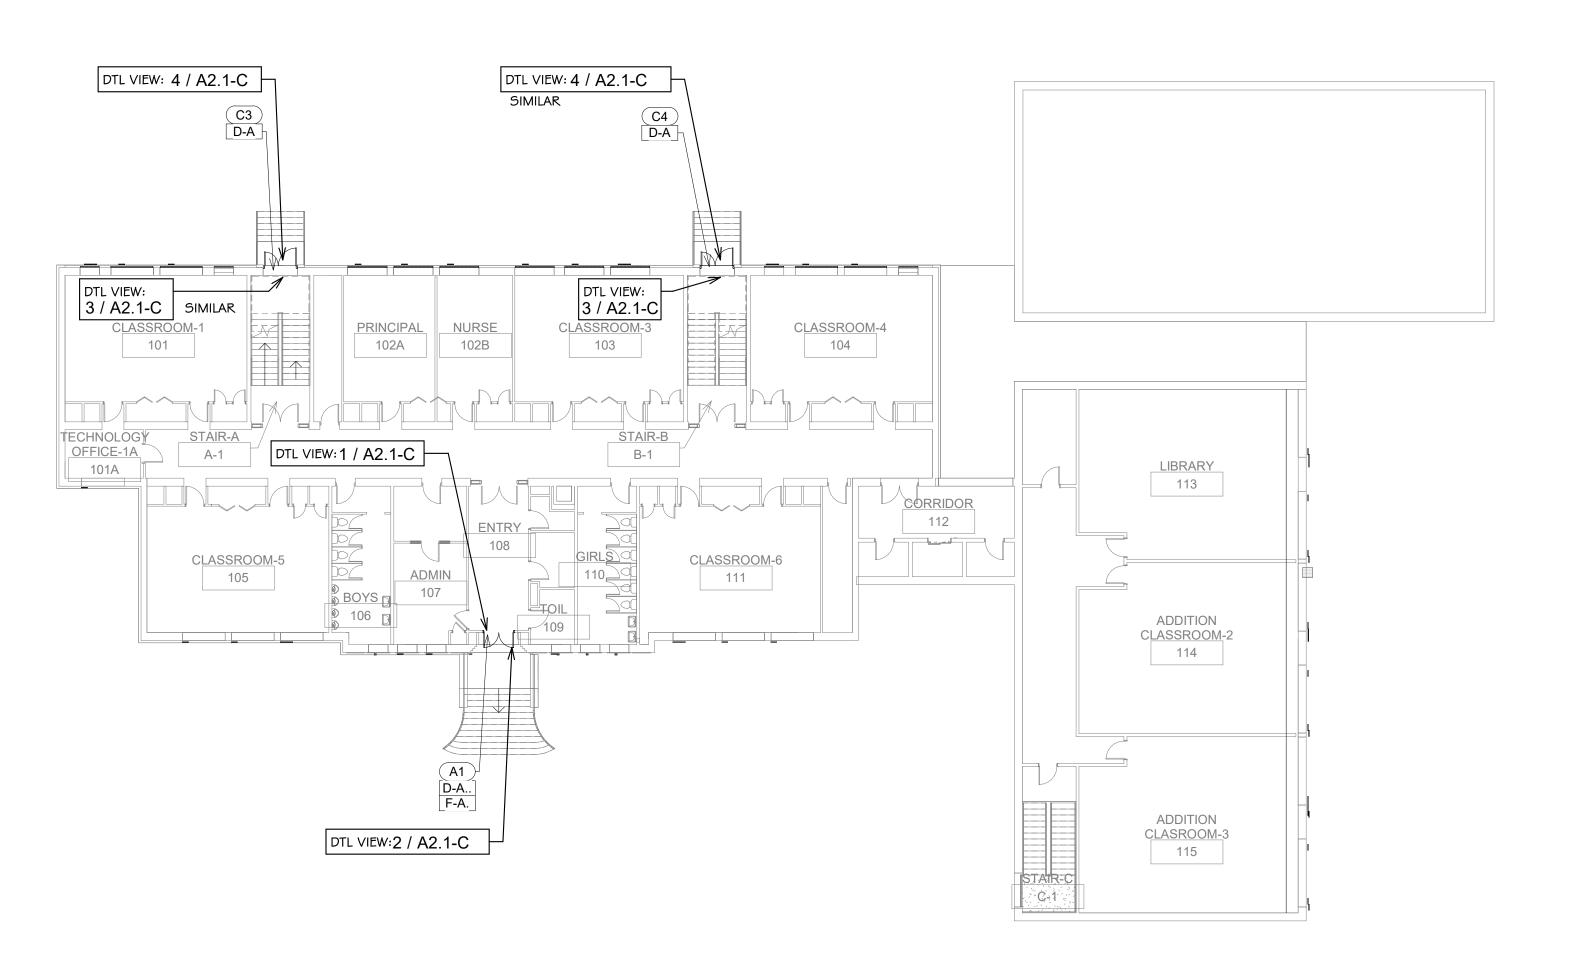

FLOOR PLAN BASEMENT NOS



ROOM NUMBERS
ROOM NUMBERS LISTED IN THE
DRAWINGS ARE FOR REFERENCE
AND DO NOT REFLECT THE ACTUAL
ROOM NUMBERS

HURRICANE RESISTANT

OPAQUE PANEL (OP) FORCED

ENTRY RESISTANT OPAQUE

PANEL (FEOP):

- I. PROVIDE HURRICANE RESISTANT OPAQUE PANELS (OP / FEOP) IN HURRICANE RESISTANT STOREFRONT AND HOLLOW METAL FRAMES.
- 2. CUTS IN HURRICANE RESISTANT OPAQUE PANELS MADE WITH A CARBIDE TIPPED ROTATING SAW BLADE.
- 3. PROVIDE CUTS MINIMUM OF 3" FROM ANY PANEL EDGE.
- 4. ADHESIVE IS THE PREFERRED METHOD OF ATTACHING MATERIALS TO OPAQUE PANELS. DO NOT USE FASTENERS
- 5. PROVIDE ADEQUATE SEAL AROUND CUTOUT, WITH SEALANT AND GASKETING, MOISTURE IS NOT TO PENETRATE.
- 6. SEE MANUFACTURER INFORMATION.

DETAIL:PENETRATIONS
IN OPAQUE PANELS, TYP
3" = 1'-0"

NOTES: Wyman ES

1. SEE DRAWING G1.0 & G1.1 FOR ADDITIONAL NOTES AND LEGENDS
PERTAINING TO THE PROJECT.

2. SEE DWG1 / A2.0-C FOR DOOR AND FRAME SCHEDULE & TYPES.

3. VERIFY EXISTING CONDITIONS IN FIELD. DO NOT DAMAGE OR CUT ANY
STRUCTURAL ELEMENTS. IF CONDITIONS DIFFER TO WHAT IS SHOWN
ON THESE DRAWINGS, NOTIFY ARCHITECT IMMEDIATELY PRIOR TO
COMMENCING WORK.

4. COORDINATE REMOVAL & REINSTALL OF EXIST EQUIPMENT INCLUDING
SECURITY, ELECTRICAL, AND FIRE ALARM. REVIEW SECURITY W/ OWNER
PRIOR TO CONSTRUCTION.

NEW WORK NOTES
A. KEYED NOTES APPLY TO ALL TYPICAL INSTANCES IN PROJECT. FOR
CLARITY SOME DEMOLITION WORK NOTES MAY NOT BE SHOWN.

CONTRACTOR RESPONSIBLE TO VERIFY IN FIELD.

SYSTEM AT EXIST STEEL DOOR LINTELS.

PLAN & ELEV SYMBOLS:

PROVIDE DOOR AND FRAME SYSTEM.

WINDOW SYSTEM. VERIFY EXTENT IN FIELD.

12 WORK KEYNOTE

110 DOOR NUMBER

WORK KEYNOTE LEGEND.

SPECIFIC INFO.

KEYNOTE DESCRIPTION

B. PROVIDE SEALANT AND PAINT SYSTEM AT NEW DOOR SYSTEM.

C. PROVIDE, AT WALL EXTERIOR, EXTERIOR RUST INHIBITING PAINT

D. PROVIDE MASONRY REPAIRS AT OPENINGS PREVENTING DOOR

E. REINSTALL ELECTRICAL AND FIRE ALARM AND SECURITY EQUIPMENT.

DTL VIEW:

PROVIDE PORTION OF DOOR SYSTEM, SEE DOOR SCHEDULE FOR

PROVIDE VCT FLOOR PATCHING ADJACENT TO DOOR AND

3 / A1.0-C

F. PROVIDE HURRICANE OR FORCED ENTRY RESISTANT INSULATED

INSTALL. SEE MASONRY REPAIR INFO AT GENERAL NOTES.

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Cranston, Rhode Island 02910

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METAL OPAQUE PANEL AT THRU DOOR PENETRATIONS, SEE DETAIL

3 / A1.0-C

DETAIL

VIEW

EXTERIOR DOOR UPGRADES

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Robertson
Elementary School
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E.T.Wyman
Elementary School
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Revision Schedule

lumber Revision Date

SHEET TITLE FLOOR PLANS


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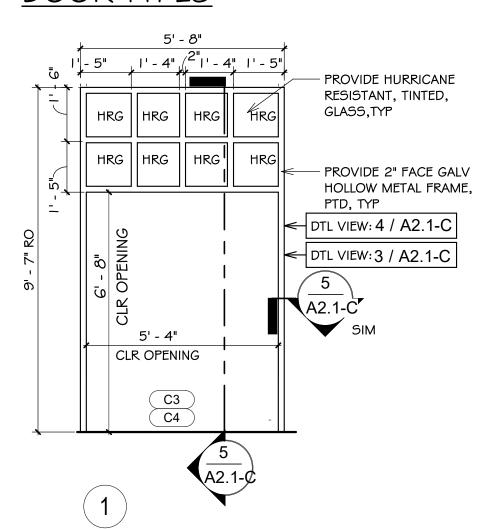
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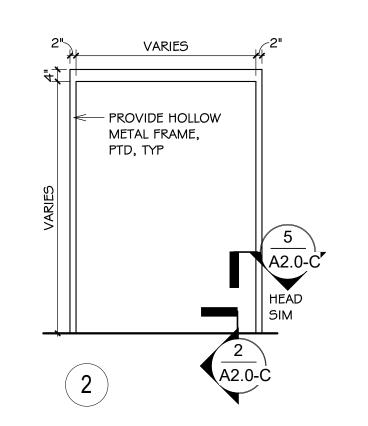
A1.0-C

Wyman ES
SHEET: 12 OF: 14



PROVIDE PTD GALV INSUL HOLLOW METAL DOOR, TYP



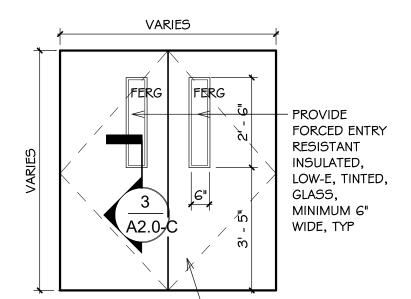

2' - 4 1/2"

FRAME TYPES




DOOR SCHEDULE GENERAL NOTES: PROVIDE AT EACH OPENING LISTED ON THE DOOR AND FRAME SCHEDULE:

- 1. SEE DRAWING G1.0 & G1.2 FOR ADDITIONAL NOTES AND LEGENDS PERTAINING TO THE PROJECT. SEE FRAME TYPES FOR DOOR/FRAME DETAILS AT 1 / A2.0-C
- 2. VERIFY EXISTING CONDITIONS AND DIMENSIONS IN THE FIELD PRIOR TO SHOP DRAWINGS & FABRICATION.
- 3. EXISTING DOORS ON THE DOOR/FRAME SCHEDULE, LEAVE DOOR IN PLACE UNLESS REQUIRED TO PERFORM WORK
- 4. PROVIDE AT EXISTING STEEL LINTELS AND EXISTING H.M. DOORS \$ H.M. FRAMES LISTED ON THE DOOR/FRAME SCHEDULE, INCLUDING EXISTING TO REMAIN DOOR TOP RAIN GUARDS, PREPARE AND PROVIDE A RUST RESISTANT PAINT SYSTEM. PREPARATION TO INCLUDE LIGHT RUST REMOVAL WITH WIRE BRUSH AND SCRAPE. PROVIDE RUST INHIBITING PAINT SYSTEM INCLUDING (1) COAT RUST INHIBITING ACRYLIC PRIMER EQUAL TO "PRO-INDUSTRIAL PRO-CRYL" NUMBER BG6-1300 AND (2) COATS RUST INHIBITING ACRYLIC FINISH EQUAL TO "PRO-INDUSTRIAL DTM ACRYLIC" NUMBER BG6-1150, BY SHERWIN WILLIAMS, COLOR SELECTED BY
- 5. PROVIDE HOLLOW METAL DOORS AND HOLLOW METAL FRAMES, ON THE DOOR/FRAME SCHEDULE, TO BE GALVANIZED.
- 6. PROVIDE HOLLOW METAL DOORS, ON THE DOOR/FRAME SCHEDULE, TO BE INSULATED.
- 7. NEW AND EXISTING DOOR SYSTEMS ON THE DOOR/FRAME SCHEDULE, PROVIDE WEATHER STRIPPING, INSTALLED WITH STAINLESS STEEL SCREWS, SET IN BED OF SEALANT, INCLUDING DOOR BOTTOM RAIN DRIP W/ RUBBER GASKET EQUAL TO PEMKO 3452DPK. REMOVE & DISPOSE EXISTING WEATHER STRIPPING.
- 8. PROVIDE FORCED ENTRY AND / OR HURRICANE RESISTANT INSULATED OPAQUE METAL PANELS (FEOP / OP) I "THICK AT HM DOORS, HM FRAMES, EQUAL TO MAPESHIELD, BY MAPES, FACTORY FINISHED. INSTALL TO MEET CODE AND MEET MANUFACTURERS REQUIREMENTS. COLOR SELECTED BY ARCHITECT. REFER TO SIMILAR DETAIL AT 3 / A2.0-C
- 9. PROVIDE FORCED ENTRY RESISTANT GLASS (FERG) AND HURRICANE RESISTANT GLASS (HRG) PER DOOR / FRAME SCHEDULE AND DOOR / FRAME TYPES, I" THICK AT HM DOORS, HM FRAMES, EXIST STOREFRONT, INSULATED, TEMPERED AS REQUIRED, MINIMUM WIDTH OF VISION LITES 6", GRAY TINT EQUAL TO GUARDIAN CRYSTAL GRAY COLOR OR VITRO OPTIGRAY COLOR, LOW-E (#2) EQUAL TO GUARDIAN SN68 OR SOLARBAN 70 PROPERTIES, FERG INTER LAYER EQUAL TO SCHOOL GUARD GLASS SG5 OR OLD CASTLE ARMORPROTECT PLUS 121000, HRG INTER LAYER EQUAL TO 0.060 PVB OR SGP. COLORS SELECTED BY ARCHITECT. GLASS TO BE INSTALLED TO MEET CODE AND MANUFACTURERS REQUIREMENTS, SEE DETAIL 3 / A2.0-C
- IO. PROVIDE REPAIRS TO EXISTING FLASHING TO REMAIN. BEND UP EXIST FLASHING DURING DEMOLITION. IN NEW WORK PROVIDE PATCHING AND REPAIRS TO EXIST FLASHING WITH MATCHING MATERIALS, AS REQ'D, POP RIVET NEW TO OLD. BEND EXISTING FLASHING BACK DOWN AT END OF PROJECT
- II. REMOVE & DISPOSE EXIST VCT, AS REQ'D, TO INSTALL NEW WORK AND DAMAGED EXIST TILES ADJACENT TO DOOR, VERIFY IN FIELD. PROVIDE VINYL COMPOSITION TILE MATCHING EXISTING, INCLUDE PORTION OF A TILE AND ONE FULL TILE THE WIDTH OF THE DOOR OPENING.
- SEE DETAIL 2 / A2.0-C
- ARDEX TWP AND ARDEX EP 2000 (C) ABATRON ABOWELD 55-1 AND ABATRON PRIMKOTE 8006-1. CONCRETE MASONRY WALL REPAIR BASIS OF DESIGN "TEK 08-01A: MAINTENANCE OF CONCRETE MASONRY WALLS" BY NATIONAL CONCRETE MASONRY ASSOCIATION (NCMA.ORG), BRICK MASONRY WALL REPAIR BASIS OF DESIGN "TECHNICAL NOTE 46: MAINTENANCE OF BRICK MASONRY" # "TECHNICAL NOTE 7: WATER PENETRATION RESISTANCE - DESIGN AND DETAILING" BY BRICK INDUSTRY ASSOCIATION (WWW.GOBRICK.COM). AT 1930'S BUILDING PROVIDE HISTORIC MORTAR AT MASONRY WALL REPAIRS.
- 14. PROVIDE AIR AND WATER SEALING AT EXTERIOR ENVELOPE, INSULATION FILL AT SHIM SPACES OF LOW PRESSURE FOAM EQ TO DOW GREAT STUFF PRO WINDOW \$ DOOR, SEALANT SYSTEM AT FRAME TO MASONRY AND THRESHOLD TO SILL, SILICONE SEALANT # BACKER ROD EQ TO DOWSIL-795 OR SPECTRUM-2. COLORS SELECTED BY ARCHITECT
- 15. PROVIDE WIRE MOULD SYSTEM, AS REQUIRED, AT DOOR ELECTRIC TWO POINT LATCHING. PROVIDE ELECTRIC ARMORED LOOP BETWEEN FRAME AND DOOR, AS REQUIRED. MOUNT CARD READER 3'-O" TO 4'-O" ABOVE GRADE. SCHOOL TO PROVIDE AND INSTALL CARD READER AND FINAL ELECTRIC CONNECTIONS. GC COORDINATE WITH SCHOOL PRIOR TO CONSTRUCTION.
- 16. PROVIDE, AT EXIST HM FRAMES TO REMAIN, REPAIRS INCLUDING GALV PLATE INFILL SCREWED IN AT REMOVED BUTT HINGES, PROVIDE 3M-BONDO SYSTEM OVER PATCH PLATE PRIOR TO RUST INHIBITING PAINT
- 17. PROVIDE, AT EXTERIOR ENVELOPE, PRESSURE TREATED WOOD TREATED WITH MICRONIZED COPPER AZOLE (MCA) OR EQUAL AS NOTED IN THE ICC-ES REPORT "ESR-1721" LATEST VERSION. WOOD TREATMENT SYSTEM TO BE COMPLIANT WITH BUILDING CODE AND RIDE REQUIREMENTS. SEPARATE TREATED WOOD FROM METAL WITH SELF ADHERING MEMBRANE, EQUAL TO HENRY "BLUESKIN BUTYL FLASH" COMPATIBLE WITH PROJECT
- 18. ASBESTOS HAS BEEN IDENTIFIED IIN THE SCHOOL, REFER TO THE ASBESTOS REPORT IN THE SPECIFICATIONS SECTION 003 | 19. NOTIFY THE ARCHITECT IMMEDIATELY OF ANY ADDITIONAL ASBESTOS FOUND.

DOOR SCHEDULE REMARKS:

I. PROVIDE EQUAL PAIR OF DOORS

- 2. PROVIDE UN-EQUAL PAIR OF DOORS. 3-0" DOOR TO BE THE ACTIVE DOOR.
- 3. PROVIDE ELECTRONIC LATCH SYSTEM. PROVIDE WIRING THRU THE FRAME OR SURFACE MOUNTED IN WIRE MOULD, AS REQUIRED, AND PROVIDE ARMORED DOOR LOOP, AS REQ'D
- 4. PROVIDE WEATHER STRIPPING AT EXIST DOORS AND SURFACE APPLIED DOOR BOTTOM RAIN DRIP W/ RUBBER GASKET EQ TO PEMKO 3452-DPK
- 5. PROVIDE DOOR AND HARDWARE AT EXISTING FRAME.
- 6. PROVIDE FRAME PATCHING, INFILL AT REMOVED EXIST BUTT HINGES WITH SCREWED IN GLAV STL PLATES, PROVIDE 3M-BONDO SYSTEM OVER PATCH PRIOR TO RUST INHIBITING PAINT SYSTEM
- 7. EXISTING DOOR AND FRAME TO REMAIN.
- 8. PROVIDE DOOR TOP RAIN GUARD. PROVIDE SEALANT, SET IN BED OF SEALANT. SEE DTL 5 / A2.1-C
- 9. REFER TO THE DOOR AND FRAME TYPES FOR DETAILS AT 1 / A2.0-C
- 10. PROVIDE THRESHOLD, SEE DETAIL 2 / A2.0-C
- II. DOOR AI: PROVIDE ELECTRIC TWO POINT LATCHING PANIC BAR, RIGHT DOOR ACTIVE AS VIEWED FROM EXTERIOR. PROVIDE PULL HANDLE AT RIGHT DOOR. CONNECT TO EXIST WIRING. INTERIOR AND EXTERIOR WOOD TRIM TO REMAIN. PROVIDE FRAME SIZE, DEPTH, AND INSTALL MATCHING EXISTING. PROVIDE WIRE MOULD, AS REQUIRED. SEE DETAILS 1 / A2.1-C # 2 / A2.1-C
- 12. DOOR C3: PROVIDE ELECTRIC TWO POINT LATCHING PANIC BAR, LEFT DOOR ACTIVE AS VIEWED FROM EXTERIOR. PROVIDE PULL HANDLE AT LEFT DOOR. CONNECT TO EXIST WIRING. INTERIOR WOOD TRIM AT DOOR AND TRANSOME LITE TO REMAIN, REFASTEN, AS REQUIRED, PROVIDE INTERIOR WOOD PAINT SYSTEM. REMOVE \$ DISPOSE EXTERIOR WOOD TRIM AND TRANSOM LITE AND FRAME AND EXIST HM DR & FRM. PROVIDE HM FRAME AND DOOR AND TRANSOM LITE. PROVIDE WIRE MOULD, AS REQUIRED. SEE DETAILS 3 / A2.1-C # 4 / A2.1-C
- 13. DOOR C4: PROVIDE TWO POINT LATCHING PANIC BAR, LEFT DOOR ACTIVE AS VIEWED FROM EXTERIOR. PROVIDE PULL HANDLE AT LEFT DOOR. INTERIOR WOOD TRIM AT DOOR AND TRANSOME LITE TO REMAIN, REFASTEN, AS REQUIRED, PROVIDE INTERIOR WOOD PAINT SYSTEM. REMOVE & DISPOSE EXTERIOR WOOD TRIM AND TRANSOM LITE AND FRAME AND EXIST HM DR & FRM. PROVIDE HM FRAME AND DOOR AND TRANSOM LITE. PROVIDE WIRE MOULD, AS REQUIRED. SEE DETAILS 3 / A2.1-C 4 / A2.1-C
- 14. DOOR C5: PROVIDE ELECTRIC TWO POINT LATCHING PANIC BAR, RIGHT DOOR ACTIVE AS VIEWED FROM EXTERIOR. PROVIDE PULL HANDLE AT EXTERIOR. CONNECT TO EXIST WIRING. REMOVE # DISPOSE ALUM DOOR AND FRAME. PROVIDE WIRE MOULD, AS REQUIRED. SEE DETAILS 6 / A2 1-C.
- 15. DOOR CG: PROVIDE ELECTRIC TWO POINT LATCHING PANIC BAR, RIGHT DOOR ACTIVE AS VIEWED FROM EXTERIOR. PROVIDE PULL HANDLE T EXTERIOR. PROVIDE HM DOOR IN EXIST FRAME. PROVIDE WIRE MOULD AND ARMORED LOOP, AS REQUIRED. PROVIDE WIRING HOLE IN MASONRY, SEE PLANS FOR LOCATION, AIR SEAL.
- 16. DOOR D7: PROVIDE TWO POINT LATCHING PANIC BAR, RIGHT DOOR ACTIVE AS VIEWED FROM EXTERIOR. PROVIDE HM DOOR IN EXIST HM FRAME.
- 17. DOOR BII: PROVIDE ELECTRIC TWO POINT LATCHING PANIC BAR, LEFT DOOR ACTIVE AS VIEWED FROM EXTERIOR. PROVIDE EXTERIOR LEVER HANDLE AT LEFT DOOR. PROVIDE WIRE MOULD AND ARMORED LOOP, AS REQUIRED. PROVIDE WIRING HOLE IN MASONRY, SEE PLANS FOR LOCATION, AIR SEAL.

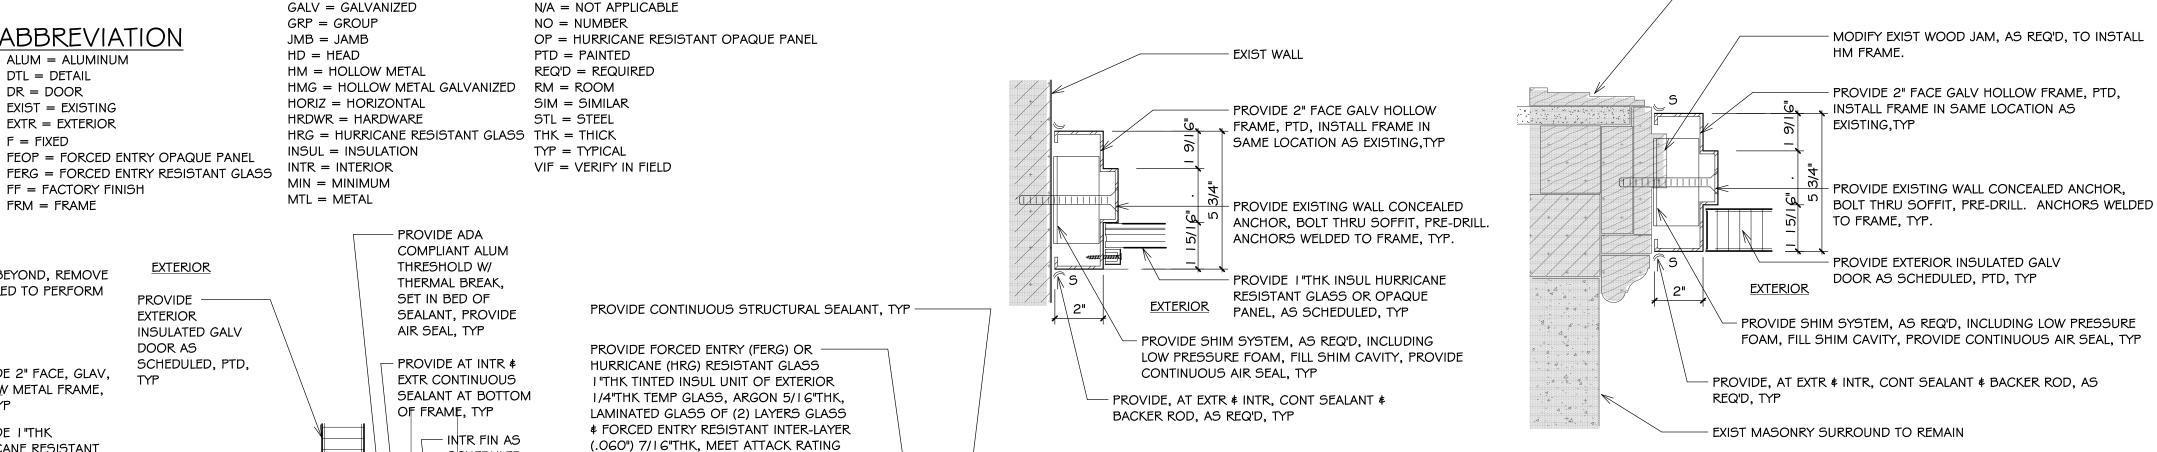

SECT:HOLLOW METAL

FRAME, TYP

3' - 1" **INSULATED GALV** DOOR AS SCHEDULED, PTD, PROVIDE 2" FACE, GLAV, _HOLLOW METAL FRAME, - PROVIDE I "THK HURRICANE RESISTANT SCHEDULED, INSUL TINTED GLASS, PROVIDE AT BOTTOM PATCH AS TEMPERED AS REQ'D,TYP OF DOORS LISTED REQ'D, TYP ON DR/FRM SCHEDULE, A SURFACE APPLIED DOOR BOTTOM RAIN 5'-11". DRIP WITH NYLON CLR OPENING BRUSH EQ TO PEMKO - REINSTALL OF EXIST 3452-NB, UNLESS CARD READER NOTED OTHERWISE SYSTEM. SET IN BED OF SEALANT, TYP

PROVIDE

EXTERIOR

ABBREVIATION

ALUM = ALUMINUM

EXIST = EXISTING

EXTR = EXTERIOR

FRM = FRAME

FF = FACTORY FINISH

DTL = DETAIL

DR = DOOR

F = FIXED

LINE OF EXIST CEILING BEYOND, REMOVE

\$ REINSTALL AS REQUIRED TO PERFORM

WORK,TYP

- PROVIDE I "THK FORCED ENTRY RESISTANT INSUL TINTED GLASS,TYP

- PROVIDE I" THK FORCED ENTRY RESISTANT ALUM, INSUL, OPAQUE MTL PANEL ,TYP

EDGE OF EXIST - PROVIDE PATCHING AND CONC, TYP RE-FORMING OF EXIST CONC SILL, FILL HOLES \$ EXIST METAL ANGLE, CRACKS EQUAL TO MODIFY, CUT, GRIND, CHIP PATCHING CONCRETE: AWAY, AS REQ'D TO SIKAQUICK VOH, INSTALL NEW THRESHOLD, TYP PRIMER: SIKADUR 32-HI-MOD, AS REQ'D, TYP

PROVIDE GALVANIZED INSULATED HOLLOW METAL DOOR, PTD, TYP SECT:HOLLOW METAL DOOR LITE TRIM, TYP

5AAL-12 MIN OR ASTM F1233 CLASS

1.4, HURRICANE RATING ASTM E1886 /

E1996 OR TAS-201 / 203, TYP

PROVIDE INSTALL PER GLASS

MANUFACTURERS REQUIREMENTS,

PROVIDE CONTINUOUS SEALANT, TYP

PROVIDE GALVANIZED H.M. FORCED ENTRY RESISTANT LITE KIT, PTD, TYP


PROVIDE CONTINUOUS STRUCTURAL

TO DOWSIL 995, TYP

ATTACHMENT OF LITE KIT TO DR, EQUAL

EXTERIOR

MINIMUM GLASS WIDTH 6", TYP

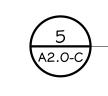

SECT:DR A I JAMB, TYP

NOTES: Wyman ES . SEE DRAWING GI.O & GI.I FOR ADDITIONAL NOTES AND LEGENDS PERTAINING TO THE PROJECT.

EXIST WOOD TRIM TO REMAIN

- 2. SEE DWG 1 / A2.0-C FOR DOOR AND FRAME SCHEDULE & TYPES
- 3. VERIFY EXISTING CONDITIONS IN FIELD. DO NOT DAMAGE OR CUT ANY STRUCTURAL ELEMENTS. IF CONDITIONS DIFFER TO WHAT IS SHOWN ON THESE DRAWINGS, NOTIFY ARCHITECT IMMEDIATELY PRIOR TO COMMENCING WORK.
- . COORDINATE REMOVAL & REINSTALL OF EXIST EQUIPMENT INCLUDING SECURITY, ELECTRICAL, AND FIRE ALARM. REVIEW SECURITY W/ OWNER PRIOR TO CONSTRUCTION.

A2.0-C

Wyman ES SHEET: 13 OF: 14

Saccoccio &

1085 Park Avenue

02910

Consultant

Cranston, Rhode Island

Associates, Inc.

EXTERIOR DOOR

UPGRADES

Elementary School

55 Glenwood Drive, Warwick, RI 02889

Robertson

Elementary Schoo

70 Nausaket Road, Warwick, RI 02886

E.T.Wyman

Elementary School

1 Columbia Avenue, Warwick, RI 02888

Revision Schedule

Revision Date

Number

SHEET TITLE

DOOR & FRAME

SCHEDULE,

DOOR TYPES,

FRAME TYPES,

DETAILS

RITTEN CONSENT FROM THE ARCHITECT IS PROHIBITED.

DRAWN BY: DA, KC JOB NUMBER:

CHECKED BY: SG DATE:

tel 401.942.7970

fax 401.942.7975

DOOR AND FRAME TYPES A2.0-C

 $\begin{pmatrix} 2 \\ A2.0-C \end{pmatrix}$

SECT:THRESHOLD, TYP

